POWELL RESIDENCE

KANE ST.

SITE DEVELOPMENT PERMIT

SAN DIEGO, CALIFORNIA

LEGAL OWNER:

MR. JON POWELL 2343 GARFIELD RD. SAN DIEGO, CA 92110 TEL: (858) 414-6444

PROJECT TEAM:

DESIGNER:

BALLERINO DESIGN ASSOCIATES 416 W. SAN YSIDRO BLVD., #L-2207 SAN YSIDRO, CA 92173 CONTACT: DOMINIC BALLERINO DOMINIC@BALLERINODESIGN.COM

CIVIL ENGINEER:

KAPPA SURVEYING & ENGINEERING 8402 N. MAGNOLIA AVE. SUITE C SANTEE, CA 92071 TEL. (619) 449-2600 CONTACT: BILL DICK, PLS

LANDSCAPE DESIGN:

BOTANICA LANDSCAPE DESIGN TEL. (619) 379-6044 WWW.BOTANICADESIGN.COM CONTACT: PELLON LAY

GEOTECHNICAL ENGINEER:

TERRAPACIFIC CONSULTANTS INC. 4010 MORENA BLVD. SUITE 108 SAN DIEEGO, CA 92117 TEL. (858) 521-119Ø CONTACT: CHRISTOPHER O'HERN

GENERAL CONTRACTOR:

OWNER-BUILDER

Garfield Rd. & Kane St

Project Data Scope of Work Abbreviations Symbols Sheet Index PROJECT CODE INFORMATION: CONSTRUCTION OF I NEW RESIDENTIAL UNIT & ADU SHEET TITLE: <u>SHT. NO.:</u> TYPE OF CONSTRUCTION: TYPE V-B TITLE SHEET KEYNOTE REFERENCE 1. (N) 3-STORY RESIDENCE. TYPE OF OCCUPANCY: SP.1 SITE PLAN F.O.M. FACE OF MASONRY A/C AIR CONDITIONING BUILDING CODE: CBC 2019, CRC 2019 2. (N) ADU (FIRST LEVEL) F.O.S. FACE OF STUD ASPHALTIC CONCRETE LANDSCAPE DEVELOPMENT PLAN A.F.F. ABOVE FINISH FLOOR GOVERNING AGENCY: CITY OF SAN DIEGO F.S. FINISH SURFACE BRUSH MANAGEMENT PLAN INTERIOR ELEVATION 2. SITE IMPROVEMENTS INCLUDING NEW LANDSCAPING, RS-1-7 LANDSCAPE DEVELOPMENT PLAN NOTES ALUM. ALUMINUM ZONING: L-3 AND RETAINING WALLS. DIRECTION OF WALLS GALYANIZED IRON A.S.R. AUTOMATIC SPRINKLER RISER N/A YEAR CONSTRUCTED: WALL NUMBER M.O. MASONRY OPENING FLOOR PLAN - FIRST LEVEL Ø.53 (6,32Ø S.F.) F.A.R. (ALLOWED): **A-**2 FLOOR PLAN - SECOND LEVEL MTR. METER BLK. BLOCK A-3 FLOOR PLAN - THIRD LEVEL Ø.32 (3,815 S.F.) F.A.R. (PROPOSED) BLDG. BUILDING N.I.C. NOT IN CONTRACT EXTERIOR MATERIAL COVERAGE: 50% MAX. PLAN CHANGE/BULLETIN EXTERIOR ELEVATIONS COLOR REFERENCE FLOOR AREAS: N.T.S. NOT TO SCALE 24' / 3*0*' MAX. HEIGHT: EXTERIOR ELEVATIONS CATCH BASIN EXTERIOR ELEVATIONS CONTROL JOINT OVER CENTER LINE O.C. ON CENTER TENTATIVE PARCEL MAP SQUARE FOOTAGE SUMMARY CEILING O.D. OVERFLOW DRAIN GRADING & DRAINAGE (N) SINGLE FAMILY RESIDENCE: APPLICABLE BUILDING CODES: CLR. CLEAR O.S. OVERFLOW SCUPPER C-2 TYP. CROSS SECTIONS DETAIL REFERENCE IST LEVEL: 1,056 SF COL. COLUMN OPP. OPPOSITE TYP. CROSS SECTIONS 2019 CALIFORNIA BUILDING CODE 580 SF SLOPE ANALYSIS CONC. CONCRETE 2019 CALIFORNIA RESIDENTIAL CODE GARAGE: 476 SF BMP TABLES P.L. PROPERTY LINE C-5 CONT. CONTINUOUS 2019 CALIFORNIA ELECTRICAL CODE 2ND LEVEL: 1,604 SF EROSION CONTROL P.O.C. POINT OF CONNECTION 2019 CALIFORNIA MECHANICAL CODE C.T. CERAMIC TILE 1,155 SF 3RD LEVEL 2019 CALIFORNIA PLUMBING CODE 2019 CALIFORNIA FIRE CODE -----------D.S. DOWN SPOUT R.D. ROOF DRAIN **Vicinity Map** TOTAL (OVERALL): 2019 CALIFORNIA GREEN BUILDING STANDARDS CODE (CALGREEN) 2019 CALIFORNIA BUILDING ENERGY EFFICIENCY STANDARDS E.D.F. ELECTRIC DRINKING FOUNTAIN E.J. EXPANSION JOINT T.C. TOP OF CONCRETE LEGAL DESCRIPTION: E.W.C. ELECTRIC WATER COOLER NEAREST BUS STOP — TOP OF MASONRY CLAIREMONT DR. 4 EXP. EXPOSED TOP OF PARAPET HARTFORD CT. SITE ADDRESS: T.S. TOP OF SHEATHING (DISTANCE = 2500 FT.) FLOOR DRAIN 0000 KANE ST. TYP. TYPICAL FINISH GRADE SAN DIEGO, CA 92110 CLAIREMONT DR PARKING SUMMARY: W/ WITH ASSESSOR'S PARCEL NUMBER FIN. FINISH W.H. WATER HEATER (N) SINGLE FAMILY RESIDENCE: 000-000-00-00 FLR. FLOOR WTR. WATER 2 STALLS REQUIRED PROVIDED 2 STALLS (GARAGE) LOT SIZE: 11,925 S.F. (N) A.D.U. REQUIRED EXEMPT PROVIDED Project No.: KANE ST MILTON ST

Project Title: **POWELL RESIDENCE**

> Development Permit (S.D.P.)

San Diego, CA


SDP/TM PLANCHECK CORRECTIONS A 05.16.2022 SDP/TM RE-SUBMITTAL 04.21.2023 SDP/TM RE-SUBMITTAL 10.05.2023 SDP/TM RE-SUBMITTAL 12.08.2023 SDP/TM RE-SUBMITTAL 05.10.2024 SDP/TM RE-SUBMITTAL 08.15.2024 SDP/TM RE-SUBMITTAL 10.11.2024

Title Sheet

Signatures:

Drawings Prepared By

20019 Checked By: DB 08.01.2021

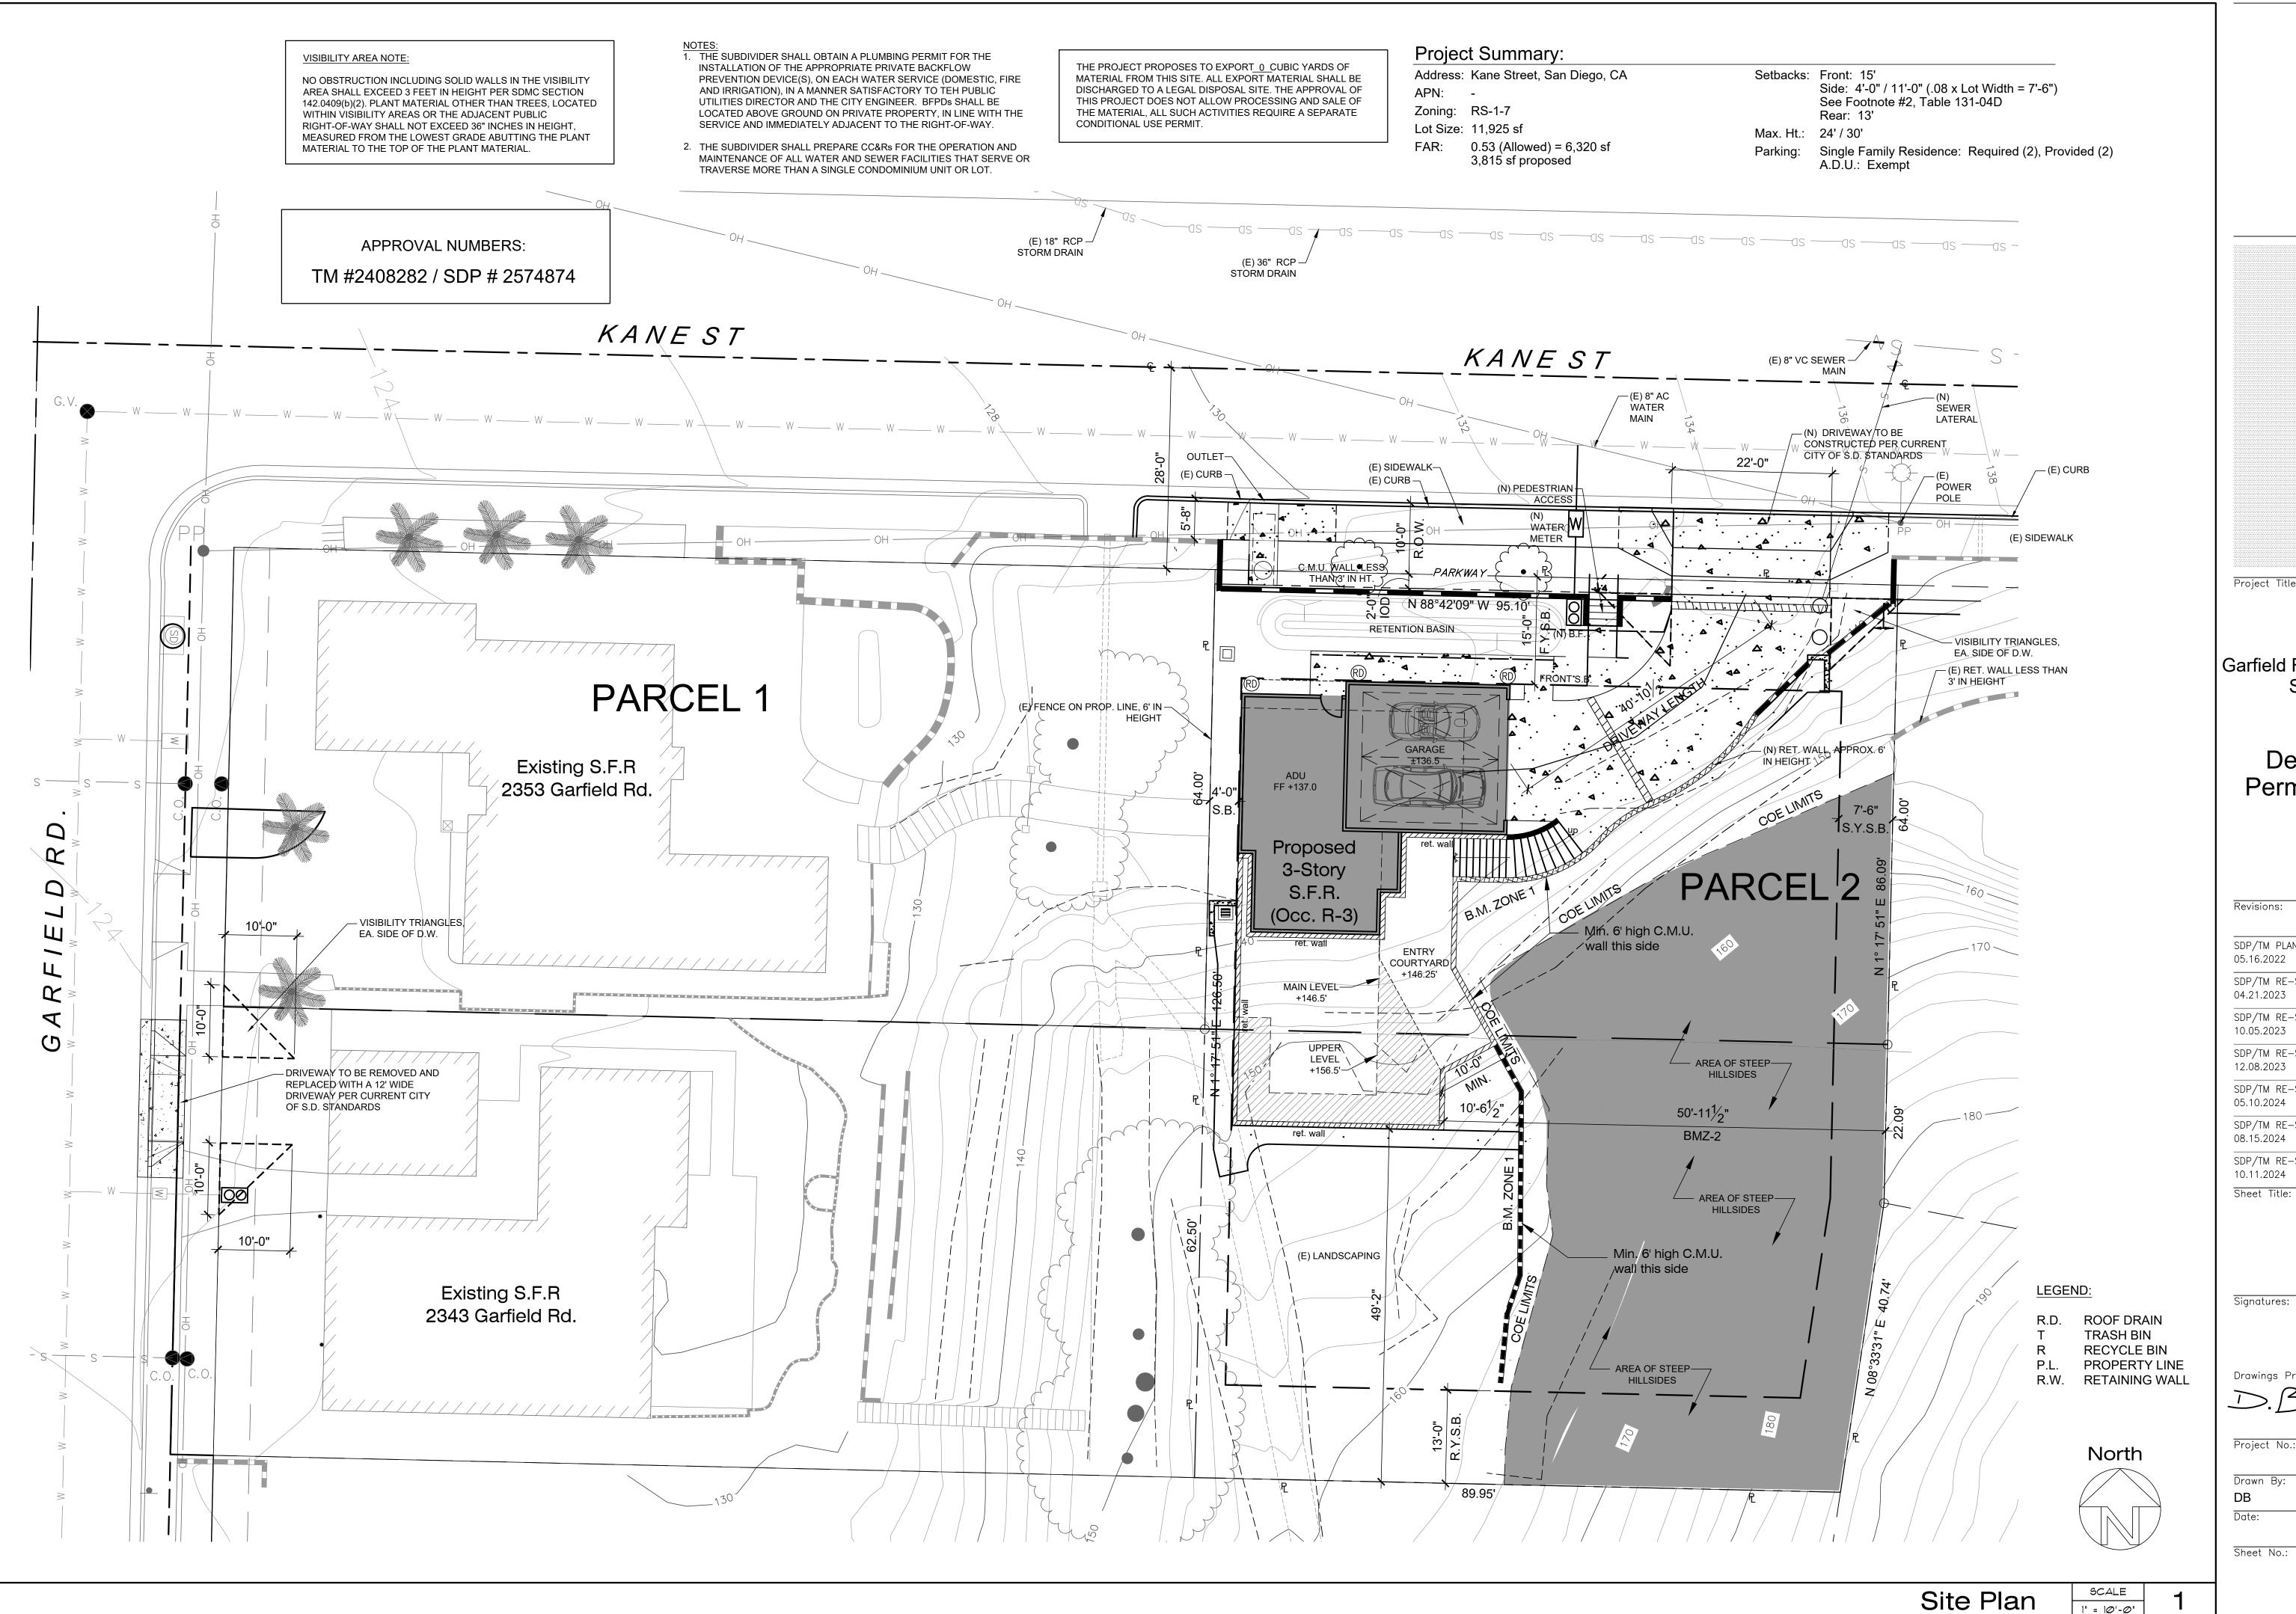

POWELL RESIDENCE Garfield Rd. & Kane St. San Diego, CA

> Development Permit (S.D.P.)

Revisions: SDP/TM PLANCHECK CORRECTIONS A 05.16.2022 SDP/TM RE-SUBMITTAL 04.21.2023 SDP/TM RE-SUBMITTAL 10.05.2023 SDP/TM RE-SUBMITTAL 12.08.2023 SDP/TM RE-SUBMITTAL 05.10.2024 SDP/TM RE-SUBMITTAL 08.15.2024 SDP/TM RE-SUBMITTAL 10.11.2024

Site Plan


Signatures:

Drawings Prepared By:

Project No.: 20019 Checked By:

08.01.2021

SP.1

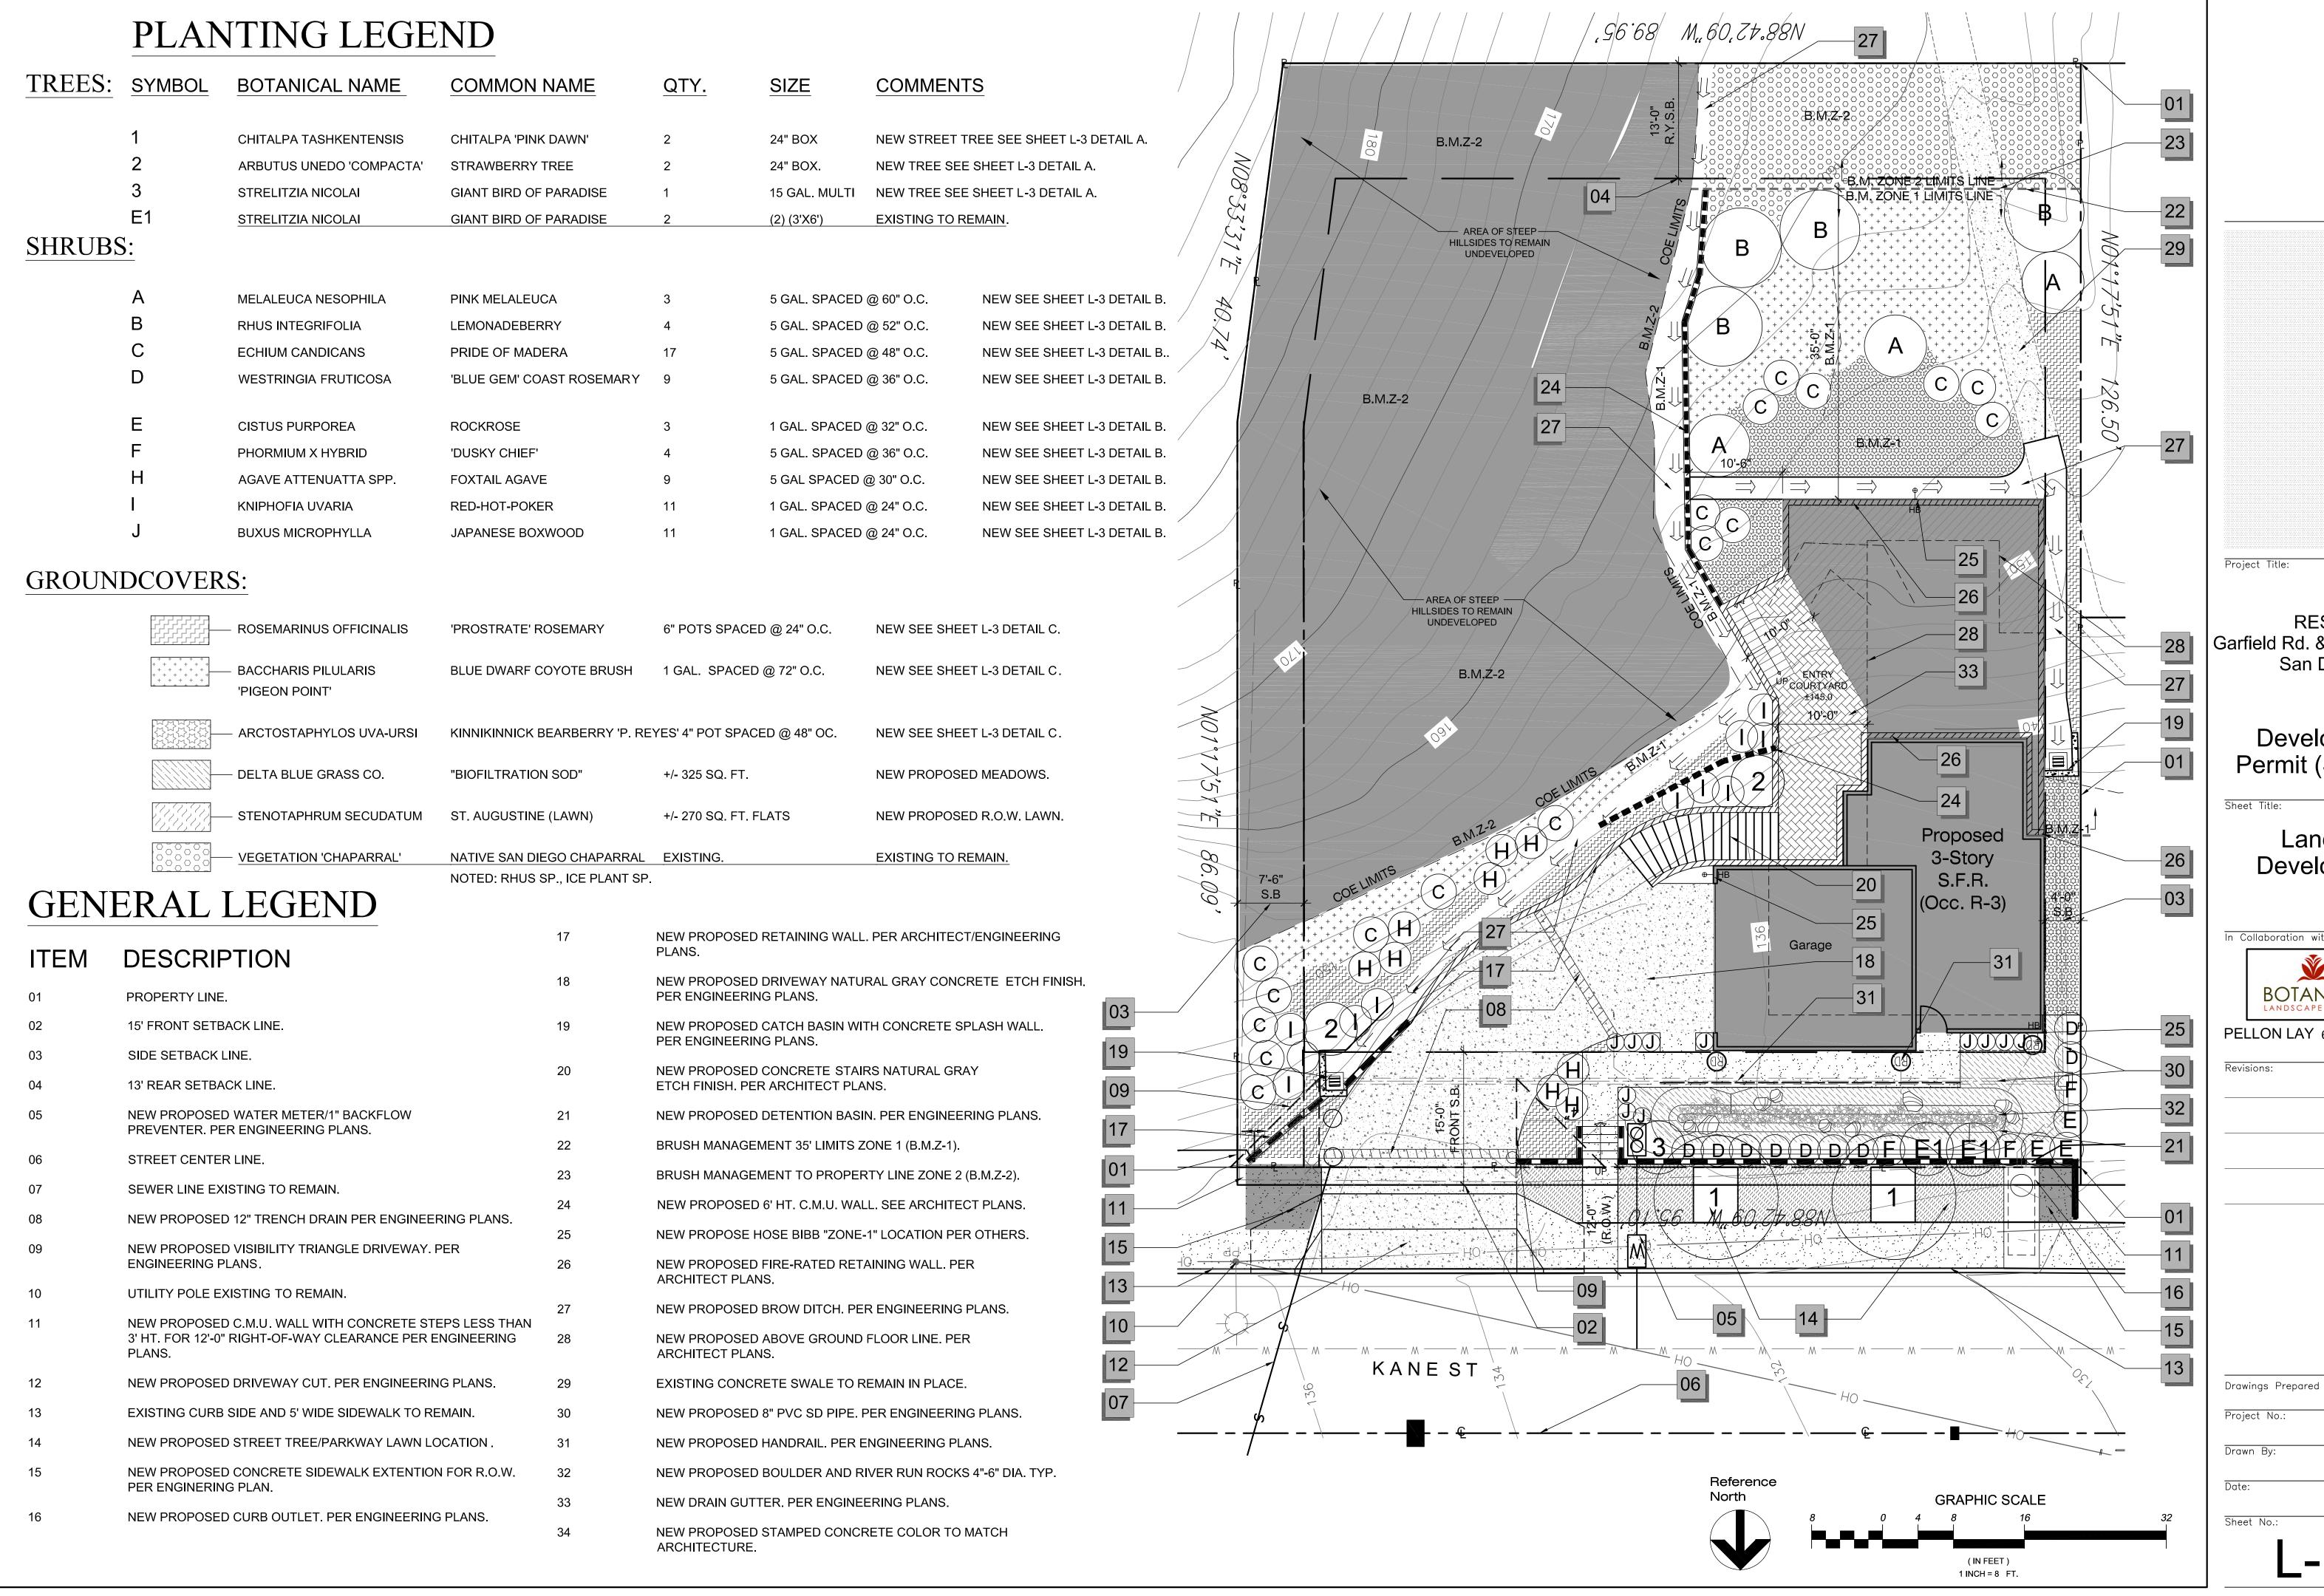

POWELL RESIDENCE Garfield Rd. & Kane St. San Diego, CA

> Site Development Permit (S.D.P.)


Landscape Development Plan

In Collaboration with: BOTANICA LANDSCAPE DESIGN

PELLON LAY 619.379.6044

Drawings Prepared By: 2215 Checked By:

11.27.2024

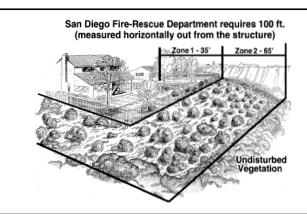

(F) THE ZONE TWO WIDTH MAY BE DECREASED BY 1-1/2 FEET FOR EACH 1 FOOT OF INCREASE IN ZONE ONE WIDTH.

(G) ZONE ONE REQUIREMENTS:

(1) THE REQUIRED ZONE WIDTH SHALL BE PROVIDED BETWEEN NATIVE OR NATURALIZED VEGETATION AND ANY STRUCTURE AND SHALL BE MEASURED FROM THE EXTERIOR OF THE STRUCTURE TO THE VEGETATION.

(2) ZONE ONE SHALL CONTAIN NO HABITABLE STRUCTURES, STRUCTURES THAT ARE DIRECTLY ATTACHED TO HABITABLE STRUCTURES, OR OTHER COMBUSTIBLE CONSTRUCTION THAT PROVIDES A MEANS FOR TRANSMITTING FIRE TO THE HABITABLE STRUCTURES. STRUCTURES SUCH AS FENCE, WALLS, PALAPAS, PLAY STRUCTURES, AND NON-HABITBLE GAZEBO THAT ARE LOCATED WITHIN BRUSH MANAGEMENT ONE SHALL BE OF NON-COMBUSTABLE, ONE HOUR FIRE-RATED OF HEAVY TIMBER CONSTRUCTION.

(3) PLANTS WITHIN ZONE ONE SHALL BE PRIMARILY LOW-GROWING AND LESS THAN 4 FEET IN HEIGHT WITH THE EXCEPTION OF TREES. PLANTS SHALL BE LOW-FUEL AND FIRE-RESISTANCE.

(4) TREES WITHIN ZONE ONE SHALL BE LOCATED AWAY FROM STRUCTURES TO A MINIMUM DISTANCE OF 10 FEET AS MEASURED FROM THE STRUCTURES TO THE DRIP LINE OF THE TREE AT MATURITY IN ACCORDANCE WITH THE LANDSCAPE STANDARDS OF THE LAND DEVELOPMENT MANUAL.

(5) PERMANENT IRRIGATION IS REQUIRED FOR ALL PLANTING AREAS WITHIN ZONE ONE EXCEPT AS FOLLOWS:

(A) WHEN PLANTING AREAS CONTAIN ONLY SPECIES THAT DO NOT GROW TALLER THAN 24 INCHES IN HEIGHT, OR

(B) WHEN PLANTING AREAS CONTAIN ONLY NATIVE OR NATURALIZED SPECIES THAT ARE NOT SUMMER-DORMANT AND HAVE A MAXIMUM HEIGHT AT PLANT MATURITY OF LESS THAN 24 INCHES.

(6) ZONE ONE IRRIGATION OVERSPRAY AND RUNOFF SHALL NOT BE ALLOWED INTO ADJACENT AREAS OF NATIVE OR NATURALIZED VEGETATION.

(7) ZONE ONE SHALL BE MAINTAINED ON A REGULAR BASIS BY PRUNING AND THINNING PLANTS, CONTROLLING WEEDS, AND MAINTAINING IRRIGATION SYSTEMS.

(H) ZONE TWO REQUIREMENTS

(1) THE REQUIRED ZONE TWO WIDTH SHALL BE PROVIDED BETWEEN ZONE ONE AND THE UNDISTURBED, NATIVE OR NATURALIZED VEGETATION, AND SHALL BE MEASURED FROM THE EDGE OF ZONE ONE THAT IS FARTHEST FROM THE HABITABLE STRUCTURE, TO THE EDGE OF UNDISTURBED VEGETATION.

(2) NO STRUCTURES SHALL BE CONSTRUCTED IN ZONE TWO.

(3) WITHIN ZONE TWO, 50 PERCENT OF THE PLANTS OVER 24 INCHES IN HEIGHT SHALL BE CUT AND CLEARED TO HEIGHT OF 6 INCHES.

(4) WITHIN ZONE TWO, ALL PLANTS REMAINING AFTER 50 PERCENT ARE REDUCED IN HEIGHT, SHALL BE PRUNED TO REDUCE FUEL LOADING IN ACCORDANCE WITH THE LANDSCAPE STANDARDS IN THE LAND DEVELOPMENT MANUAL. NON-NATIVE PLANTS SHALL BE PRUNED BEFORE NATIVE ARE PRUNED

(5) THE FOLLOWING STANDARDS SHALL BE USED WHERE ZONE TWO IS IN AN AREA PREVIOUSLY GRADED AS PART OF LEGAL DEVELOPMENT ACTIVITY AND IS PROPOSED TO BE PLANTED WITH NEW PLANT MATERIAL INSTEAD OF CLEARING EXISTING NATIVE OR NATURALIZED VEGETATION:

(A) ALL NEW PLANT MATERIAL FOR ZONE TWO SHALL BE NATIVE, LOW-FUEL, AND FIRE-RESISTANCE. NO NON-NATIVE PLANT MATERIAL MAY BE PLANTED IN ZONE TWO EITHER INSIDE THE MHPA OR IN THE COASTAL OVERLAY ZONE, ADJACENT TO AREAS CONTAINING SENSITIVE BIOLOGICAL RESOURCES.

(B) NEW PLANTS SHALL BE LOW-GROWING WITH A MAXIMUM HEIGHT AT MATURITY OF 24 INCHES SINGLE SPECIMENS OF FIRE RESISTIVE NATIVE TREES AND TREE FORM SHRUBS MAY EXCEED THE LIMITATION IF THEY ARE LOCATED TO REDUCE THE CHANCE OF TRANSMITTING FIRE FROM NATIVE OR NATURALIZED VEGETATION TO HABITABLE STRUCTURES AND IF THE VERTICAL DISTANCE BETWEEN THE LOWEST BRANCHES OF THE TREES AND THE TOP OF ADJACENT PLANTS ARE THREE TIMES THE HEIGHT OF THE ADJACENT PLANTS TO REDUCE THE SPREAD OF THE FIRE THROUGH LADDER FUELINE.

(C) ALL NEW ZONE TWO PLANTINGS SHALL IRRIGATED TEMPORARILY UNTIL ESTABLISHED TO THE SATISFACTION OF THE CITY MANAGER. ONLY LOW-FLOW, LOW-GALLONAGE SPRAY HEADS MAY BE USED IN ZONE TWO. OVERSPRAY AND RUNOFF FROM THE IRRIGATION SHALL NOT DRIFT OR FLOW INTO ADJACENT AREAS OF NATIVE OR NATURALIZED VEGETATION. TEMPORARY IRRIGATION SYSTEMS SHALL BE REMOVED UPON APPROVED ESTABLISHMENT OF THE PLANTINGS. PERMANENT IRRIGATION IS NOT ALLOWED IN ZONE TWO.

SAN DIEGO LANDSCAPE STANDARDS SECTION III - BRUSH MANAGEMENT

3-1 BRUSH MANAGEMENT - DESCRIPTION

FIRE SAFETY IN THE LANDSCAPE IS ACHIEVED BY REDUCING THE READILY FLAMMABLE FUEL ADJACENT TO STRUCTURES. THIS CAN BE ACCOMPLISHED BY PRUNING AND THNNING OF NATIVE AND NATURALIZED VEGETATION, REVEGETATION WITH LOW FUEL VOLUME PLANTINGS OR A COMBINATION OF THE TWO. IMPLEMENTING BRUSH MANAGEMENT IN A ENVIRONMENTALLY APPROPRIATE MANNER REQUIRES A REDUCTION IN THE AMOUNT AND CONTINUITY OF HIGHLY FLAMMABLE FUEL WHILE MAINTAINING PLANT COVERAGE FOR SOIL PROTECTION. SUCH A TRANSITION WILL MINIMIZE THE VISUAL, BIOLOGICAL AND EROSION IMPACTS WHILE REDUCING THE RISKS OF WILDLAND FIRES.

3-2 BRUSH MANAGEMENT - REQUIREMENTS


3-2-1 BASIC REQUIREMENTS - ALL ZONES

3-2-1.01 FOR ZONE TWO, PLANTS SHALL NOT BE CUT BELOW SIX INCHES.

3-2-1.02 DEBRIS AND TRIMMINGS PRODUCED BY THINNING AND PRUNING SHALL BE REMOVED FROM THE SITE OR IF LEFT, SHALL BE CONVERTED INTO MULCH BY A CHIPPING MACHINE AND EVENLY DISPERSED, NON-IRRIGATED, TO A MAXIMUM DEPTH OF 6 INCHES.

3-2-1.03 TREES AND LARGE TREE FORM SHRUBS (E.G. OAKS, SUMAC, TOYON) WHICH ARE BEING RETAINED SHALL BE PRUNED TO PROVIDE CLEARANCE OF THREE TIMES THE HEIGHT OF THE UNDER STORY PLANT MATERIAL OR SIX FEET WHICHEVER IS HIGHER (FIGURE 3-1) DEAD AND EXCESSIVELY TWIGGY SHALL ALSO BE REMOVED.

FIGURE 3-1 PRUNING TREES TO PROVIDE CLEARANCE FOR BRUSH MANAGEMENT

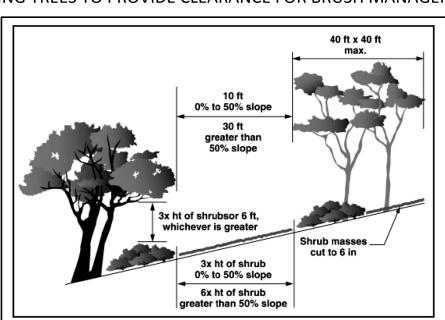

3-2-1.04 ALL PLANTS OR PLANT GROUPING EXCEPT CACTI, SUCCULENTS, TREES AND TREE-FORM SHRUBS SHALL BE SEPARATED BY A DISTANCE THREE TIMES THE HEIGHT OF THE TALLEST ADJACENT PLANTS (FIGURE 3-1).

3-2-1.05 MAXIMUM COVERAGE AND AREA LIMITATIONS AS STATED HEREIN SHALL NOT APPLY TO INDIGENOUS NATIVE TREE SPECIES (I.E. PINUS, QUERCUS, PLATANUS, SALIX AND POLULUS).

3-2-2 ZONE 1 REQUIREMENTS - ALL STRUCTURES

3-2-2.01 DO NOT USE, AND REMOVE IF NECESSARY, HIGHLY FLAMMABLE PLANT MATERIALS (SEE APPENDIX "B").

3-2-2.02 TREES SHOULD NOT BE LOCATED ANY CLOSER TO A STRUCTURE THAN A DISTANCE EQUAL TO THE TREE'S MATURE SPREAD.

3-2-2.03 MAINTAIN ALL PLANTINGS IN A SUCCULENT CONDITION.

3-2-2.04 NON-IRRIGATED PLANT GROUPINGS OVER SIX INCHES IN HEIGHT MAY BE RETAINED PROVIDED THEY DO NOT EXCEED 100 SQUARE FEET IN AREA AND THEIR COMBINED COVERAGE DOES NOT EXCEED 10 PERCENT OF THE TOTAL ZONE 1 AREA.

3-2-3 ZONE 2 REQUIREMENTS - ALL STRUCTURES

3-2-3.01 INDIVIDUAL NON-IRRIGATED PLANT GROUPINGS OVER 24 INCHES IN HEIGHT MAY BE RETAINED PROVIDED THEY DO NOT EXCEED 400 SQUARE FEET IN AREA AND THEIR COMBINED COVERAGE DOES NOT EXCEED 30 PERCENT OF THE TOTAL ZONE 2 AREA.


BRUSH MANAGEMENT MAINTENANCE NOTES

1. GENERAL MAINTENANCE- REGULAR INSPECTIONS AND LANDSCAPE MAINTENANCE ARE NECESSARY TO MINIMIZE THE POTENTIAL DAMAGE OR LOSS OF PROPERTY FROM BRUSH FIRES AND OTHER NATURAL HAZARDS SUCH AS EROSION AND SLOPES FAILURES. BECAUSE EACH PROPERTY IS UNIQUE ESTABLISHING A PRECISE MAINTENANCE SCHEDULE IS NOT FEASIBLE. FOR EFFECTIVE FIRE AND WATERSHED MANAGEMENT HOWEVER, PROPERTY OWNERS SHOULD EXCEPT TO PROVIDE MAINTENANCE ACCORDING TO EACH BRUSH MANAGEMENT ZONE: ZONE 1: YEAR-ROUND COASTAL SAGE SCRUB, MARITIME SUCCULENT SCRUB, AND COASTAL SAGE-CHAPARRAL HABITATS FROM MARCH 1 THROUGH AUGUST 15, EXCEPT WHERE DOCUMENTED TO THE SATISFACTION OF THE CITY MANAGER THAT THE THINNING WOULD BE CONSISTENT WITH CONDITIONS OF SPECIES COVERAGE DESCRIBED IN THE CITY OF SAN DIEGO'S MSCP SUBAREA PLAN.

2. BRUSH MANAGEMENT ZONE 1- THIS IS THE MOST CRITICAL AREA FOR FIRE AND WATERSHED SAFETY. ALL ORNAMENT PLANTINGS SHOULD BE KEPT WELL WATERED AND IRRIGATION RUN-OFF SHOULD DRAIN TOWARD THE STREET. RAIN GUTTERS AND DRAINAGE PIPES SHOULD BE CLEANED REGULARLY AND ALL LEAVES REMOVED FROM THE ROOF BEFORE THE FIRE SEASON BEGINS. ALL PLANTING, PARTICULARLY NON-IRRIGATED NATIVE AND LARGE TREES SHOULD BE REGULARLY PRUNED TO ELIMINATE DEAD FUELS, TO REDUCE EXCESSIVE FUEL AND TO PROVIDE ADEQUATE SPACE BETWEEN PLANTS AND STRUCTURES.

3. BRUSH MANAGEMENT ZONE 2- SEASONAL MAINTENANCE IN THIS ZONE SHOULD INCLUDE REMOVAL OF DEAD WOODY PLANTS, ERADICATION OF WEEDY SPECIES AND PERIODIC PRUNING AND THINNING OF TREES AND SHRUBS. REMOVAL OF WEEDS SHOULD NOT BE DONE WITH HAND TOOLS SUCH AS HOES, AS THIS DISTURBS VALUABLE SOIL. THE USE OF WEED TRIMMERS OR OTHER TOOLS WHICH RETAIN SHORT STUBBLE THAT PROTECTS THE SOIL IS RECOMMENDED. NATIVE SHRUBS SHOULD BE PRUNED IN THE SUMMER AFTER THE MAJOR PLANT GROWTH OCCURS. WELL PRUNED HEALTHY SHRUBS SHOULD TYPICALLY REQUIRE SEVERAL YEARS TO BUILD UP EXCESSIVE LIVE AND DEAD FUEL. ON SLOPES ALL DRAINAGE DEVICES MUST BE KEPT CLEAR. RE-INSPECT AFTER EACH MAJOR STORM SINCE MINOR SOIL SLIPS CAN BE BLOCK DRAINS. VARIOUS GROUNDCOVER SHOULD BE PERIODICALLY SHEARED AND DEAD REMOVED. DISEASED AND DEAD WOOD SHOULD BE PRUNED FROM TREES. FERTILIZING TREES AND SHRUBS IS NOT TYPICALLY RECOMMENDED AS THIS MAY STIMULATE EXCESSIVE GROWTH.

4. LONG-TERM MAINTENANCE RESPONSIBILITY- ALL LANDSCAPING/BRUSH MANAGEMENT WITHIN THE BRUSH MANAGEMENT ZONE(S) AS SHOWN ON THESE PLANS SHALL BE THE RESPONSIBILITY OF MR. JON **POWELL** [OWNER] THE BRUSH MANAGEMENT ZONE AREAS SHALL BE MAINTAINED FREE OF DEBRIS AND LITTER AND ALL PLANT MATERIAL SHALL BE MAINTAINED IN A HEALTHY GROWING CONDITION.

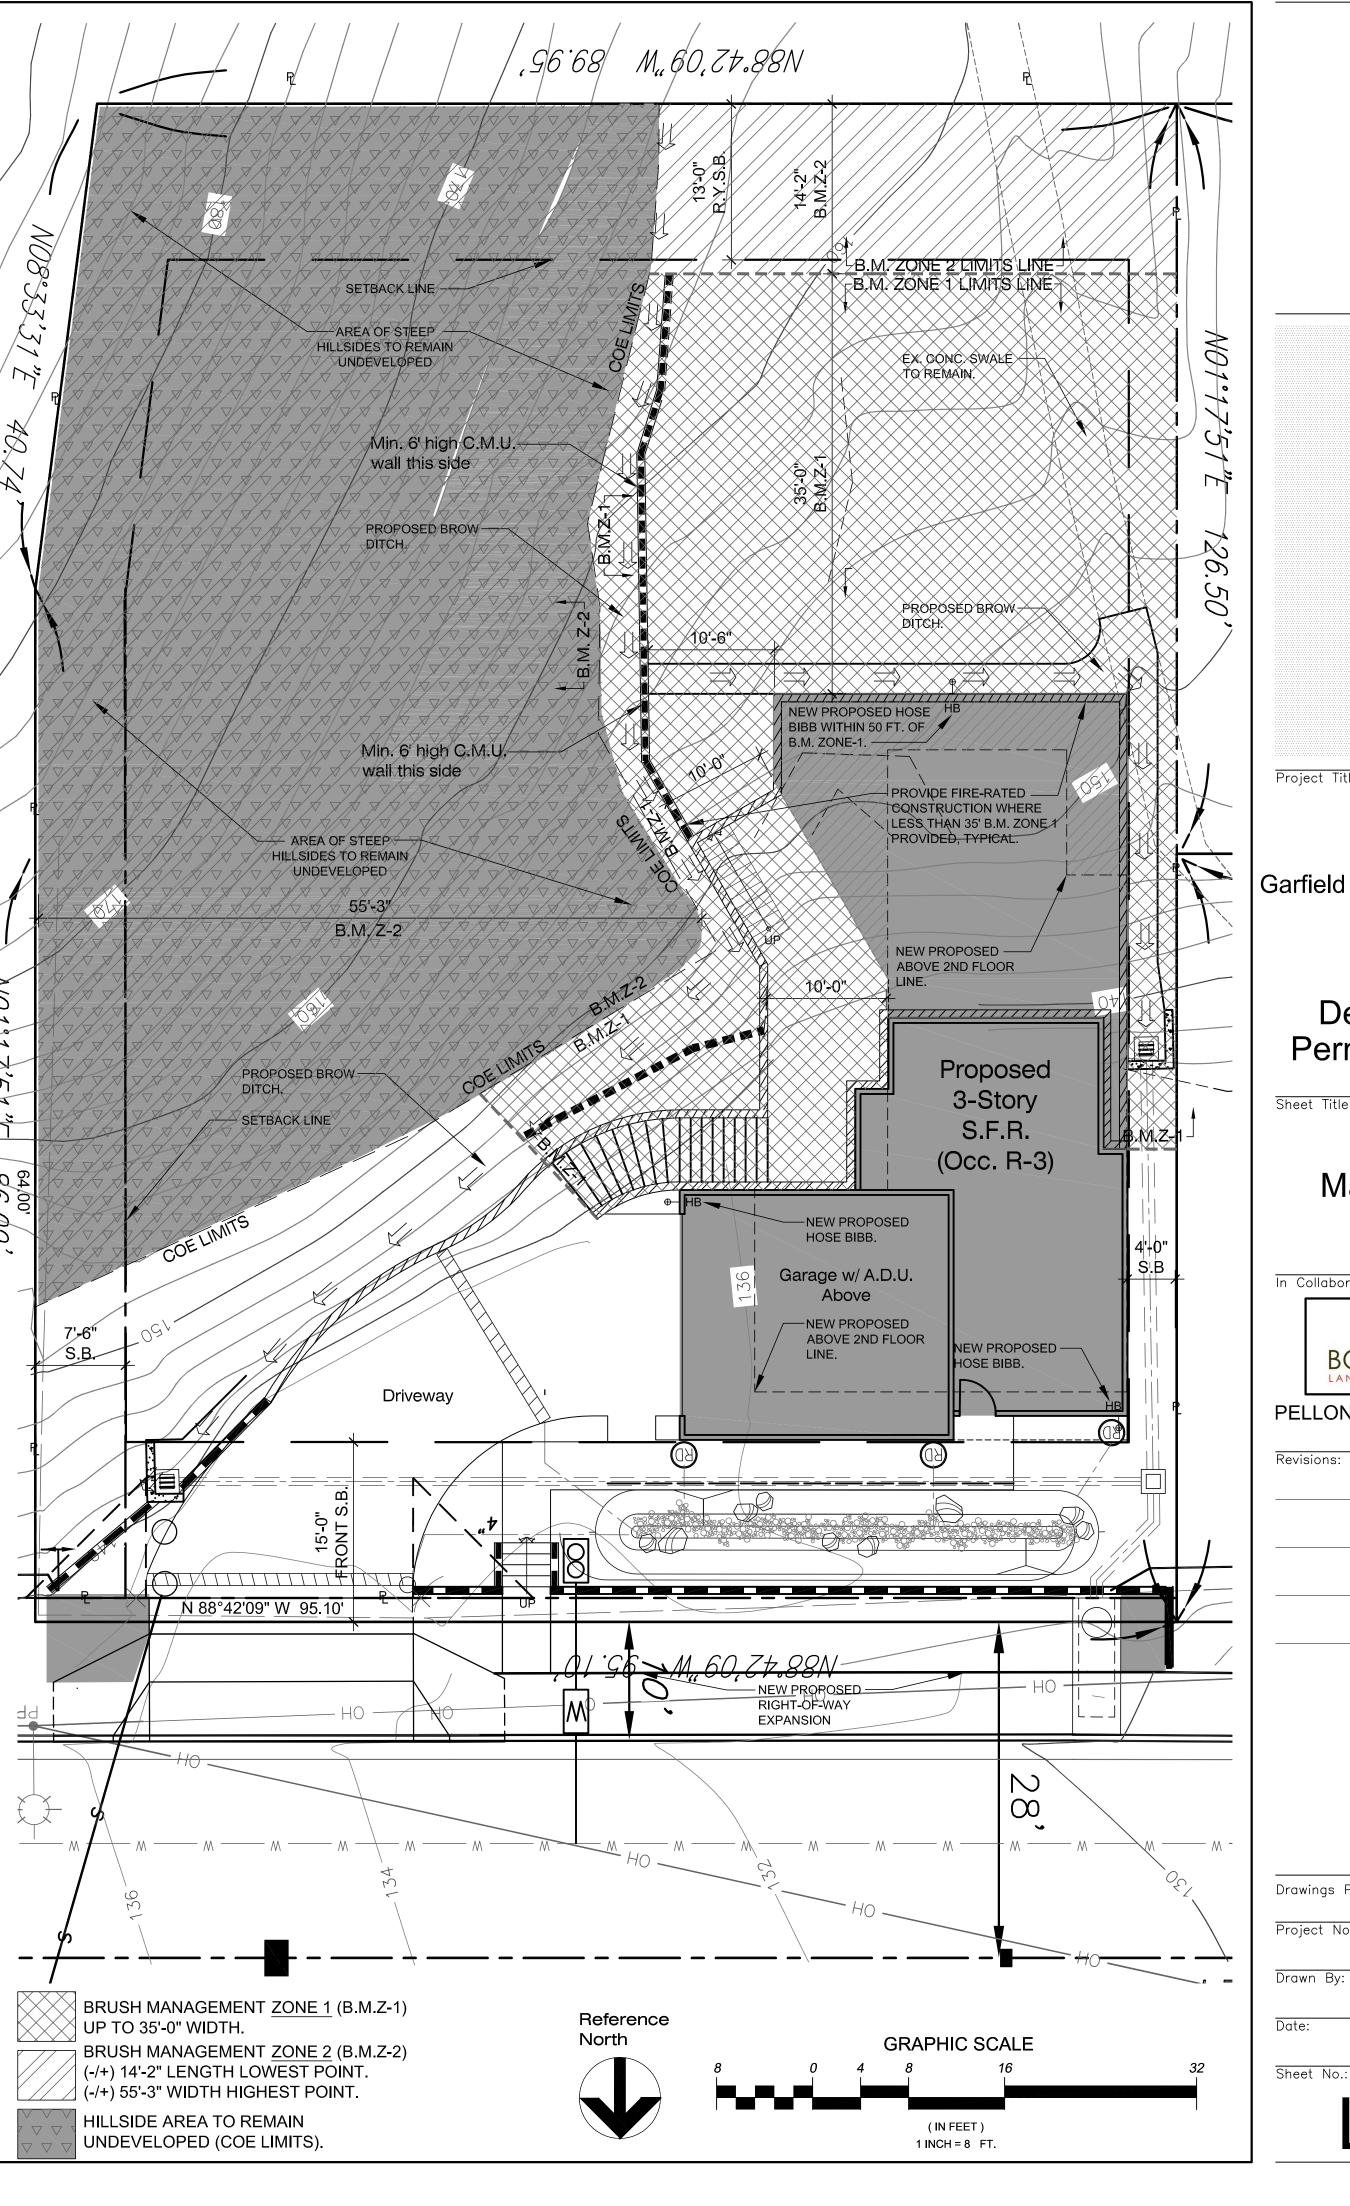

ATTACHMENT 11

POWELL RESIDENCE Garfield Rd. & Kane St. San Diego, CA

> Development Permit (S.D.P.)

Sheet Title:

Brush Management Plan


In Collaboration with: BOTANICA

PELLON LAY 619.379.6044


Drawings Prepared By: Project No.: 2215

Checked By:

Date: 11.27.2024

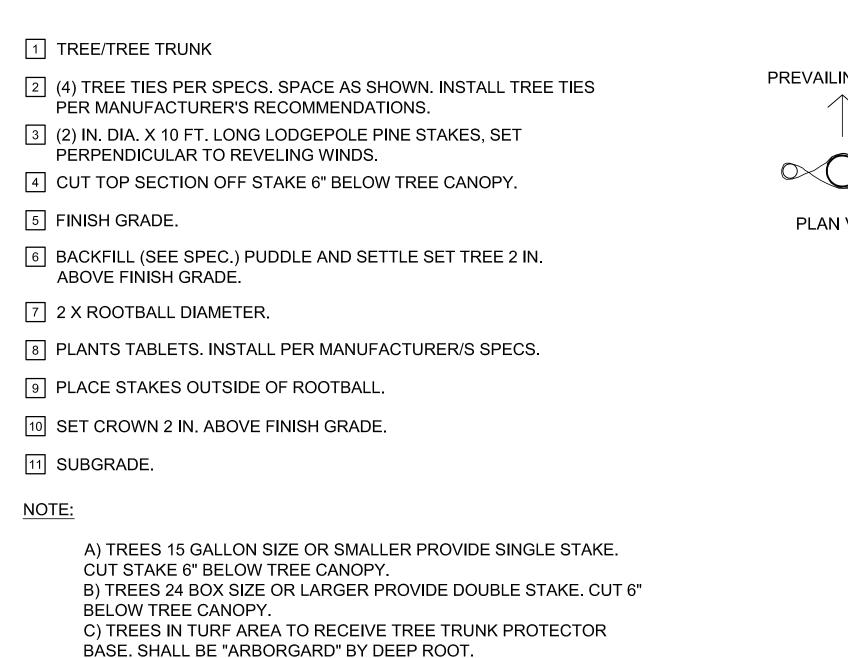

PREVAILING WIND PLAN VIEW 1-1/2X DEPTH OF **ROOTBALL**

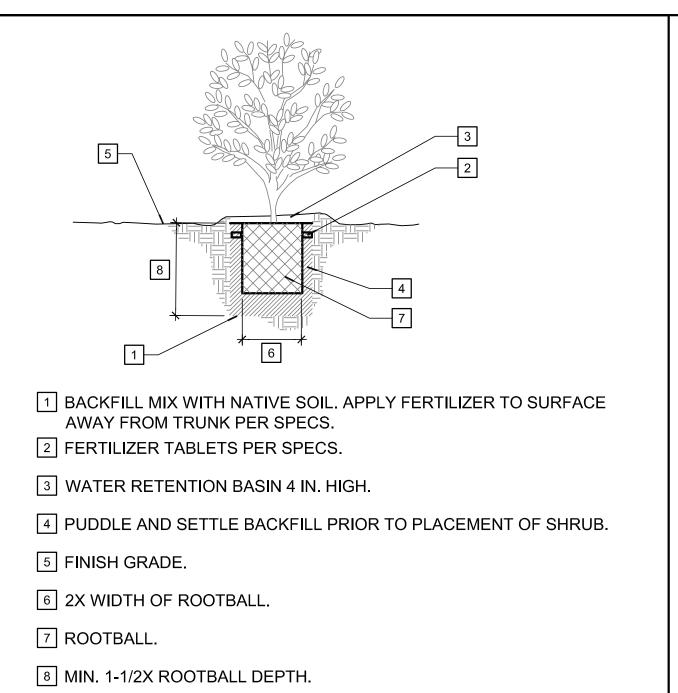

NTS B SHRUB DETAIL TYP.

1 DISTANCE FROM EDGE OF PLANTER TO CENTER OF PLANT TO BE ½ THE SPECIFIED SPACING PER GROUNDCOVER.

2 EQUAL TRIANGULAR SPACING REQUIRED BETWEEN PLANTS (REFER TO PLANT LEGEND FOR ON CENTER SPACING).

3 EDGE OF PLANTING AREA.

NTS C GROUNDCOVER DETAIL TYP.

NTS

Project Title:

POWELL RESIDENCE Garfield Rd. & Kane St. San Diego, CA

> Site Development Permit (S.D.P.)

Landscape **Details & Notes**



PELLON LAY 619.379.6044

Revisions:


Drawings Prepared By: Project No.: 2215 Checked By: Drawn By:

Sheet No.:

11.27.2024

FRONT-YARD HARDSCAPE CALCULATIONS (SCALE 1IN = 8 FT.):

TREE DETAIL TYP.

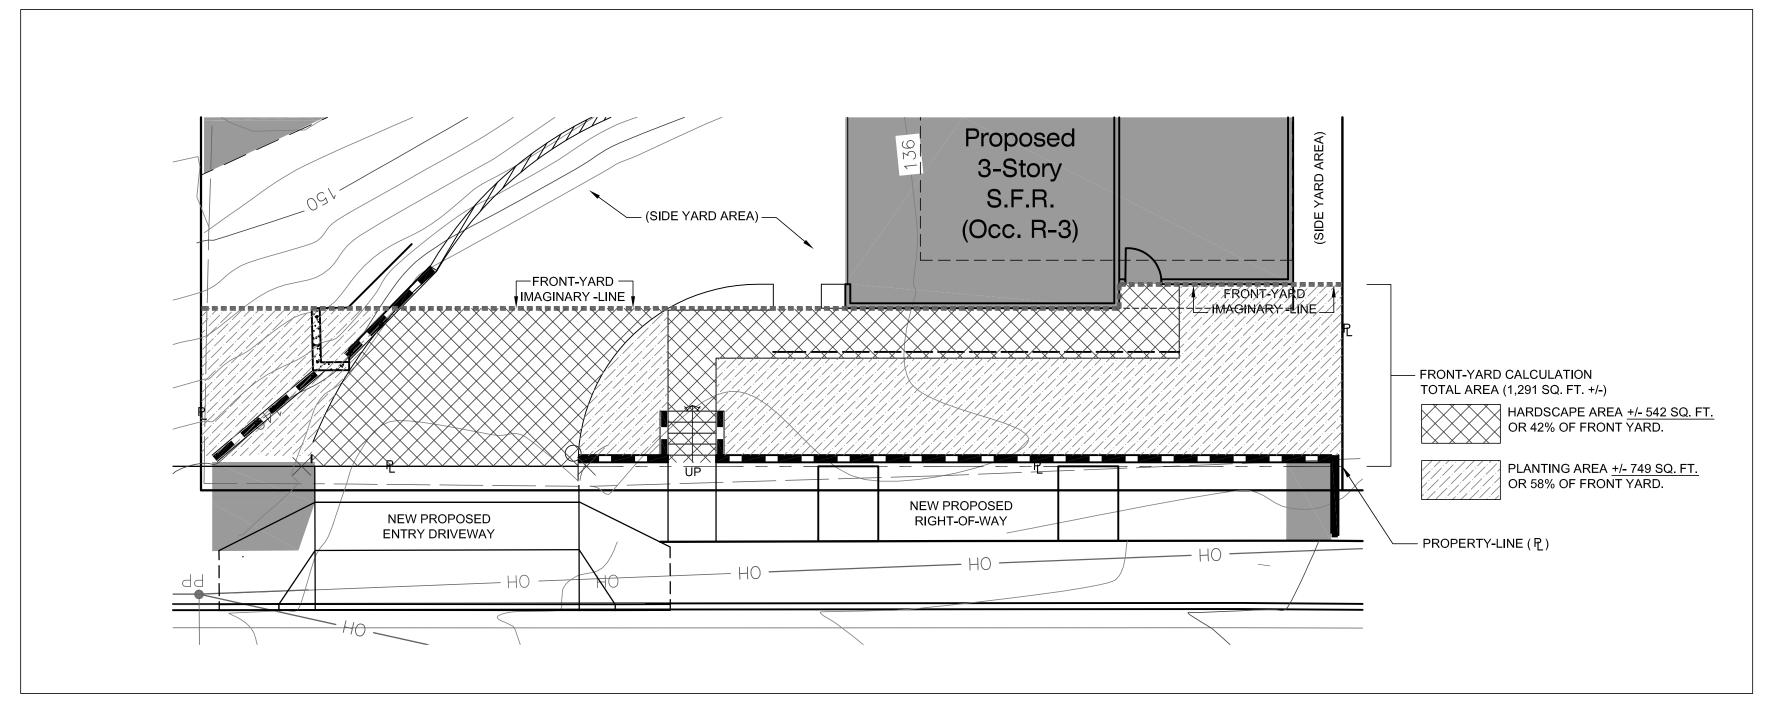

PLANTING NOTES

1) All landscape installation shall be in accordance with the City of San Diego's Land Development Manual Landscape Standards. Owner shall be responsible for the long-term maintenance of the project

protection measures will be provided:

2) Existing trees to remain on site within the area of work will be protected in place. The following

a) A bright yellow or orange temporary fence will be placed around existing trees at the drip line.

b) Stockpiling, topsoil disturbance, vehicle use, and material storage of any kind is prohibited within the drip line.

c) A tree watering schedule will be maintained and documented during construction.

d) All damaged trees will be replaced with one of equal or greater size.

3) "Mulch: All required planting areas and all exposed soil areas without vegetation shall be covered with mulch to a minimum depth of 3 inches, excluding slopes requiring renegotiation per SDMC 142,0411"

4) "Tree root barriers shall be installed where trees are placed within 5 feet of public improvements including walks, curbs, or street pavements or where new public improvements are placed adjacent to existing trees. The root barrier will not wrap around the root ball." Please clearly identify the installation of root barriers in the locations subject to there conditions per 142.0403 9b).

5) All pruning shall comply with the standards of America national standards institute (ANSI) for tree care operations and the international society of horticulture (ISA) for tree pruning. topping of trees not permitted.

6) A minimum root zone of 40 SF. in area shall be provided for all trees. The minimum dimension for this area shall be 5 feet, per SDMC 142.0403 (b) (5)."

7) Trees shall be maintained so that all branches over pedestrian walkways are 6 ft. above the walkway grade and branches over vehicular travel ways are 16 ft. above the grade of the travel way per the San Diego Municipal Code 142.0403(b)(10).

8) An automatic electrically controlled irrigation system shall be provided as required by LDC 142.0403(c) for proper irrigation, development, and maintenance of the vegetation in a healthy, disease-resistant condition. The design shall provide adequate support for the vegetation selected.' also, indicate the type(s) of irrigation system(s) proposed; i.e. spray, drip, etc.

"Maintenance: All required landscape areas shall be maintained by JON POWELL (homeowner). Landscape and irrigation areas in the public-right-of-way shall be maintained by JON POWELL (homeowner). The landscape areas shall be maintained free of debris and litter and all plant material shall be maintained in a healthy growing condition. Diseased or dead plant material shall be satisfactory treated or replaced per the conditions of the permit."


MINIMUM TREE SEPARATION DISTANCE:

Improvement/ Minimum Distance to Street Tree Traffic signals / stop sign - 20 feet.

Underground utility lines -5 feet. Above ground utility structures -10 feet. Driveway (entries) -10 feet.

Intersections (intersecting curb lines of two streets) -25 feet.

Sewer Lines -10 feet.

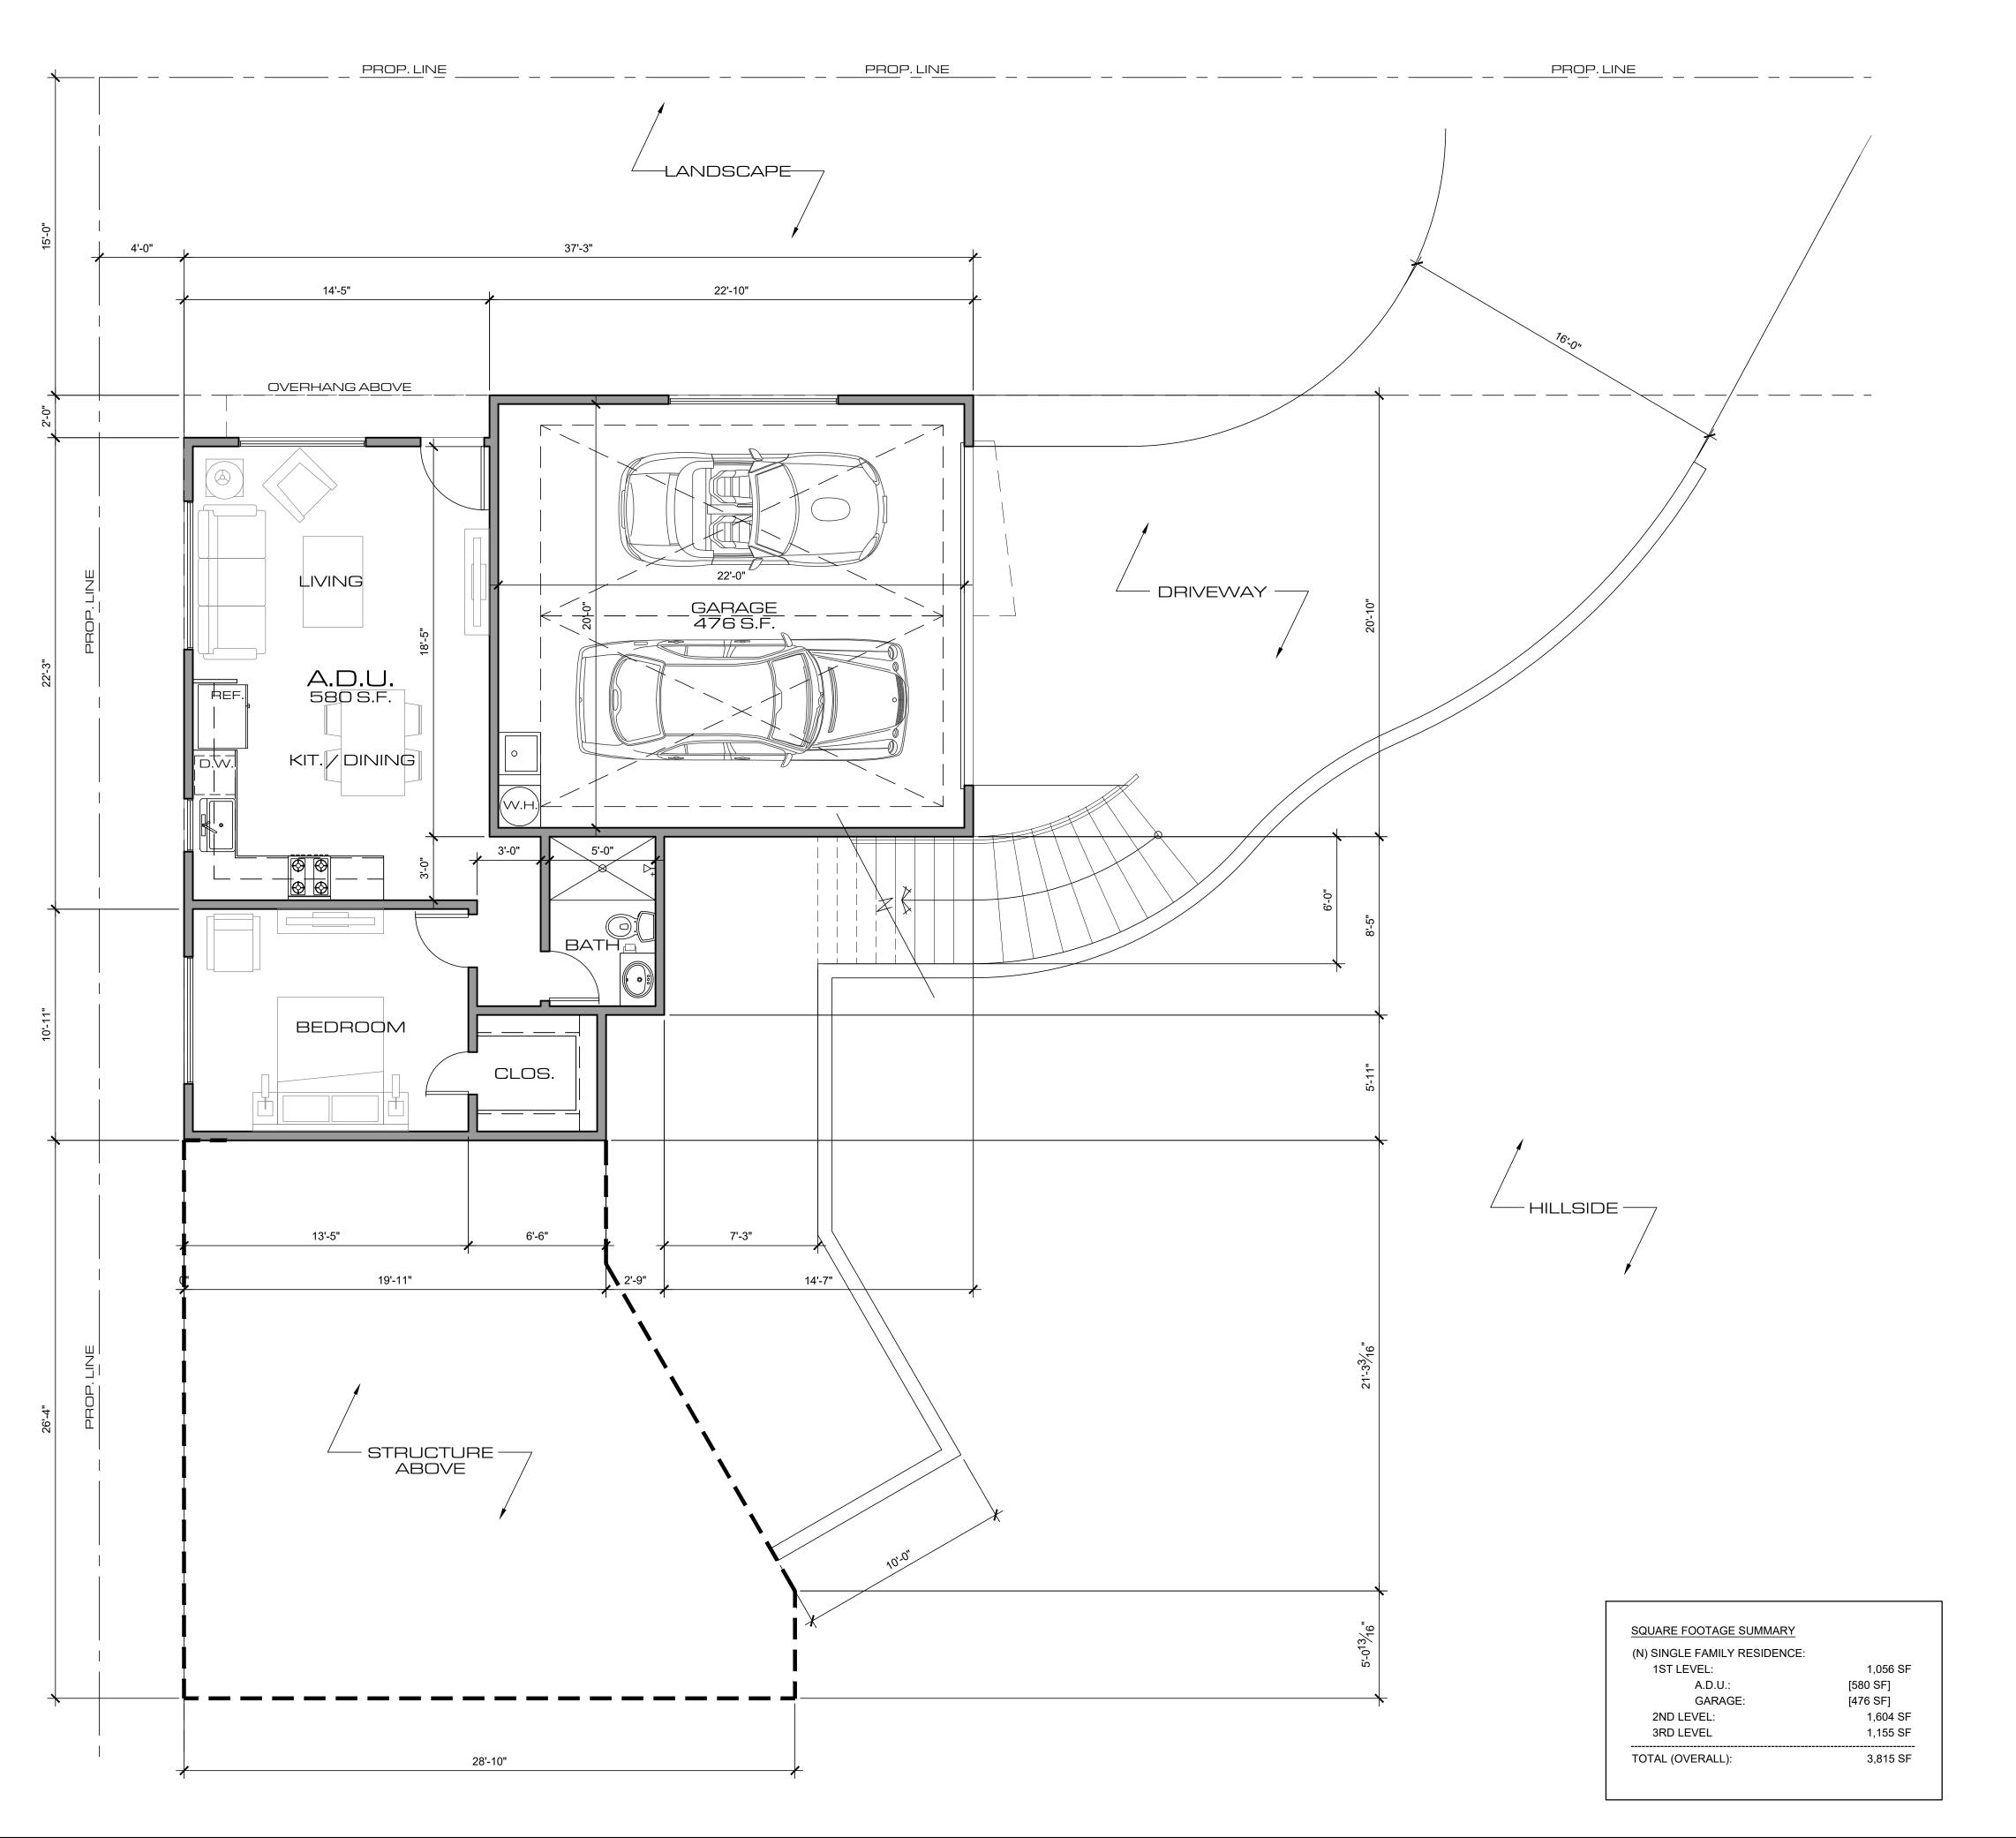

BALLERING DESIGN

BALLERING DESIGN

ASSOCIATES, LLC

ASSOCIATES, LLC

ASSOCIATES, LLC

ASSOCIATES, LLC

ASSOCIATES, LLC

BALLERING DESIGN

POWELL RESIDENCE Garfield Rd. & Kane St. San Diego, CA

Site Development Permit (S.D.P.)

Revisions: SDP/TM PLANCHECK CORRECTIONS 05.16.2022 SDP/TM RE-SUBMITTAL 04.21.2023 SDP/TM RE-SUBMITTAL 10.05.2023 SDP/TM RE-SUBMITTAL 12.08.2023 SDP/TM RE-SUBMITTAL 05.10.2024 SDP/TM RE-SUBMITTAL 08.15.2024 SDP/TM RE-SUBMITTAL 10.11.2024 Sheet Title:

Floor Plan 1st Level

Signatures:

Drawings Prepared By:

Sallering

Project No.:

20019

Drawn By: Checked By:

DB DB

Date:

08.01.2021


Sheet No.:

A-1

Floor Plan - 1st Level SCALE 1/4"=1'-0"

Reference



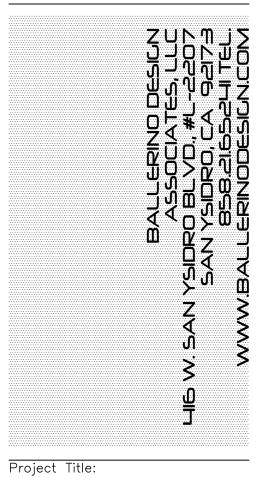

POWELL RESIDENCE Garfield Rd. & Kane St. San Diego, CA

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Floor Plan 2nd Level

Signatures:


Drawings Prepared By:

Project No.: 20019 Checked By: 08.01.2021

Sheet No.:

Reference

A-2

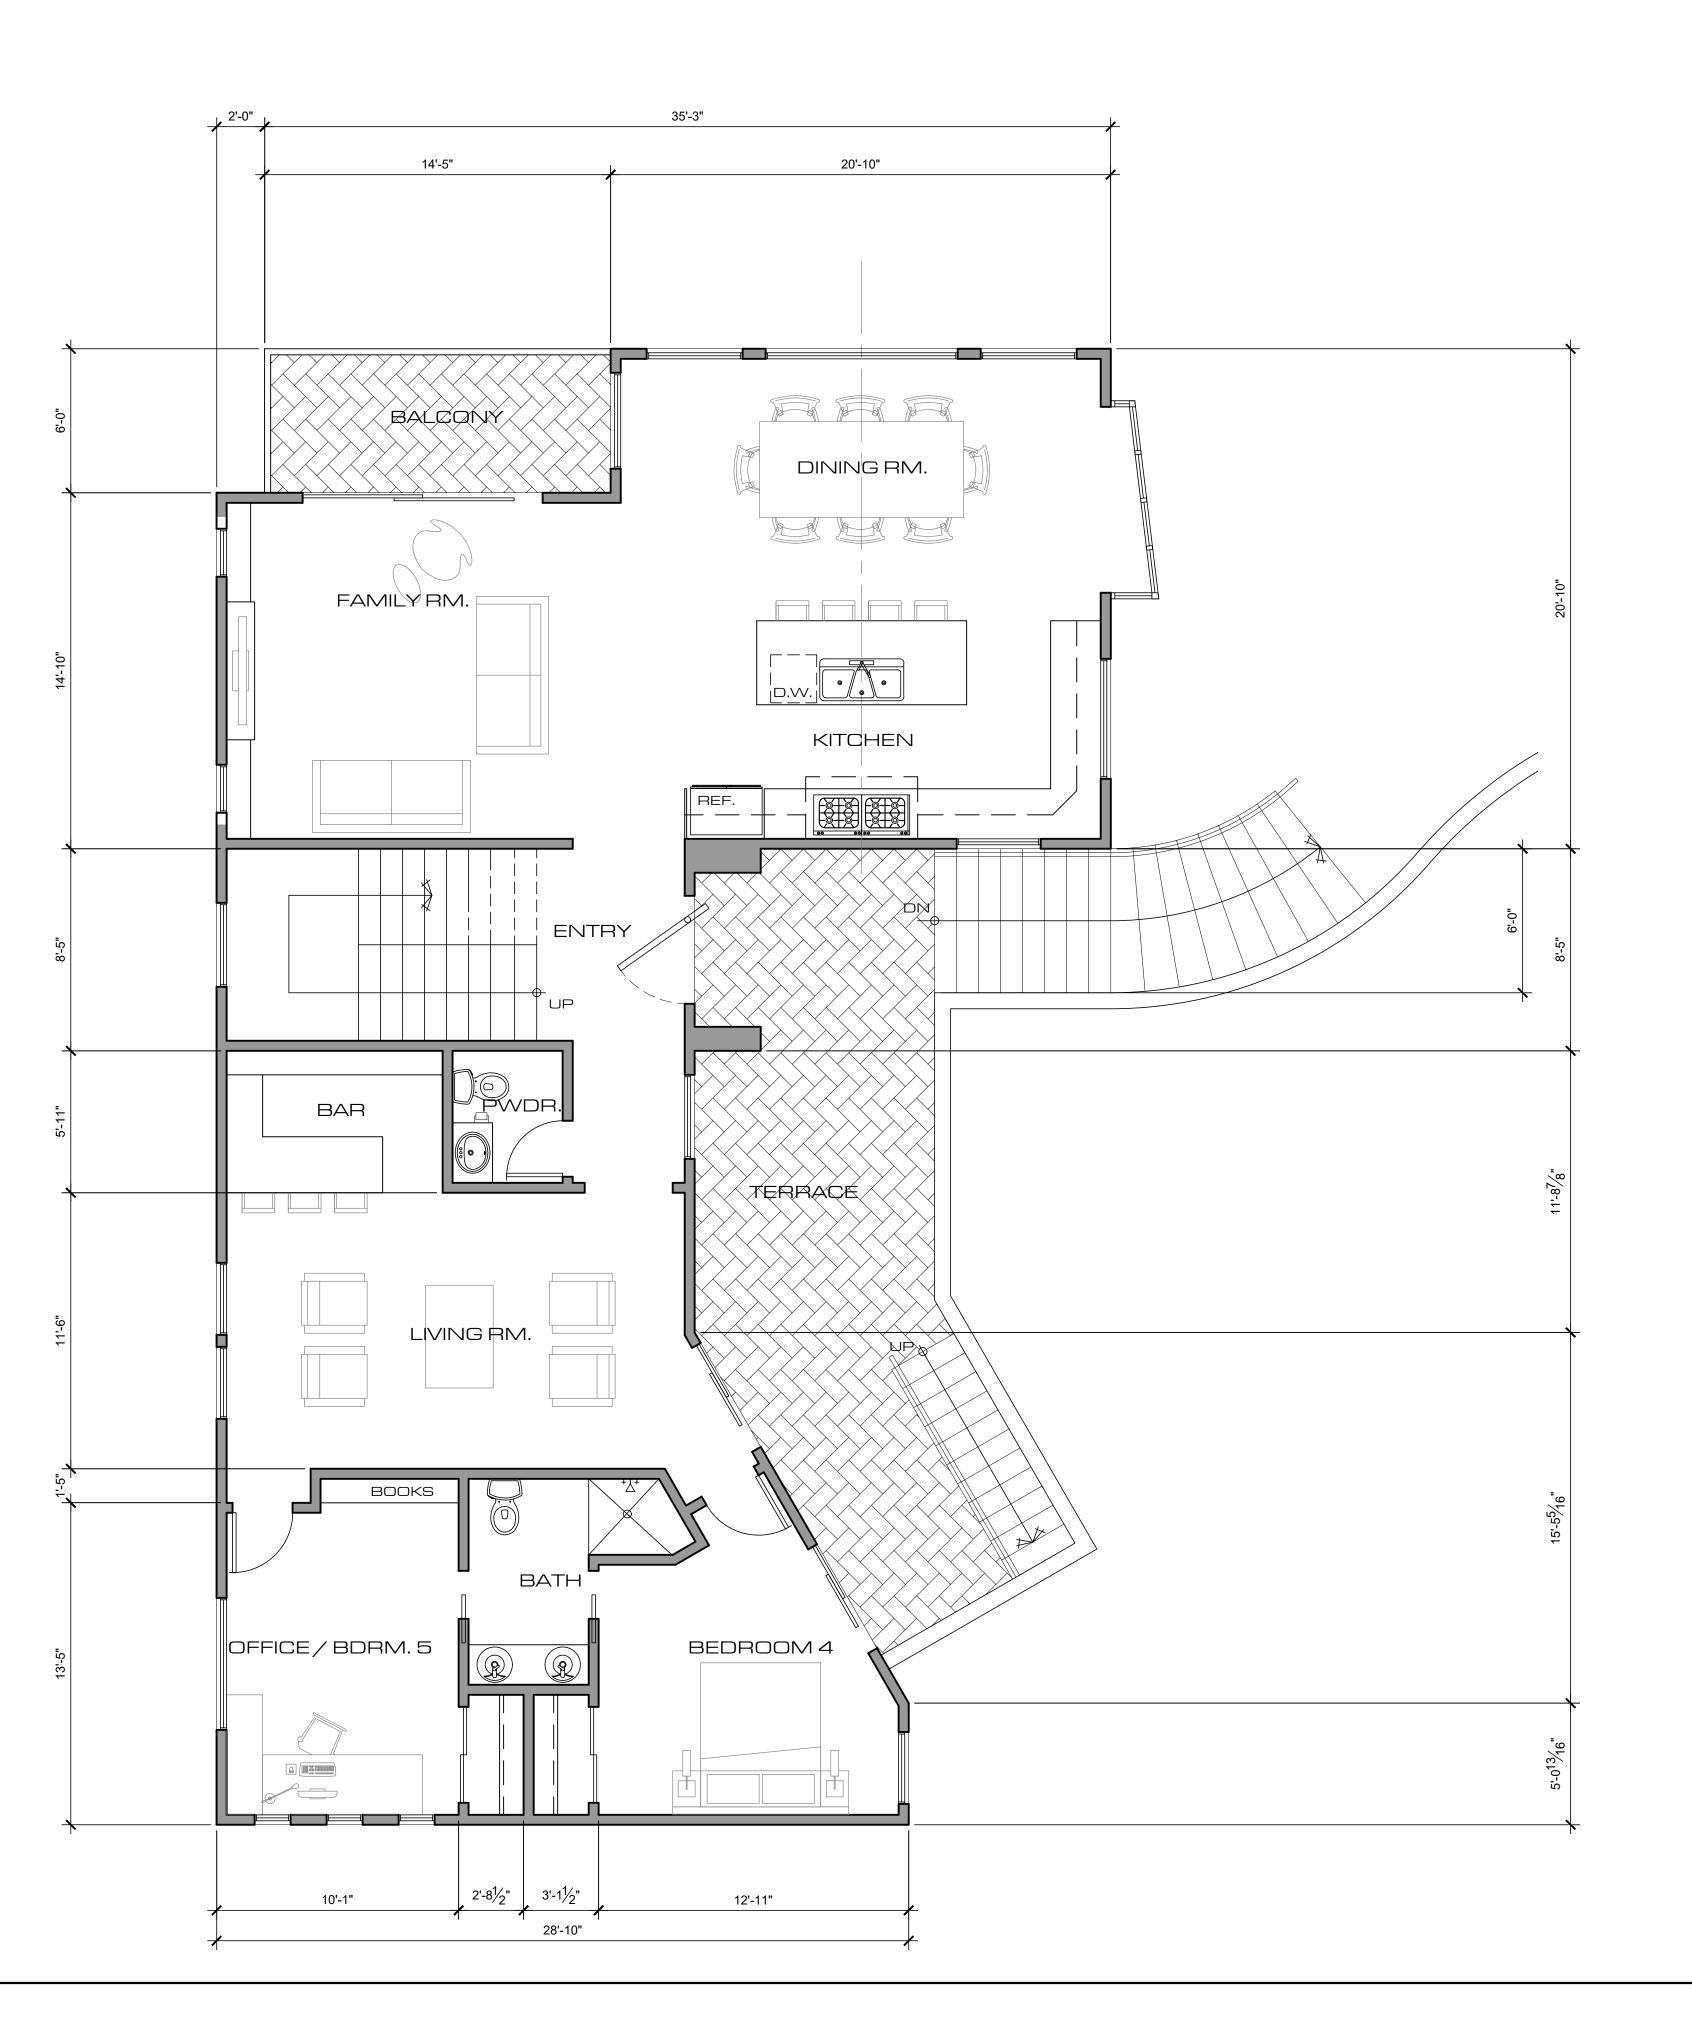

SQUARE FOOTAGE SUMMARY (N) SINGLE FAMILY RESIDENCE:

1ST LEVEL:

2ND LEVEL:

3RD LEVEL

TOTAL (OVERALL):

1,056 SF

1,604 SF

3,815 SF

[580 SF]

[476 SF]





POWELL RESIDENCE Garfield Rd. & Kane St. San Diego, CA

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Revisions: SDP/TM PLANCHECK CORRECTIONS 05.16.2022 SDP/TM RE-SUBMITTAL 04.21.2023 SDP/TM RE-SUBMITTAL 10.05.2023 SDP/TM RE-SUBMITTAL 12.08.2023 SDP/TM RE-SUBMITTAL 05.10.2024 SDP/TM RE-SUBMITTAL 08.15.2024 SDP/TM RE-SUBMITTAL 10.11.2024

> Floor Plan 3rd Level

Signatures:

Drawings Prepared By:

Project No.: 20019 Checked By: 08.01.2021

Sheet No.: **A-3**

Floor Plan - 3rd Level

BEDROOM 3 BALCONY ROOF SQUARE FOOTAGE SUMMARY (N) SINGLE FAMILY RESIDENCE: 1ST LEVEL: 1,056 SF [580 SF] [476 SF] 2ND LEVEL: 1,604 SF 14'-11" 7'-11" 3RD LEVEL 1,155 SF TOTAL (OVERALL): 3,815 SF 28'-10"

Reference

BEDROOM 2

37'-3"

TERRACE

3'-6"

2'-9"

PRINCIPAL BEDROOM

15'-0"

WALK-IN

BATH

17'-4"


22'-3"

6'-0"

ROOF

BALC.

6'-0"

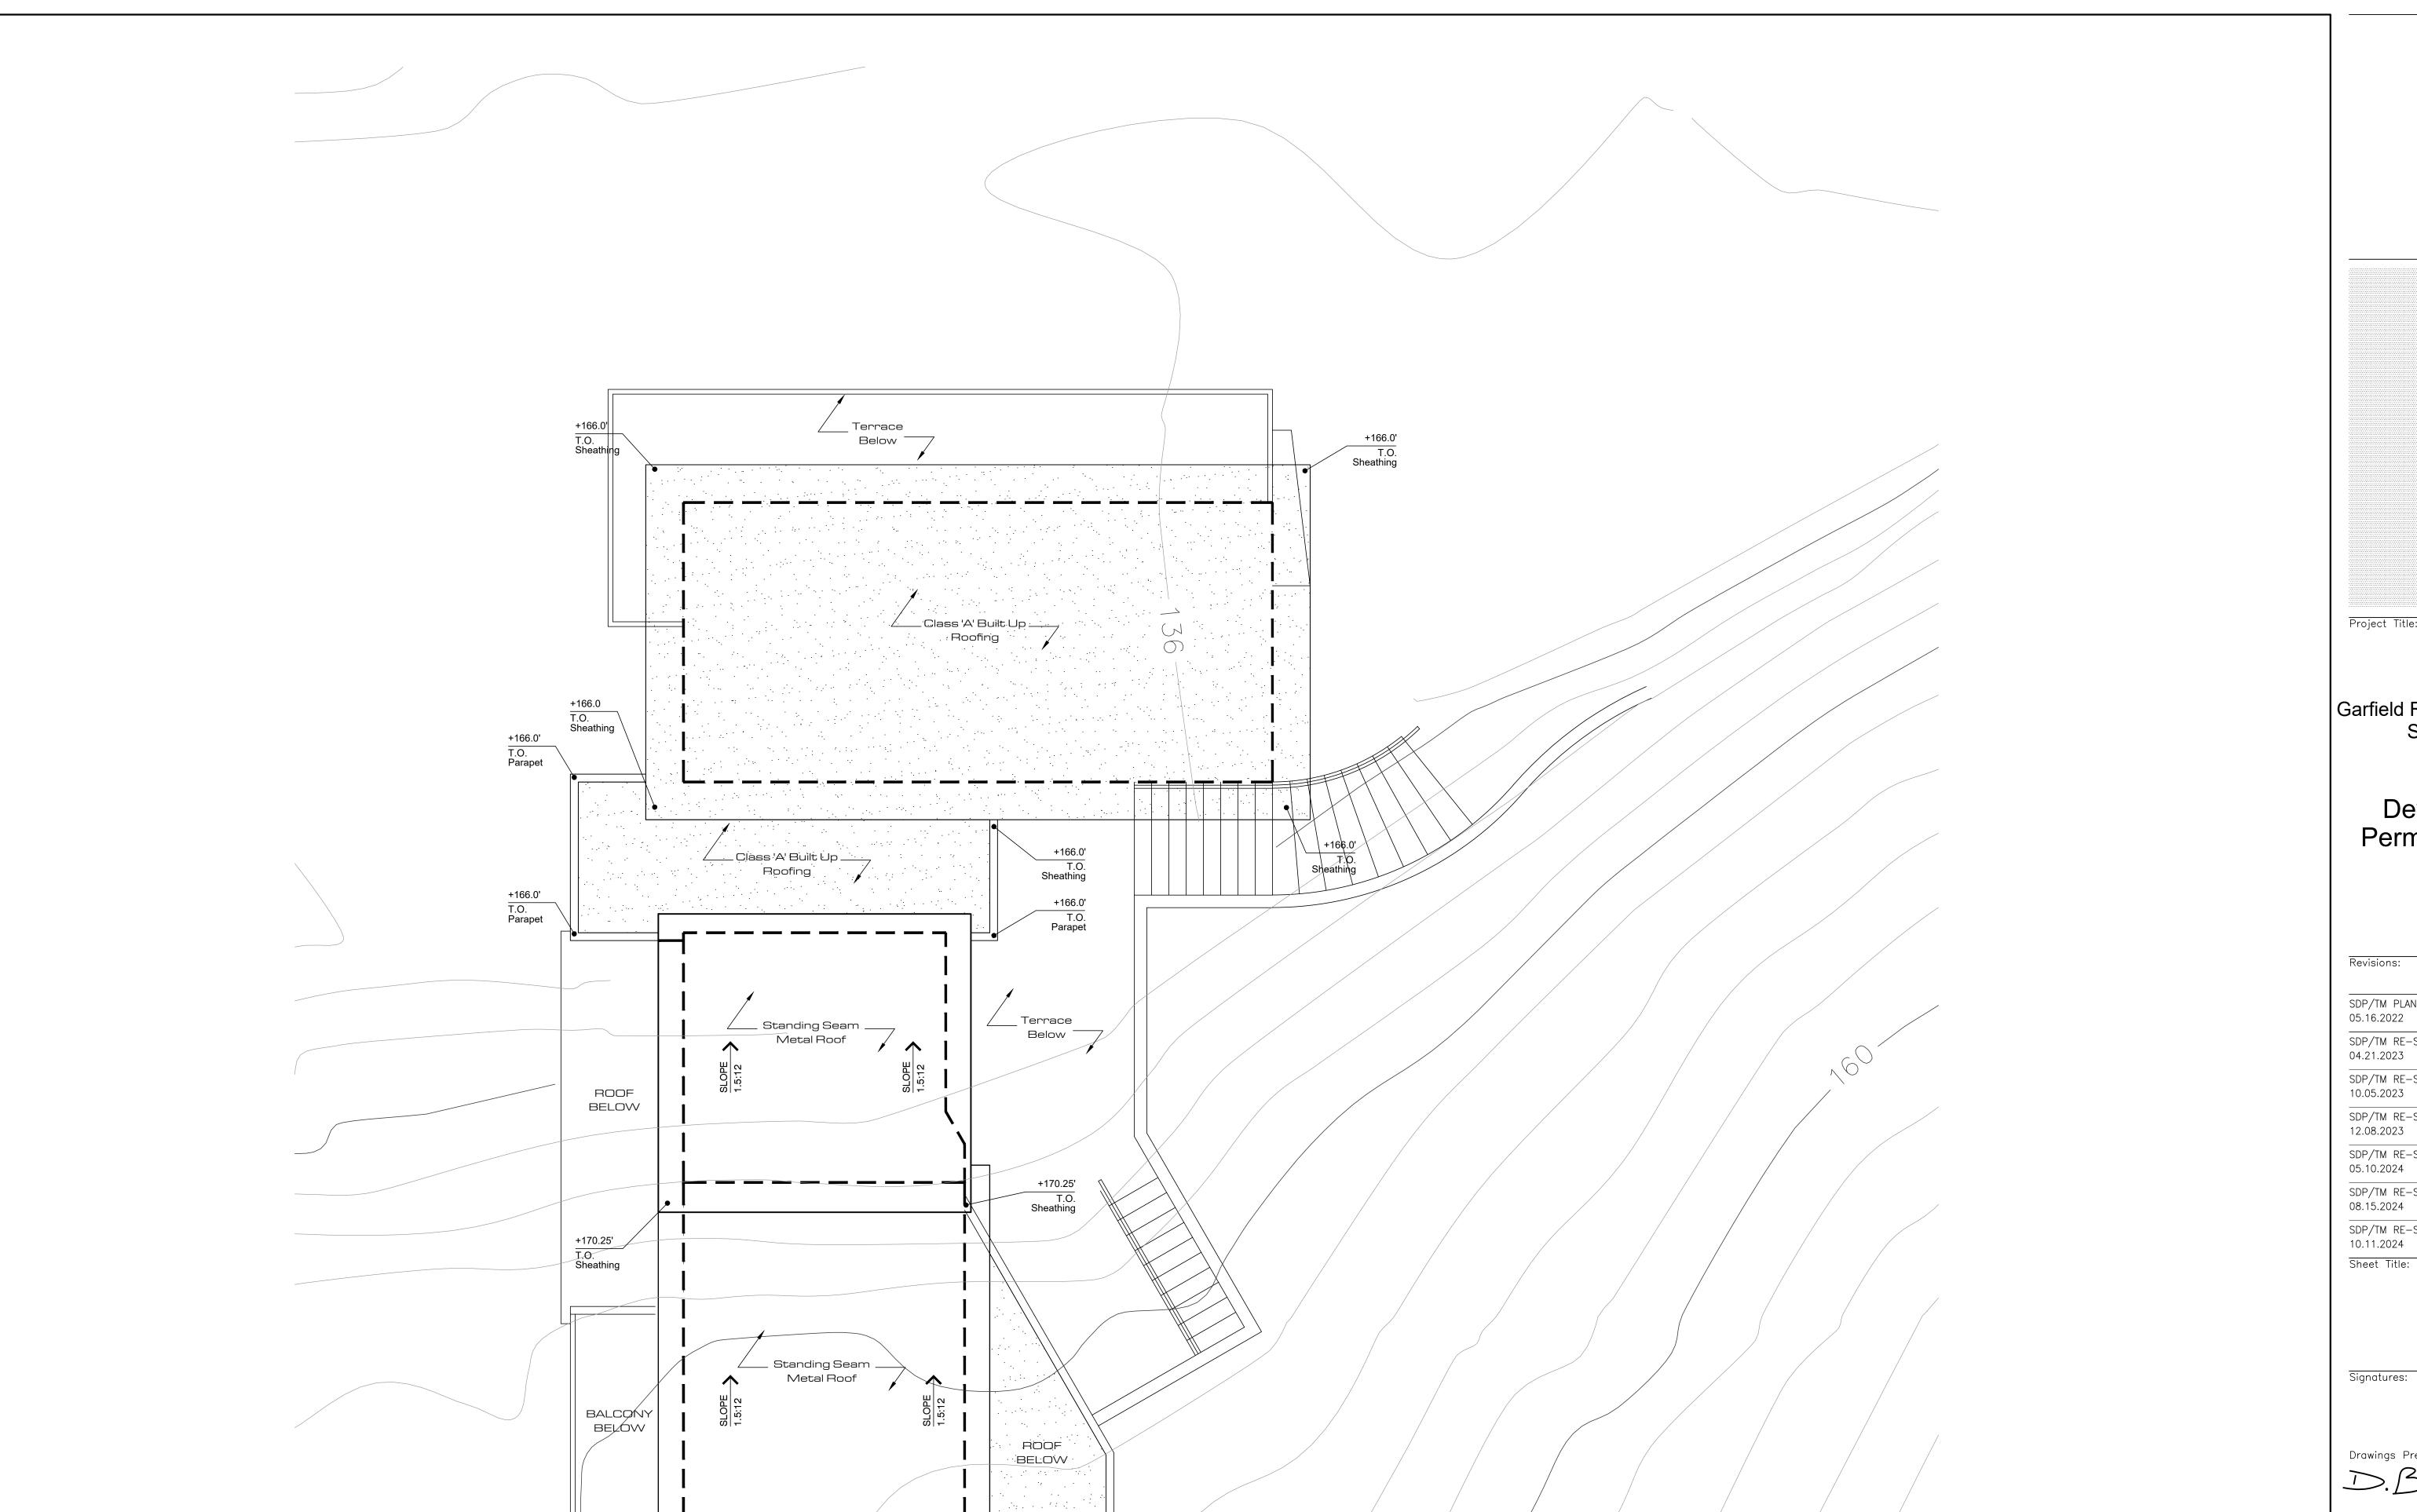

POWELL RESIDENCE Garfield Rd. & Kane St. San Diego, CA

> Site Development Permit (S.D.P.)

Revisions: SDP/TM PLANCHECK CORRECTIONS 05.16.2022 SDP/TM RE-SUBMITTAL 04.21.2023 SDP/TM RE-SUBMITTAL 10.05.2023 SDP/TM RE-SUBMITTAL 12.08.2023 SDP/TM RE-SUBMITTAL 05.10.2024 SDP/TM RE-SUBMITTAL 08.15.2024 SDP/TM RE-SUBMITTAL 10.11.2024

Roof Plan

Signatures:

Drawings Prepared By:

Project No.: 20019 Checked By:


08.01.2021

Sheet No.:

Reference

17'-7"

+171.5' T.O. Sheathing

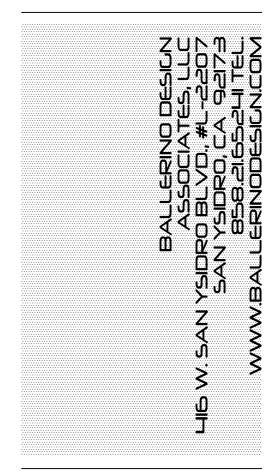

POWELL RESIDENCE Garfield Rd. & Kane St. San Diego, CA

Development Permit (S.D.P.)

Revisions: SDP/TM PLANCHECK CORRECTIONS 05.16.2022 SDP/TM RE-SUBMITTAL 04.21.2023 SDP/TM RE-SUBMITTAL 10.05.2023 SDP/TM RE-SUBMITTAL 12.08.2023 SDP/TM RE-SUBMITTAL 05.10.2024 SDP/TM RE-SUBMITTAL 08.15.2024 SDP/TM RE-SUBMITTAL 10.11.2024

> Exterior Elevations

Signatures:

Drawings Prepared By:

Project No.: 20019 Checked By:

08.01.2021

Sheet No.:

A-5

fin. grade

Exterior Elevations

— Datum +136.5'

5'-0"

40'-0" max. overall ht. limit

+166.0'

4847

- Existing Grade

- Proposed Grade

east (left side)

exterior elevation

30'-0" max.

ht. limit

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Hardiplank siding

Light Gray, typ.

Existing grade in — foreground

GRADE AT HIGH SIDE— 155.4'

Existing grade

beyond (at structure footprint)

(cementitious siding), color

T.O. PLATE

T.O. PLATE

T.O. PLATE

FIN. SLAB

Metal awning / canopy

Split face CMU retaining

+170.25'

Existing grade

structure footprint)

Existing grade in

beyond (at

foreground

– Line of 30' structure height limit, typical

- 2x Wood fascia, typ.

Light Gray, typ.

– Exterior stucco finish, color


Exterior Stairs





POWELL RESIDENCE Garfield Rd. & Kane St. San Diego, CA

Site Development Permit (S.D.P.)

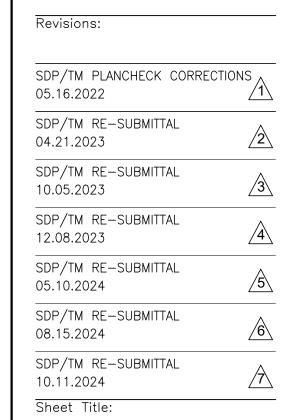

Exterior Elevations

Signatures:

Drawings Prepared By:

Project No.: Checked By: 08.01.2021

A-6


Exterior Elevations


fin. grade

exterior elevation north (front - facing kane st.)

40'-0" max. overall ht. limit

30'-0" max.

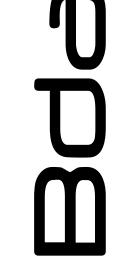

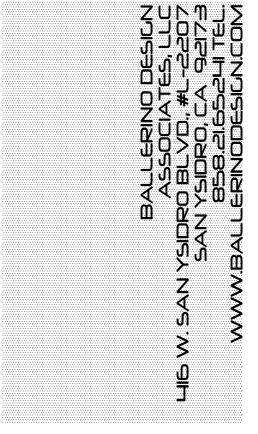

POWELL RESIDENCE Garfield Rd. & Kane St. San Diego, CA

Development Permit (S.D.P.)

SDP/TM PLANCHECK CORRECTIONS 05.16.2022 SDP/TM RE-SUBMITTAL 04.21.2023 SDP/TM RE-SUBMITTAL 10.05.2023 SDP/TM RE-SUBMITTAL 12.08.2023 SDP/TM RE-SUBMITTAL 05.10.2024 SDP/TM RE-SUBMITTAL 08.15.2024 SDP/TM RE-SUBMITTAL 10.11.2024

Exterior Elevations


Signatures:

Drawings Prepared By:


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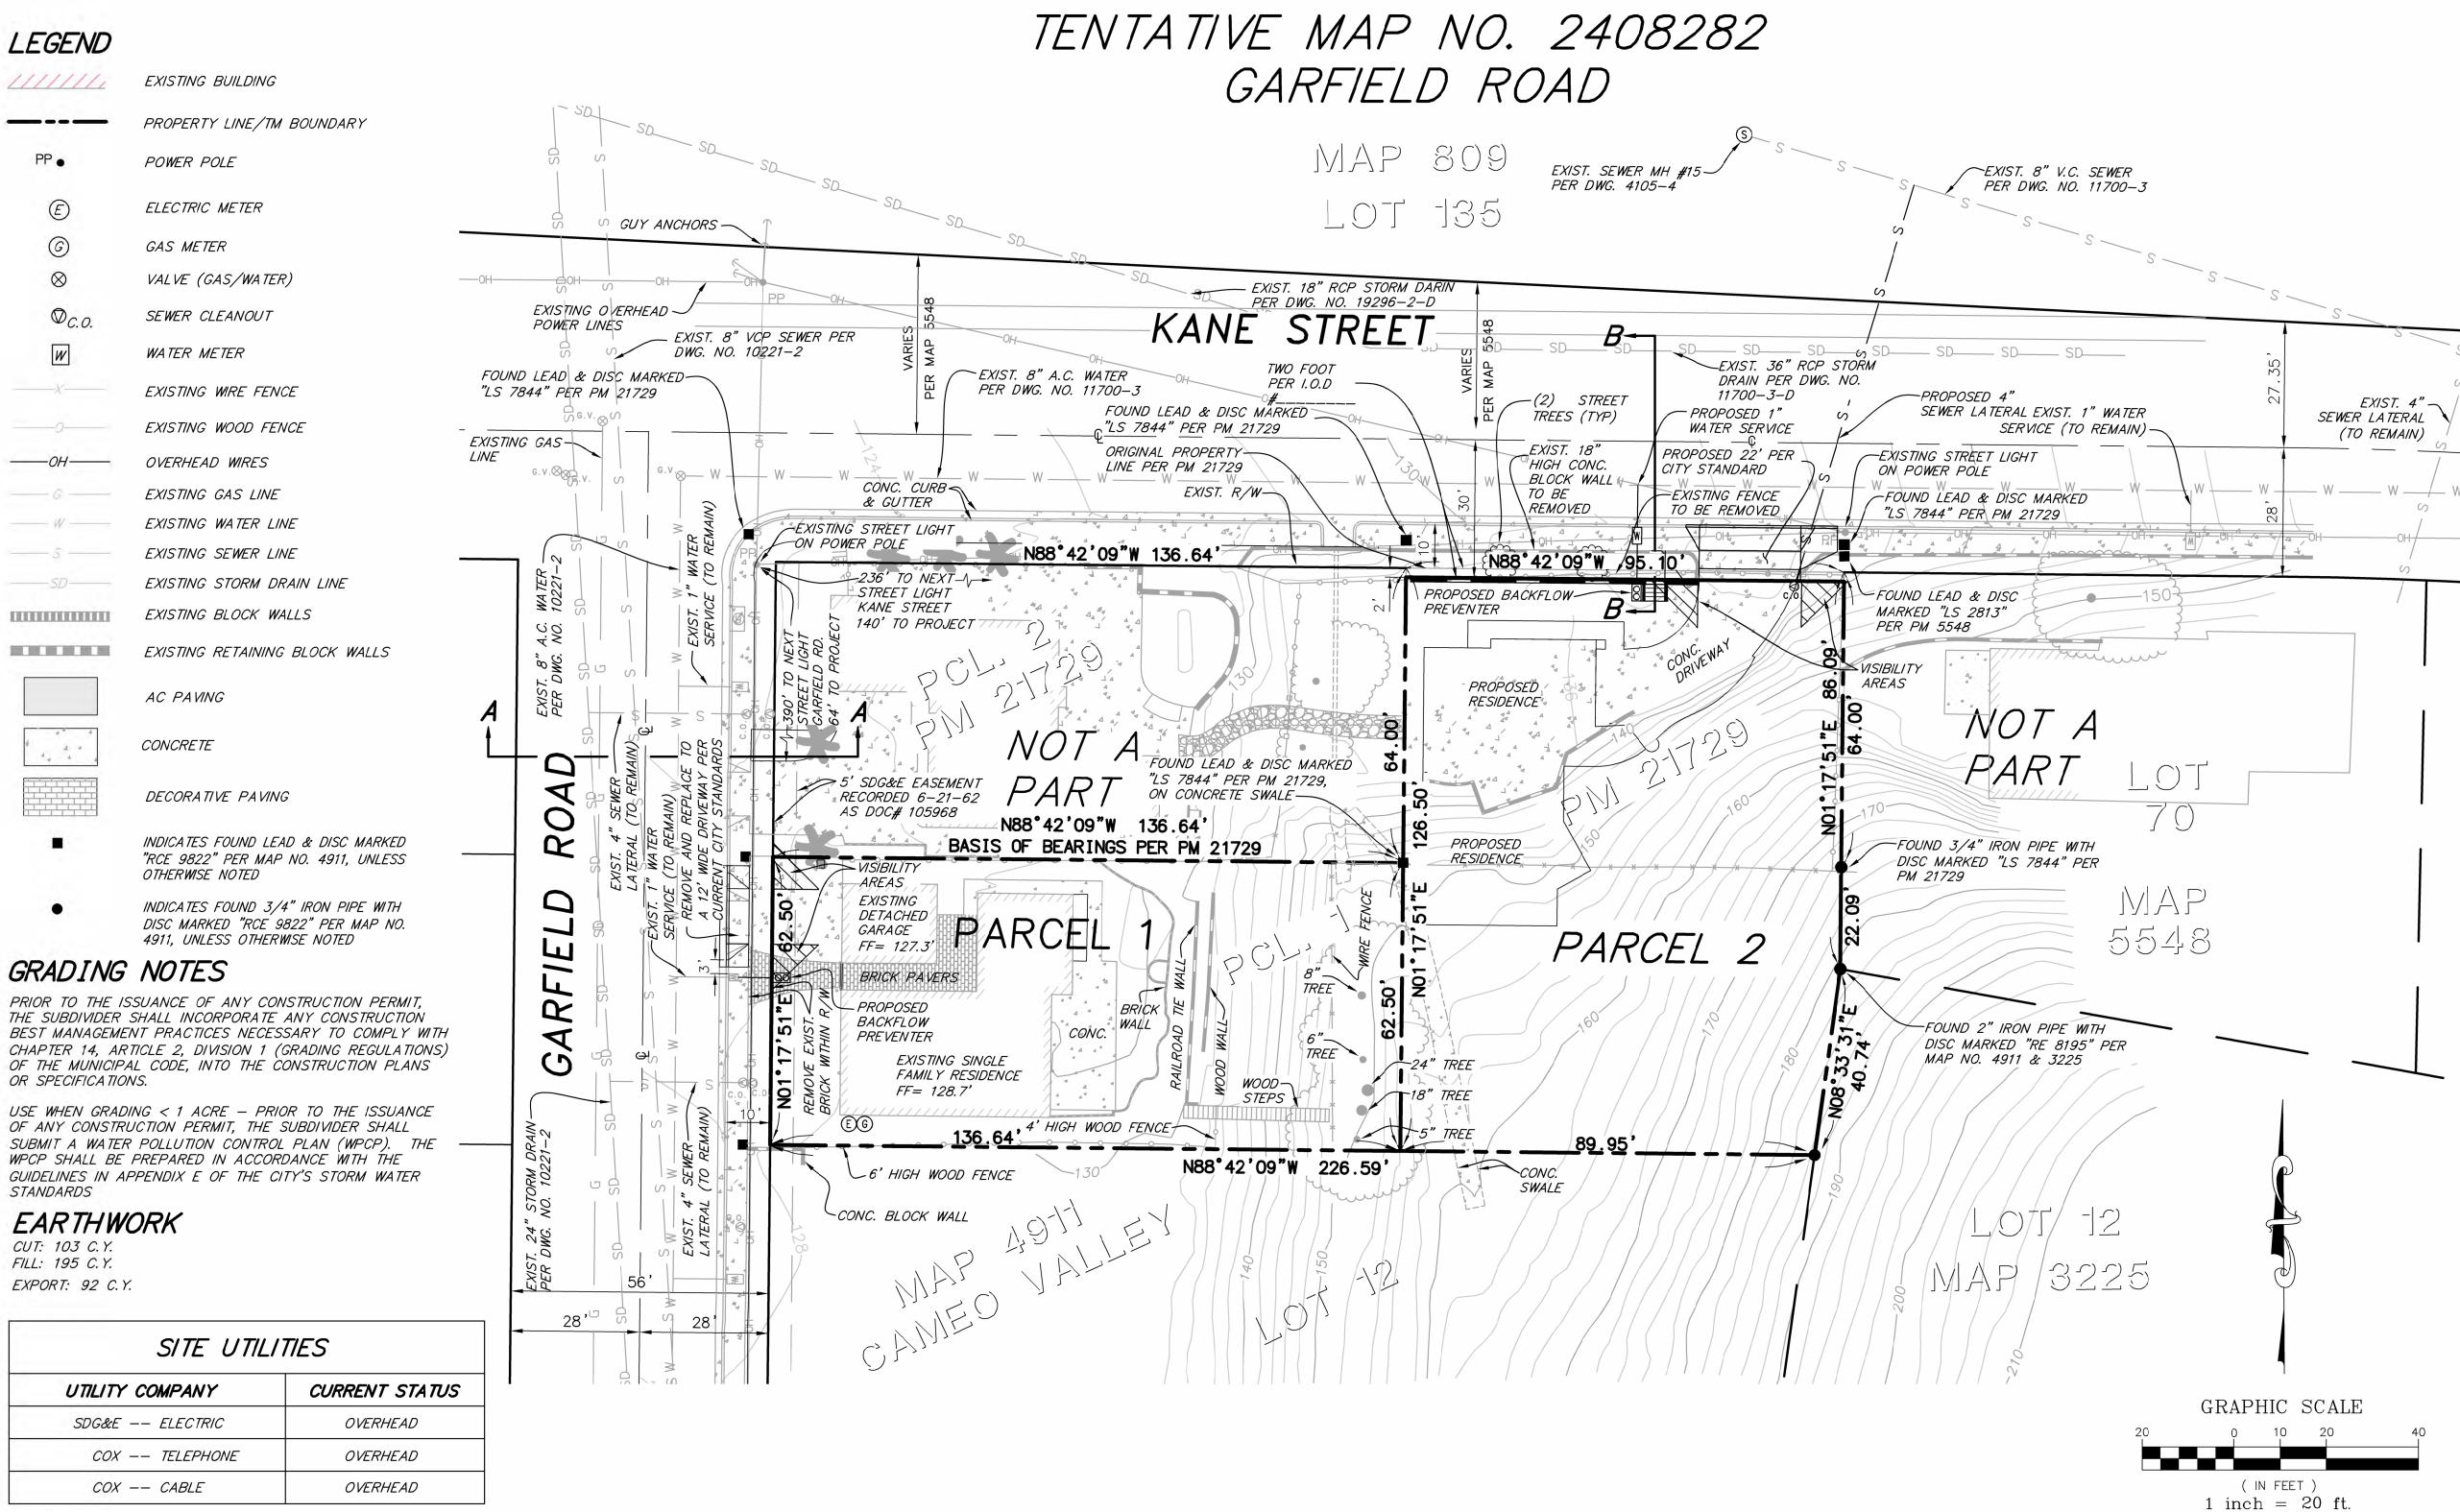
A-7

Exterior Elevations

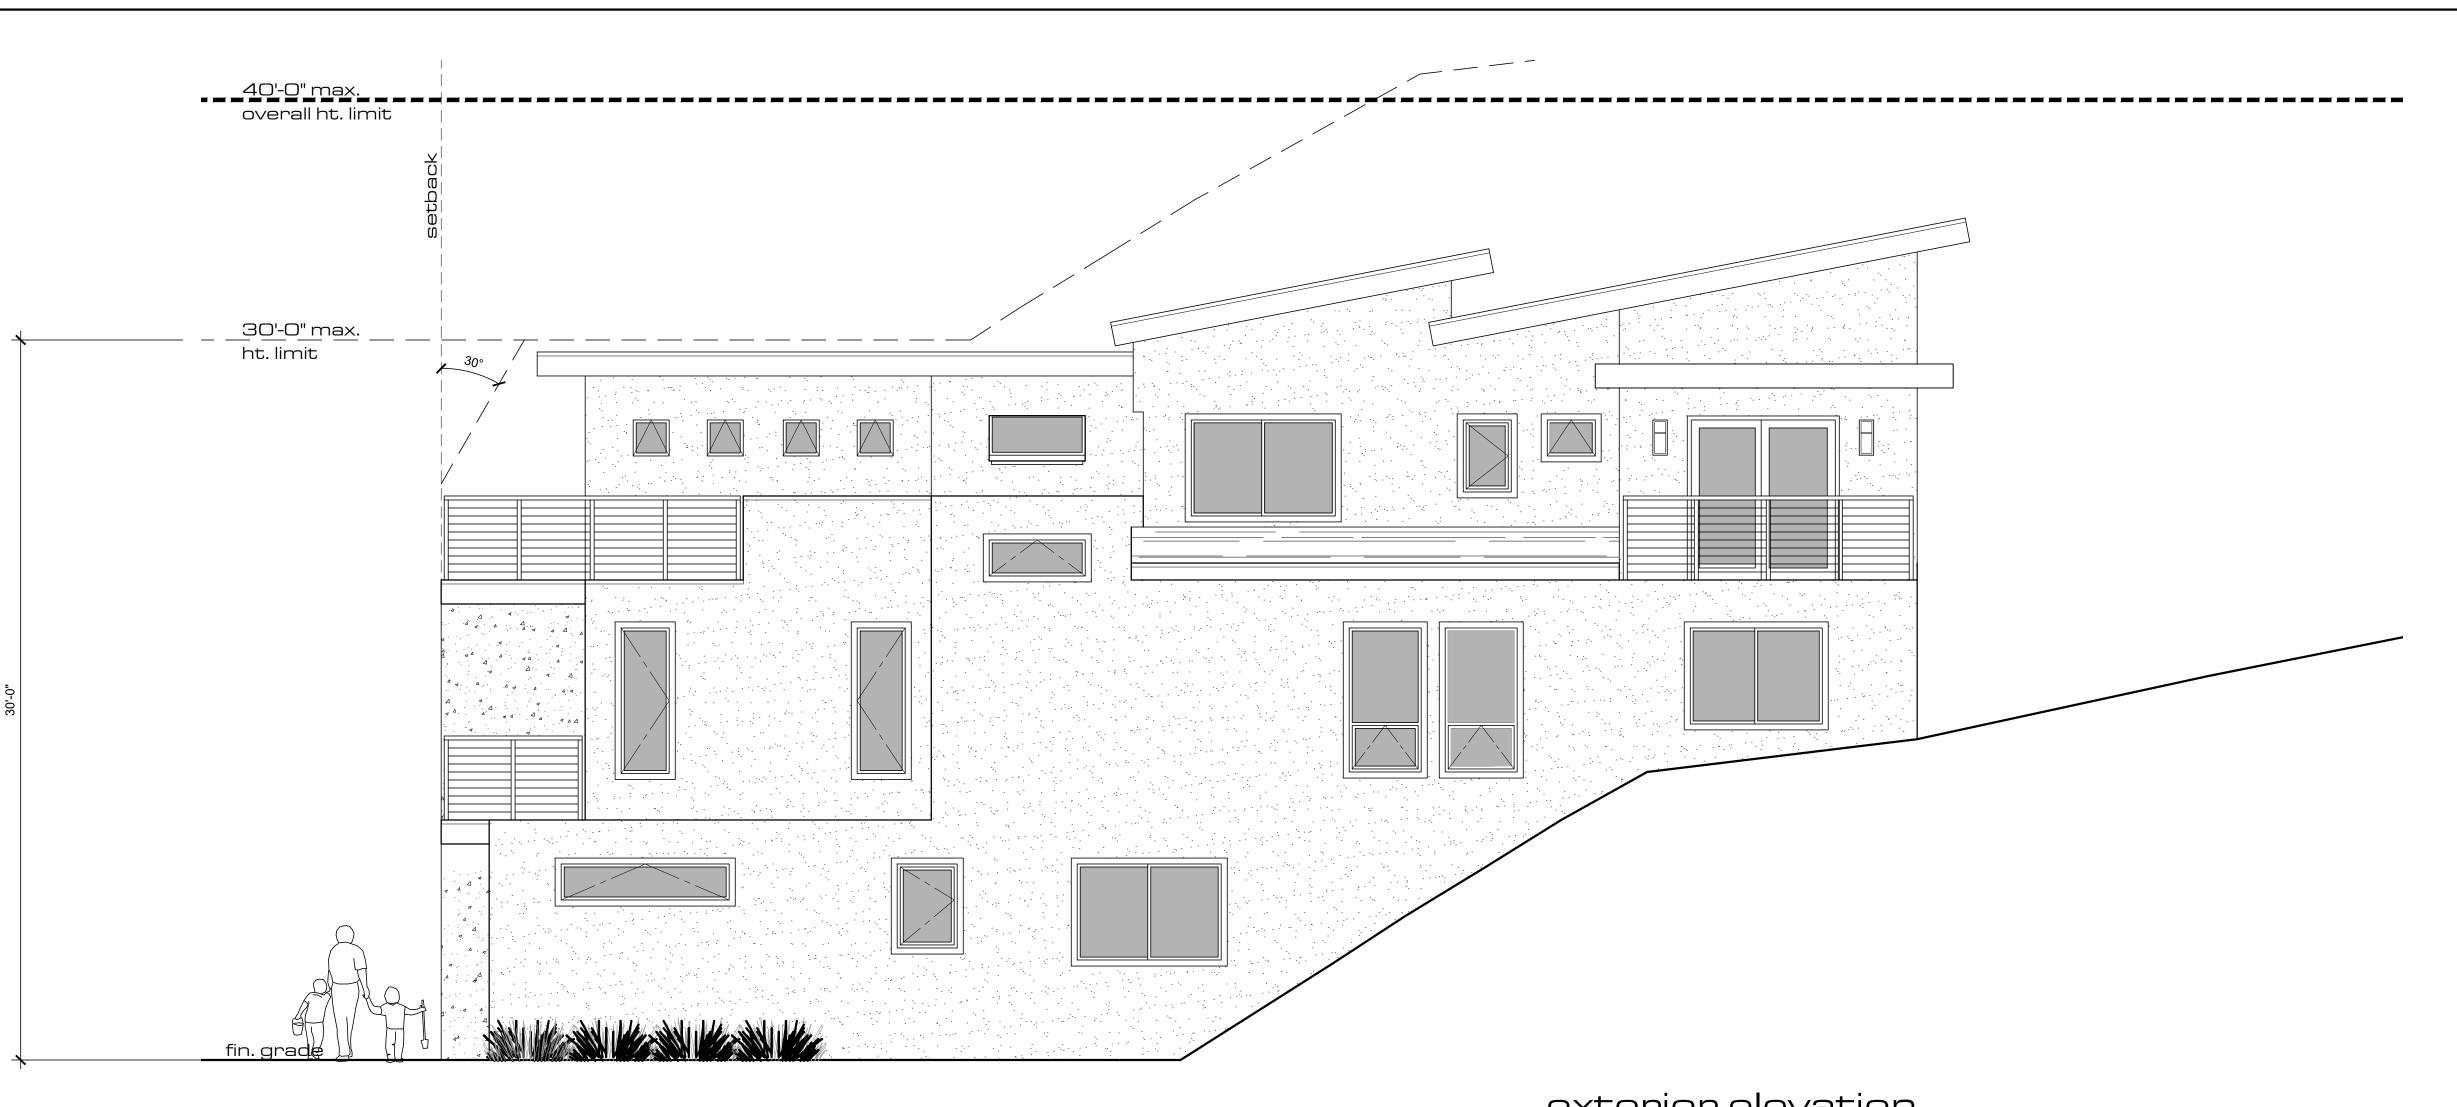

exterior elevation west (right side)



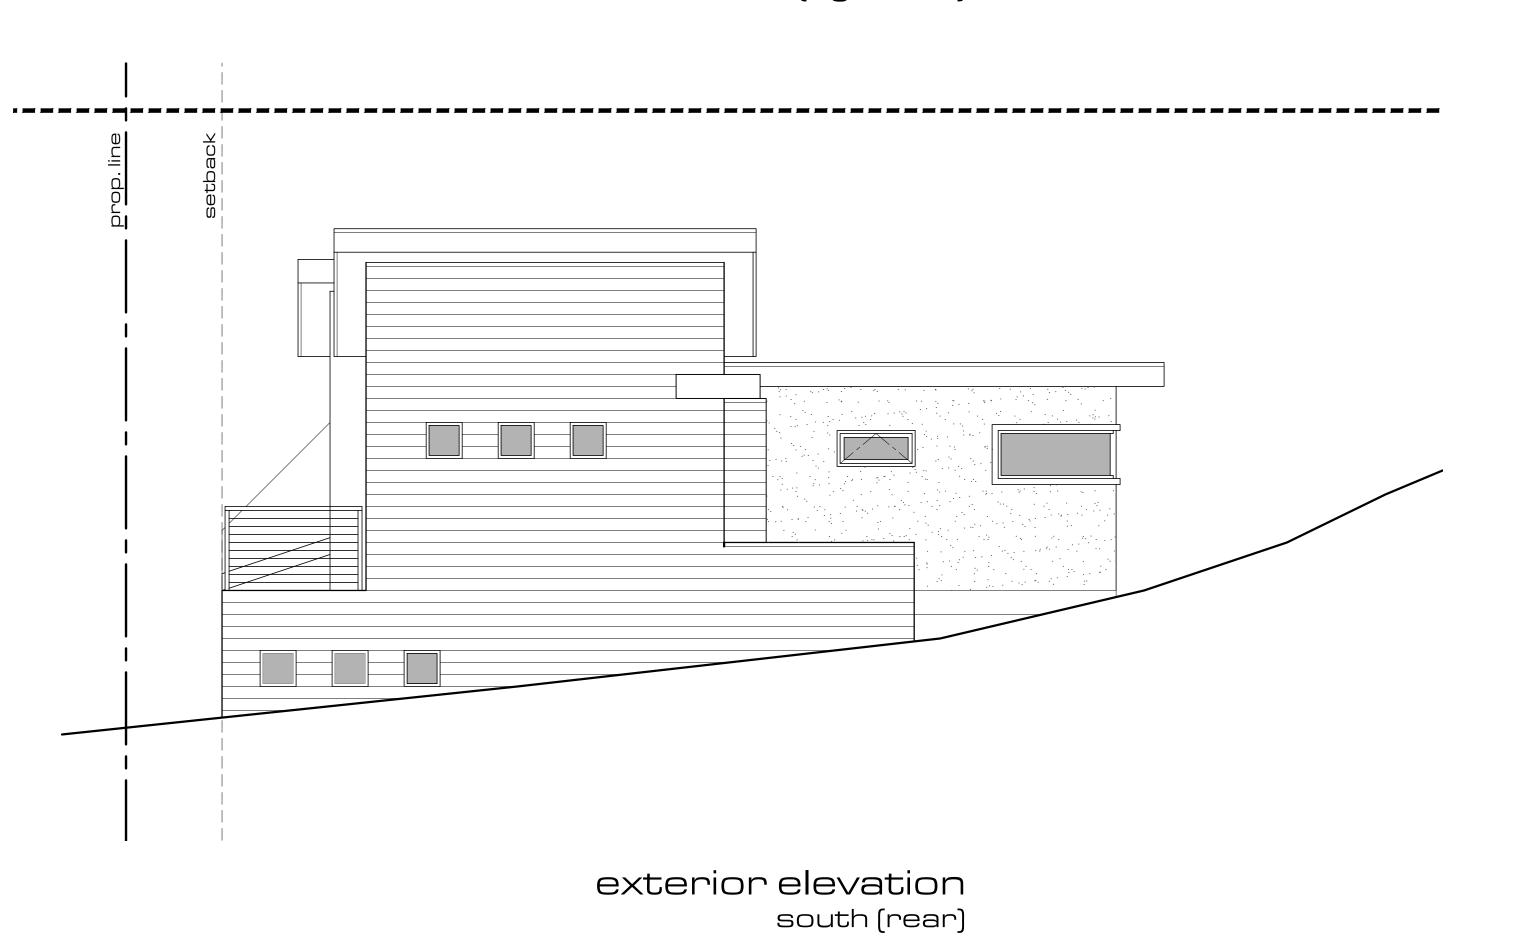

NOTES


- 1. SITE ADDRESS: PARCEL 1 - 2343 GARFIELD ROAD, SAN DIEGO PARCEL 2 — (HOUSE NUMBER TBD) KANE STREET, SAN DIEGO
- SOURCE OF TOPOGRAPHY IS A FIELD SURVEY PERFORMED BY KAPPA SURVEY INC. ON JANUARY 5, 2018.
- UTILITIES: ALL OVERHEAD FACILITIES THAT SERVE THE SITE WILL BE PLACED UNDERGROUND. PARCEL 2
- 4. (1) EXISTING SDG&E 5' WIDE EASEMENT AS SHOWN ON PLAN
- NO PROPOSED EASEMENTS
- NAD 27 COORDINATES: 226-1707 NAD 83 COORDINATES: 1866-6269
- ALSO REQUESTING A WAIVER OF THE CITY UNDERGROUND REQUIREMENT FOR EXISTING MAIN OVERHEAD FACILITIES. PARCEL 1
- NO OBSTRUCTION INCLUDING SOLID WALLS IN THE VISIBILITY AREA SHALL EXCEED 3 FEET IN HEIGHT PER SDMC SECTION 142.0409 (b)(2). PLANT MATERIAL, OTHER THAN TREES, LOCATED WITHIN VISIBILITY AREAS OR THE ADJACENT PUBLIC RIGHT-OF-WAY SHALL NOT EXCEED 36" INCHES IN HEIGHT, MEASURED FROM THE LOWEST GRADE ABUTTING THE PLANT MATERIAL TO THE TOP OF THE PLANT MATERIAL.
- 9. REFERENCE APPROVAL SDP #2574874

LEGAL DESCRIPTION

PARCEL 1 OF PARCEL MAP 21729, IN THE CITY OF SAN DIEGO, IN THE COUNTY OF SAN DIEGO, STATE OF CALIFORNIA, FILED IN THE OFFICE OF THE COUNTY RECORDER OF SAN DIEGO COUNTY OCTOBER 10, 2019.

OWNER

POWELL FAMILY TRUST DATED MAY 17, 2011 2343 GARFIELD ROAD SAN DIEGO, CA 92110 (858) 414-6444

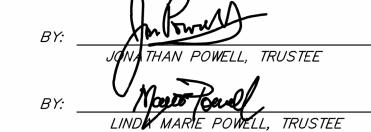

NUMBER OF EXISTING PARCELS = 1

NUMBER OF PROPOSED PARCELS = 2

BASE ZONE: RS-1-7 NO CHANGES PROPOSED

ASSESSOR'S PARCEL NUMBER

TOTAL MAP AREA

PARCEL 2 - 11,925.57 SF/0.27 AC

BASIS OF BEARINGS

THE SOUTHERLY LINE OF PARCEL 2 OF PARCEL MAP 21729

N88°42'09"W.

BENCH MARK FOR THIS SURVEY IS CITY OF SAN DIEGO ENGINEERING DEPARTMENT VERTICAL CONTROL MONUMENT, #12945, A BRASS PLUG AT THE

ELEVATION: 163.777

DATUM: NGVD 29

PROJECT DESCRIPTION

THIS PROJECT IS PROPOSING THE CREATION OF (2) TWO PARCELS. THE OFF-SITE IMPROVEMENT IS THE CONSTRUCTION OF A RESIDENTIAL TYPE DRIVEWAY. ANY NEW ON-SITE UTILITIES WILL BE UNDERGROUNDED. THE PARCEL 2 SITE IS CURRENTLY VACANT.

MAPPING NOTE

ALL PROPERTY CORNERS WILL BE SET AND A TWO LOT PARCEL MAP WILL BE

KAPPA SURVEYING & ENGINEERING, INC. 8402 N. MAGNOLIA AVE. STE C SANTEE, CA 92071


REGISTRATION NUMBER: L.S. 7844 EXPIRATION DATE: EXP. 12/31/2024






TENTATIVE MAP 2343 GARFIELD ROAD

L.C. 226-1709 PROJECT NAD83 1866-6269 PTS #657970

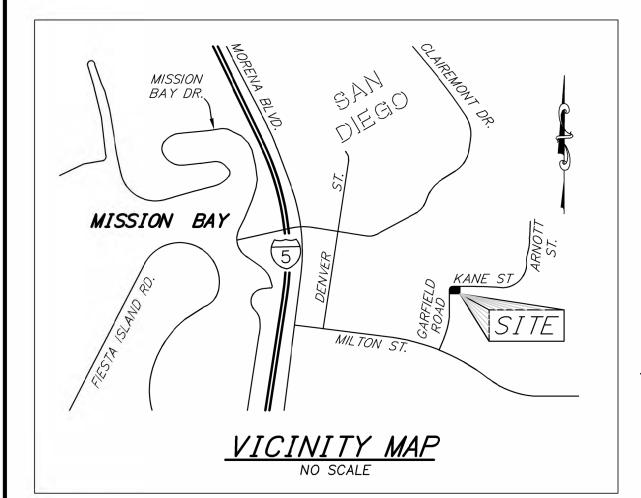

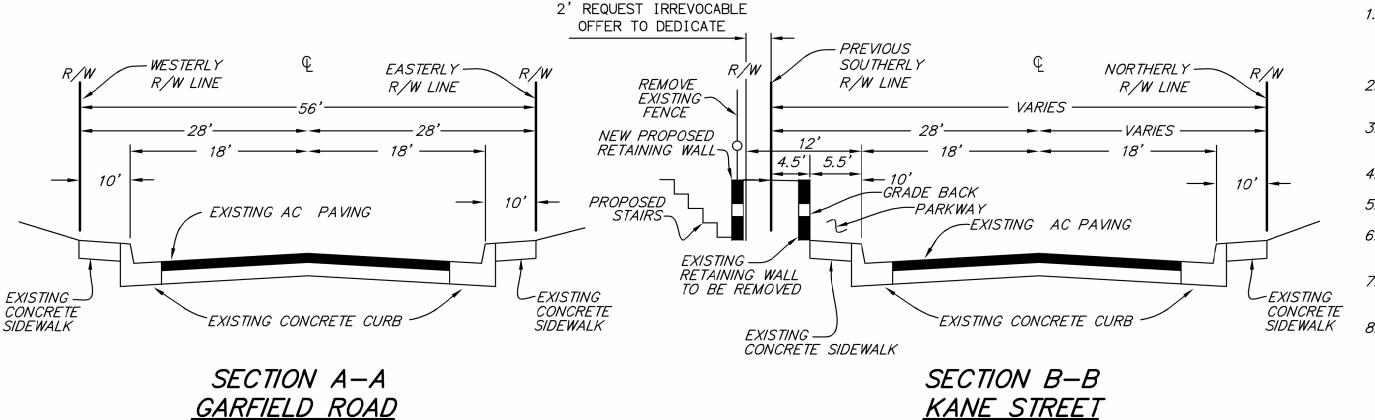

NOT TO SCALE

NOT TO SCALE

ZONING

COMMUNITY PLAN NAME: CLAIREMONT MESA

430-820-13 AND 430-820-28

PARCEL 1 - 8,540.27 SF/0.19 AC

BENCHMARK


SOUTHEASTERLY RETURN OF MILTON STREET AND ILLION STREET.

FILED UPON APPROVAL OF THE TENTATIVE MAP. A DETAILED PROCEDURE OF SURVEY WILL BE SHOWN ON THE PARCEL MAP.


SURVEYOR

TELEPHONE: (619) 449-2600

ALLEN R.A. TURNER III, PLS

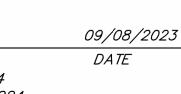


DATE: 09/08/2023 *REVISIONS*

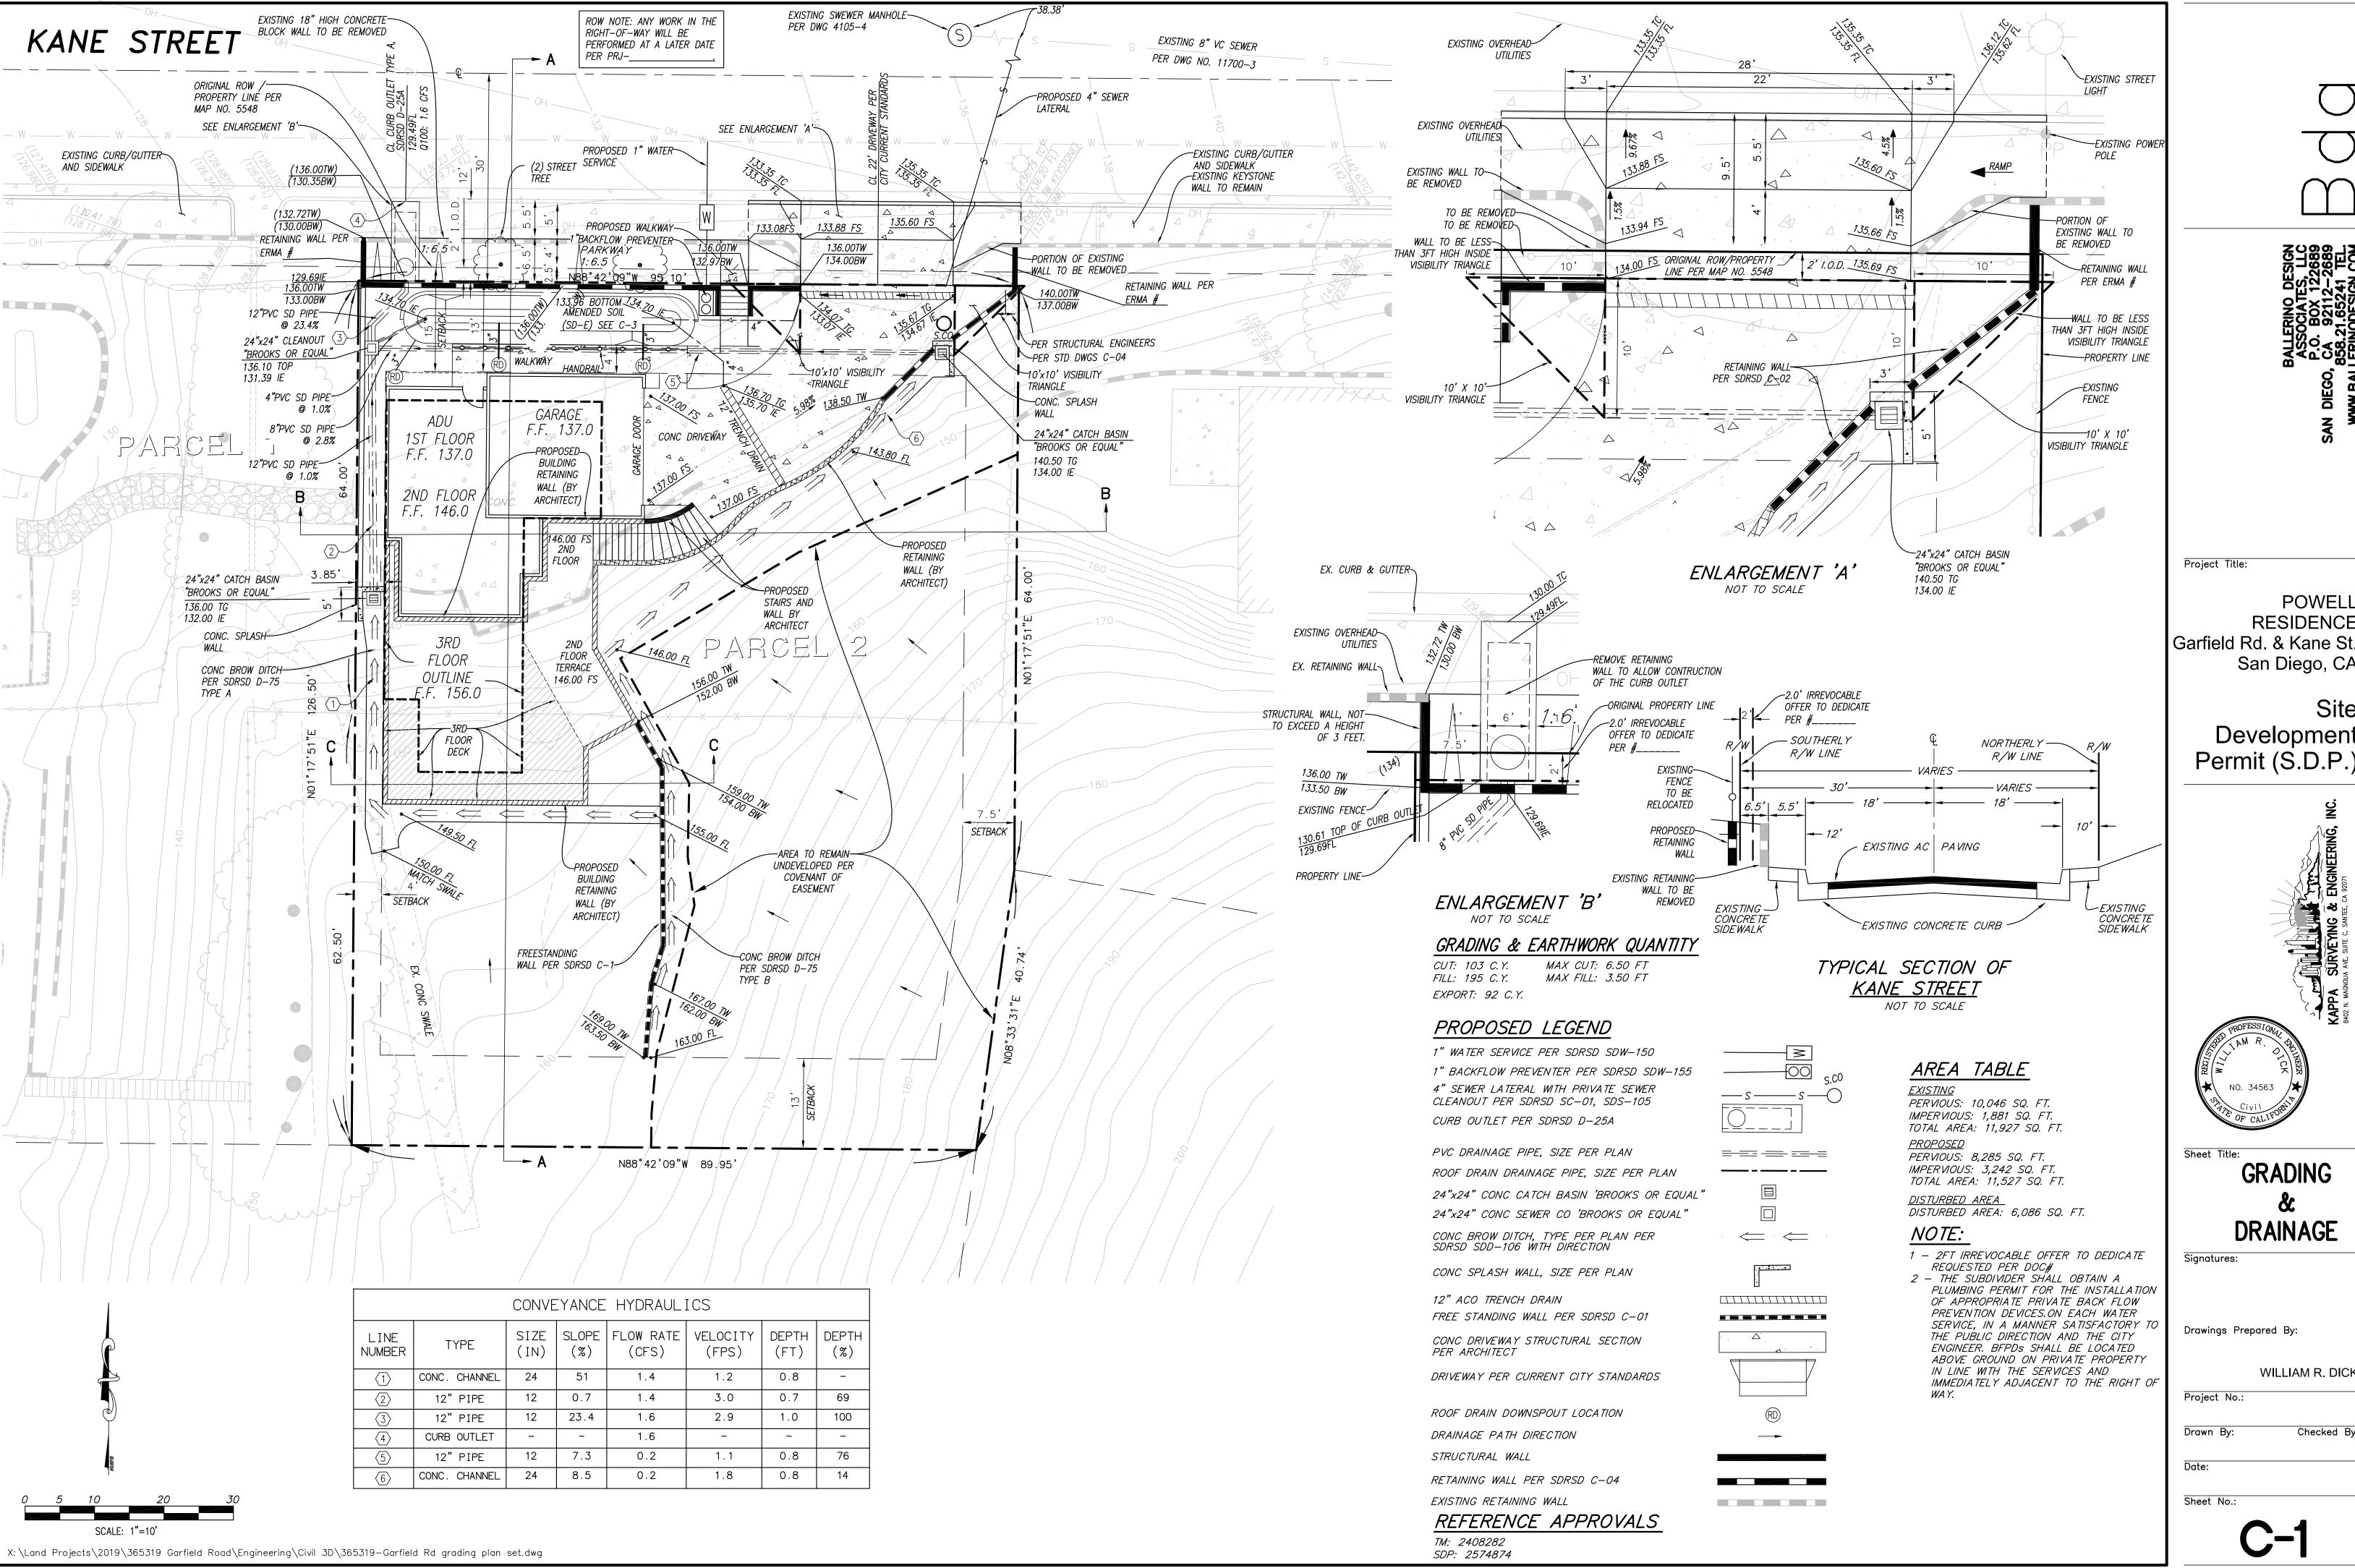


POWELL RESIDENCE San Diego, CA

Development Permit (S.D.P.)

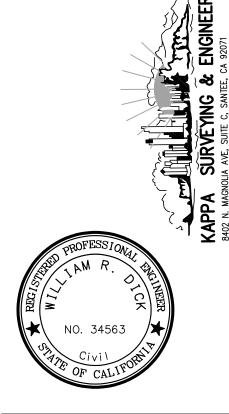

WILLIAM R. DICK


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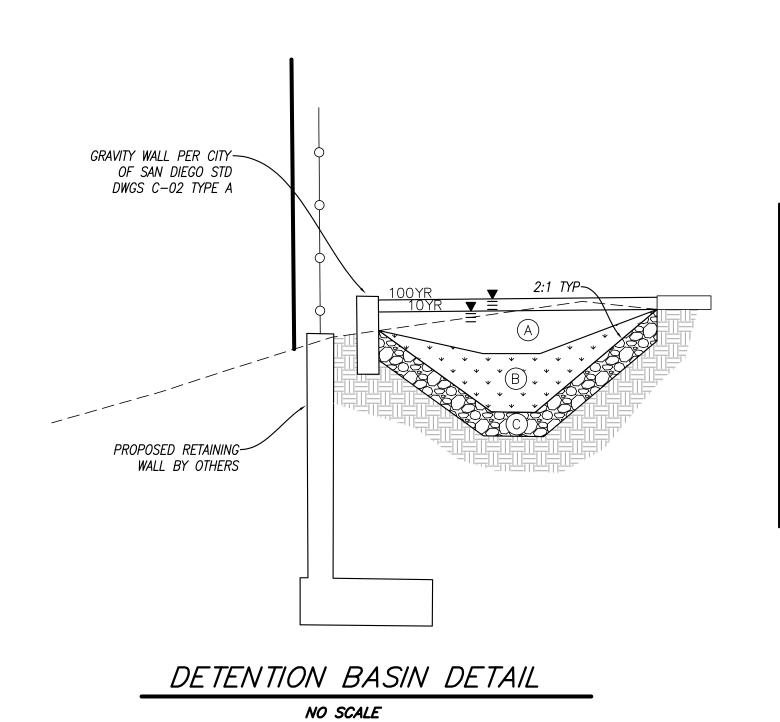


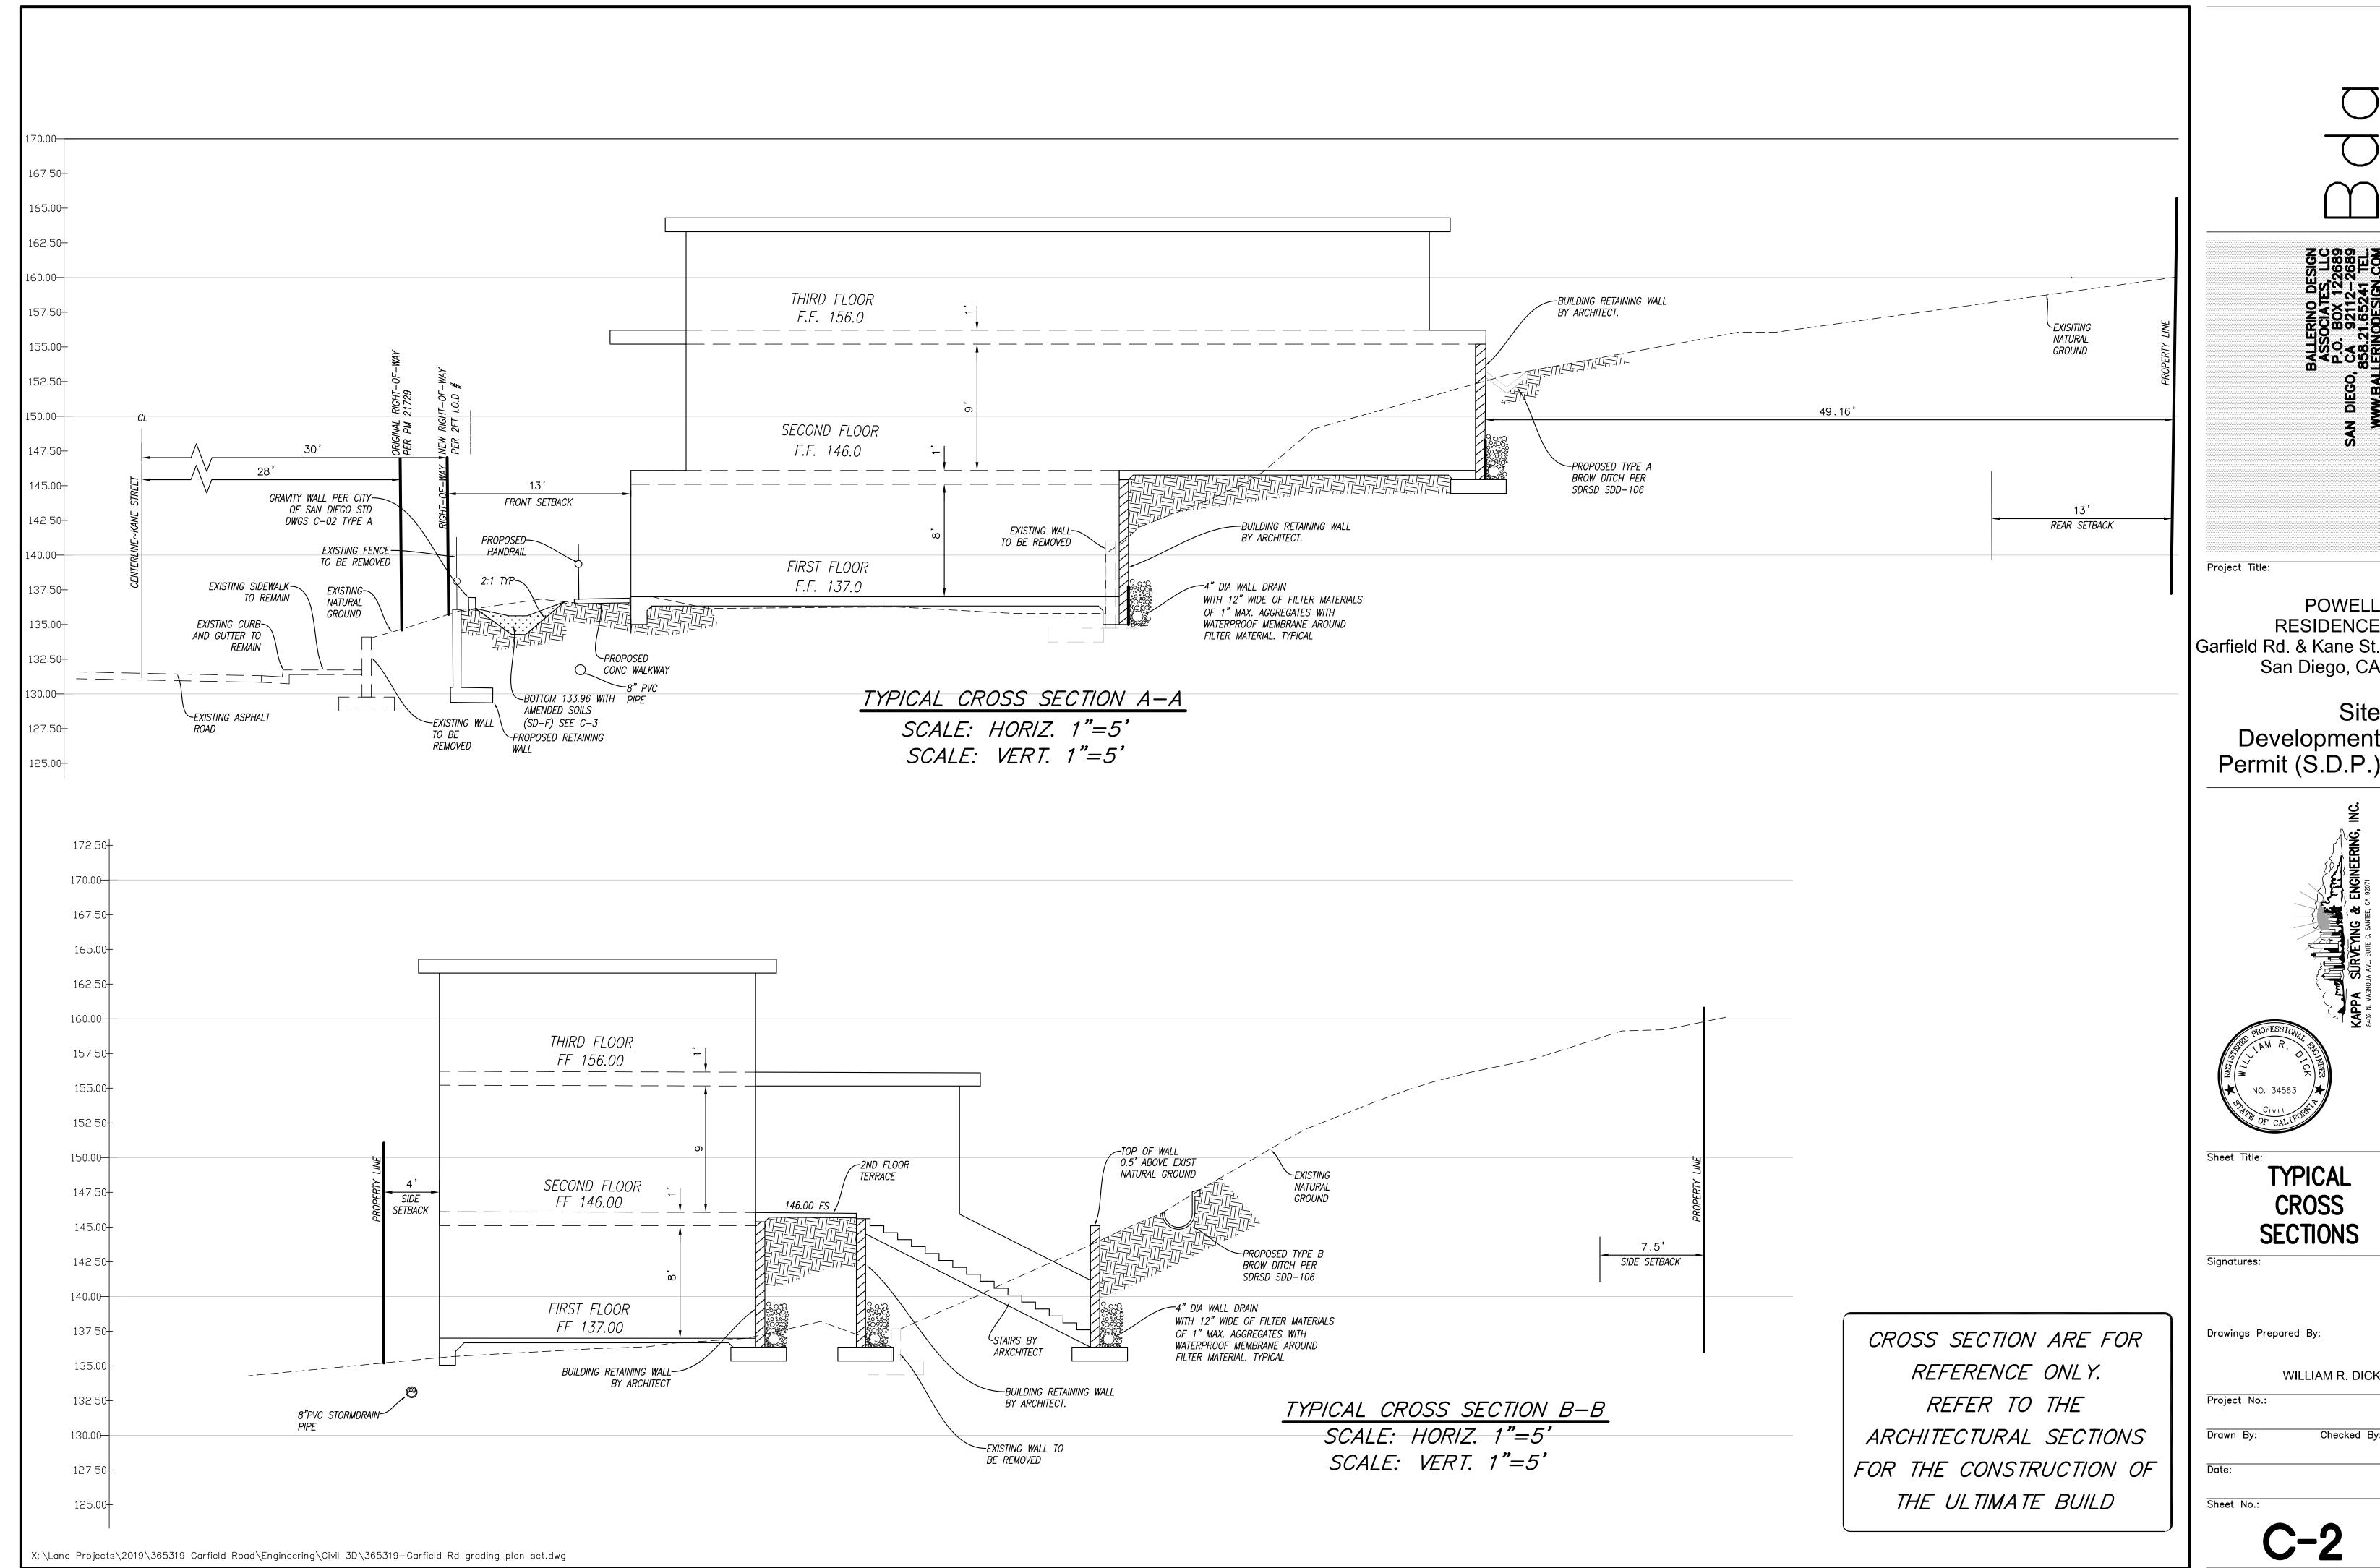POWELL RESIDENCE San Diego, CA

Development Permit (S.D.P.)

WILLIAM R. DICK



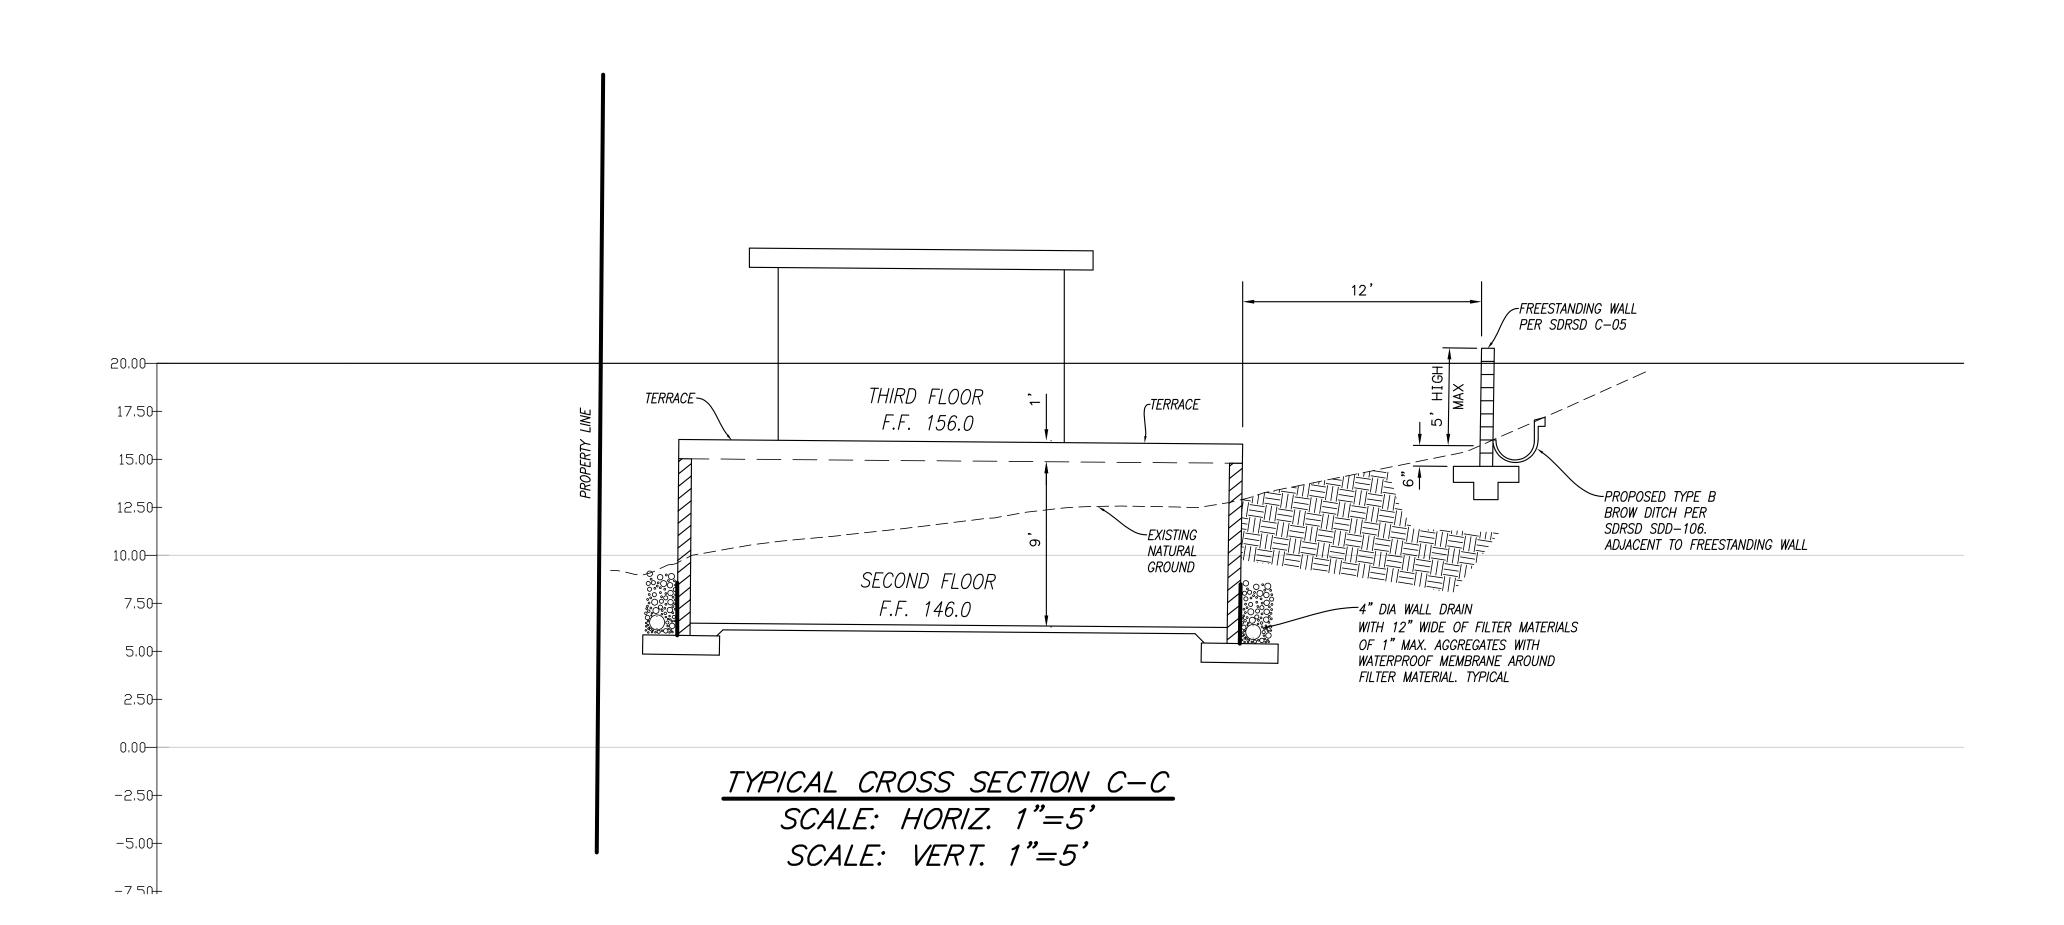

	BASIN DETAIL	_S
		BASIN
	FOOTPRINT SIZE	1000 SF
	MAXIMUM PONDING ELEVATION	135.63
A	PONDING DEPTH/ RISER SIZE	8 INCHES
(B)	* ENGINEERED MEDIA LAYER	12 INCHES
\bigcirc	* FILTER COURSE	6 INCHES
	TOTAL DEPTH OF BASIN	26 INCHES
	OUTLET SIZE	4 INCHES

NOTE:

HANSON A1 BIO RETENTION MIX 8A (PRODUCT CODE

804CY) HAS AN ENGINEERED MEDIA SOIL COMPOSITION

70% WASHED COURSE SAND
20% WANDY LOAM TOPSOIL
10% COMPOST

FILTER COURSE GRAVEL

 3" OF CLEAN AND WASHED ASTM 33 FINE AGGREGATE SAND.

- 3" OF ASTM NO 8 STONE

CROSS SECTION ARE FOR


REFERENCE ONLY.

REFER TO THE

ARCHITECTURAL SECTIONS

FOR THE CONSTRUCTION OF

THE ULTIMATE BUILD

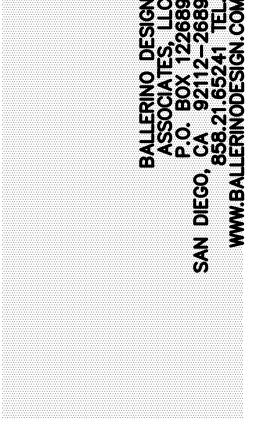

Project Title:

POWELL RESIDENCE Garfield Rd. & Kane St. San Diego, CA

Development Permit (S.D.P.)



TYPICAL CROSS SECTIONS

Signatures:

Drawings Prepared By:

WILLIAM R. DICK


Project No.:

Drawn By: Checke

Date:

Sheet No:


C-3

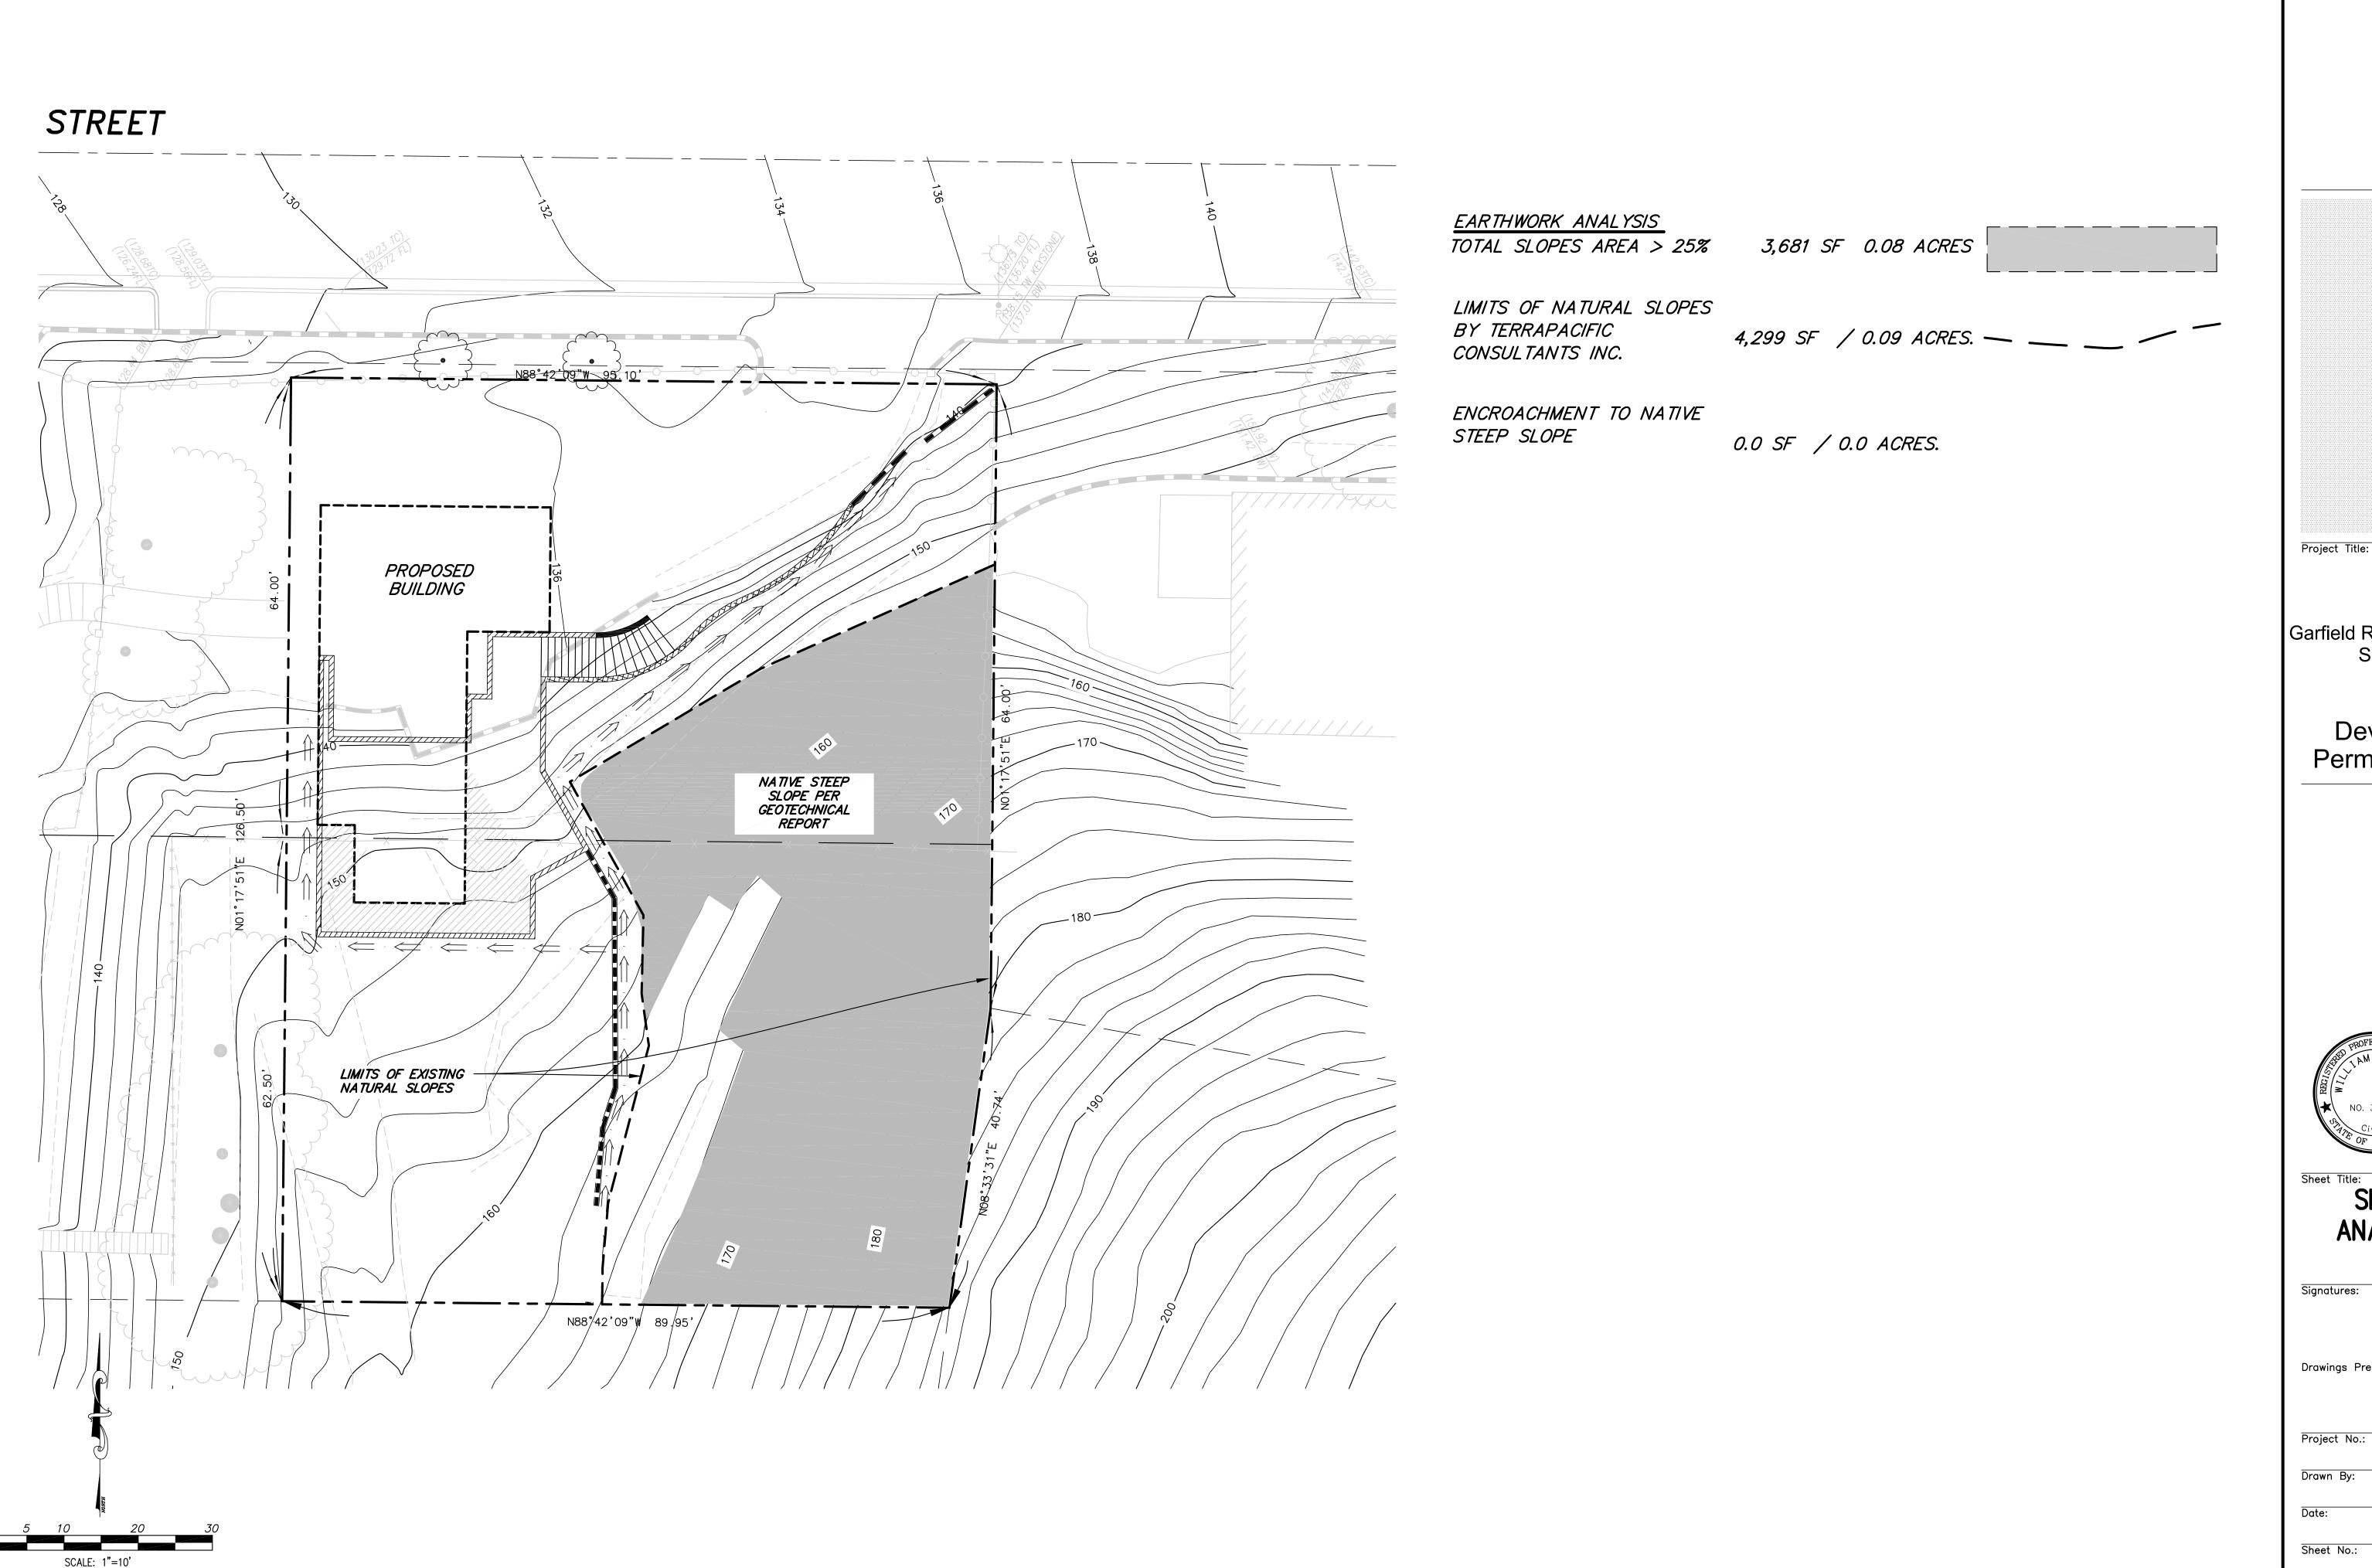

 $\hbox{X: \lambda} \label{thm:cond} \hbox{X: \lambda} \label{thm:cond} \hbox{Projects.} \\ 2019 \label{thm:cond.} \hbox{365319-Garfield Rd grading plan set.dwg}$

POWELL RESIDENCE Garfield Rd. & Kane St. San Diego, CA

> Site Development Permit (S.D.P.)

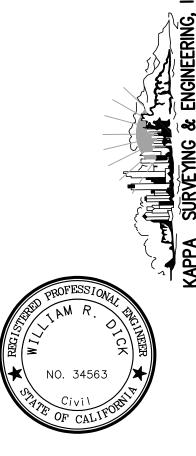

SLOPE **ANALYSIS**

Drawings Prepared By:

WILLIAM R. DICK

CONSTRUCTION BMP GENERAL NOTES

PRIOR TO ANY SOIL DISTURBANCE, TEMPORARY EROSION AND SEDIMENT CONTROLSHALL BE INSTALLED BY THE CONTRACTOR OR QUALIFIED PERSON(S) AS INDICATED BELOW:

1. ALL REQUIREMENTS OF THE CITY OF SAN DIEGOAND DEVELOPMENT MANUAL, STORM WATER STANDARDS" MUST BE INCORPORATED INTO THE DESIGN AND CONSTRUCTION OF THE PROPOSED GRADING/IMPROVEMENTS CONSISTENT WITH THE APPROVED STORM WATER POLLUTION PREVENTION PLAN (SWPPP) AND/OR WATER POLLUTION CONTROL PLAN (WPCP) FOR CONSTRUCTION LEVEL BMP'S AND, IF APPLICABLE, THE STORM WATER QUALITY MANAGEMENT PLAN (SWQMP) FOR POST CONSTRUCTION TREATMENT CONTROL BMP'S.

2. THE CONTRACTOR SHALL INSTALL AND MAINTAIN ALL STORM DRAIN INLETS, INLET PROTECTION IN THE PUBLIC RIGHT OF WAY MAY BE TEMPORARILY REMOVED WHERE IT IS PRONE TO FLOODING PRIOR TO A RAIN EVENT AND REINSTALLED AFTER RAIN IS OVER.

- 3. ALL CONSTRUCTION BMPS SHALL BE IN PLACE AT THE END OF EACH WORKING DAY WHEN RAIN IS IMMINENT.
- 4. THE CONTRACTOR SHALL ONLY GRADE, INCLUDING CLEARING AND GRUBBING, AREAS FOR WHICH THE CONTRACTOR OR QUALIFIED PERSON CAN PROVIDE EROSION AND SEDIMENT CONTROL MEASURES.

5. THE CONTRACTOR IS RESPONSIBLE FOR ENSURING THAT ALL SUB-CONTRACTORS AND SUPPLIERS ARE AWARE OF ALL STORM WATER QUALITY MEASURES AND IMPLEMENT SUCH MEASURES, FAILURE TO COMPLY WITH THE APPROVED SWPPP/WPCP WILL RESULT IN THE ISSUANCE OF CORRECTION NOTICES, CITATIONS, CIVIL PENALTIES AND/OR STOP WORK NOTICES.

6. THE CONTRACTOR OR QUALIFIED PERSON SHALL BE RESPONSIBLE FOR CLEANUP OF ALL SILT, DEBRIS AND MUD ON AFFECTED AND ADJACENT STREET(S) AND WITHIN STORM DRAIN SYSTEM DUE TO CONSTRUCTION VEHICLES/EQUIPMENT AND CONSTRUCTION ACTIVITY AT THE END OF EACH WORK DAY.

7. THE CONTRACTOR SHALL PROTECT NEW AND EXISTING STORM WATER CONVEYANCE SYSTEMS FROM SEDIMENTATION, CONCRETE RINSE, OR OTHER CONSTRUCTION RELATED DEBRIS AND DISCHARGES WITH THE APPROPRIATE BMPS THAT ARE ACCEPTABLE TO THE ENGINEER AND AS INDICATED IN THE

SWPPP/WPCP 8. THE CONTRACTOR OR QUALIFIED PERSON SHALL CLEAR DEBRIS, SILT AND MUD FROM ALL DITCHES AND SWALES PRIOR TO AND AFTER EACH RAIN EVENT.

9. IF A NON-STORM WATER DISCHARGE LEAVES THE SITE, THE CONTRACTOR SHALL IMMEDIATELY STOP THE ACTIVITY AND REPAIR THE DAMAGES. THE CONTRACTOR SHALL IMMEDIATELY NOTIFY THE ENGINEER OF THE DISCHARGE. AS SOON AS PRACTICAL, ANY AND ALL WASTE MATERIAL, SEDIMENT AND DEBRIS FROM EACH NON STORM WATER DISCHARGE SHALL BE REMOVED FROM THE STORM DRAIN CONVEYANCE SYSTEM AND PROPERLY DISPOSED OF BY THE CDNTRACTDR.

10. EQUIPMENT AND WORKERS FOR EMERGENCY WORK SHALL BE MADE AVAILABLE AT ALL TIMES, ALL NECESSARY MATERIALS SHALL BE STOCKPILED ON SITE AT CONVENIENT LOCATIONS TO FACILITATE RAPID DEPLOYMENT OF CONSTRUCTION BMPS WHEN RAIN IS IMMINENT.

- 11. THE CONTRACTOR SHALL RESTORE AND MAINTAIN ALL EROSION AND SEDIMENT CONTROL BMPS TO WORKING ORDER YEAR ROUND.
- 12. THE CONTRACTOR SHALL INSTALL ADDITIONAL EROSION AND SEDIMENT CONTROL MEASURES DUE TO GRADING INACTIVITY OR UNFORESEEN CIRCUMSTANCES TO PREVENT NON-STORM WATER AND SEDIMENT-LADEN DISCHARGES.

13. THE CONTRACTOR SHALL BE RESPONSIBLE AND SHALL TAKE NECESSARY PRECAUTIONS TO PREVENT PUBLIC TRESPASS ONTO AREAS WHERE IMPOUNDED WATERS CREATE A HAZARDOUS CONDITION.

14. ALL EROSION AND SEDIMENT CONTROL MEASURES PROVIDED PER THE APPROVED SWPPP/WPCP SHALL BE INSTALLED AND MAINTAINED. ALL EROSION AND SEDIMENT CONTROL FOR INTERIM CONDITIONS SHALL BE PROPERLY DOCUMENTED AND INSTALLED TO THE SATISFACTION OF THE RESIDENT ENGINEER.

15. UPON NOTIFICATION BY THE RESIDENT ENGINEER, THE CONTRACTOR SHALL ARRANGE FOR MEETINGS DURING OCTOBER 1ST TO APRIL 30TH FOR PROJECT TEAM (GENERAL CONTRACTOR, QUALIFIED PERSON, EROSION CONTROL SUBCONTRACTOR IF ANY, ENGINEER OF WORK, OWNER/DEVELOPER AND THE RESIDENT ENGINEER) TO EVALUATE THE ADEQUACY OF THE EROSION AND SEDIMENT CONTROL MEASURES AND OTHER BMPS RELATIVE TO ANTICIPATED CONSTRUCTION

16. THE CONTRACTOR SHALL CONDUCT VISUAL INSPECTIONS DAILY AND MAINTAIN ALL BMPS AS NEEDED. VISUAL INSPECTIONS AND MAINTENANCE OF ALL BMPS SHALL BE CONDUCTED BEFORE, DURING AND AFTER EVERY RAIN EVENT AND EVERY 24 HOURS DURING ANY PROLONGED RAIN EVENT. THE CONTRACTOR SHALL MAINTAIN AND REPAIR ALL BMPS AS SOON AS POSSIBLE AS SAFETY ALLOWS.

17. CONSTRUCTION ENTRANCE AND EXIT AREA, TEMPORARY CONSTRUCTION ENTRANCE AND EXIT AREA SHALL BE ON LEVEL, STABILIZED GROUND. THE ENTRANCE AND EXIT AREA SHALL BE CONSTRUCTED BY OVERLAYING THE STABILIZED ACCESS AREA WITH 3DTAMETER STONES. THE AREA SHALL BE MINIMUM 50' LONG X 30' WIDE. IN LIEU OF STONE COVERED AREA, THE CONTRACTOR MAY CONSTRUCT RUMBLE RACKS OF STEEL PANELS WITH RIDGES MINIMUM 20' LONG X 30' WIDE CAPABLE OF PREVENTING THE MIGRATION OF CONSTRUCTION MATERIALS INTO THE TRAVELED WAYS.

18. PERFORMANCE STANDARDS. THE CONTRACTOR SHALL BE RESPONSIBLE FOR IMPLEMENTING WATER POLLUTION CONTROL MEASURES BASED ON PERFURMANCE STANDARDS, PERFURMANCE STANDARDS SHALL INCLUDE:

A. NON-STORM WATER DISCHARGES FROM THE SITE SHALL NOT OCCUR TO THE MEP3, STORM WATER DISCHARGES SHALL BE FREE OF POLLUTANTS INCLUDING SEDIMENT TO THE MEP.

B. EROSION SHALL BE CONTROLLED BY ACCEPTABLE BMPS TO THE MEP. IF RILLS AND GULLIES APPEAR THEY SHALL BE REPAIRED AND ADDITIONAL BMPS INSTALLED TO PREVENT A REOCCURRENCE OF EROSION.

C. AN INACTIVE AREA SHALL BE PROTECTED TO PREVENT POLLUTANT DISCHARGES. A SITE OR PORTIONS OF A SITE SHALL BE CONSIDERED INACTIVE WHEN CONSTRUCTION ACTIVITIES HAVE CEASED FOR A PERIOD OF 14 OR MORE CONSECUTIVE DAYS.

GRADING NOTES

GRADING AS SHOWN ON THESE PLANS SHALL BE IN CONFORMANCE WITH CURRENT STANDARD SPECIFICATIONS AND CHAPTER 14, ARTICLE 2, DIVISION 1, OF THE SAN DIEGO MUNICIPAL CODE.

2. PLANT AND IRRIGATE ALL CUT AND FILL SLOPES AS REQUIRED BY ARTICLE 2, DIVISION 4, SECTION 142.0411 OF THE SAN DIEGO LAND DEVELOPMENT CODE AND ACCORDING TO SECTION IV OR THE LAND DEVELOPMENT MANUAL LANDSCAPE STANDARDS.

3. GRADED, DISTURBED, OR ERODED AREAS THAT WILL NOT BE PERMANENTLY PAVED, COVERED BY STRUCTURE, OR PLANTED FOR A PERIOD OVER 90 DAYS SHALL BE TEMPORARILY RE-VEGETATED WITH A NON-IRRIGATED HYDROSEED MIX, GROUND COVER, OR EQUIVALENT MATERIAL. SEE SHEET ___ FOR MIX AND SPECIFICATIONS.

MINIMUM POST-CONSTRUCTION MAINTENANCE PLAN

AT THE COMPLETION OF THE WORK SHOWN, THE FOLLOWING PLAN SHALL BE FOLLOWED TO ENSURE WATER QUALITY CONTROL IS MAINTAINED FOR THE LIFE OF THE PROJECT:

1. STABILIZATION: ALL PLANTED SLOPES AND OTHER VEGETATED AREAS SHALL BE INSPECTED PRIOR TO OCTOBER 1 OF EACH YEAR AND AFTER MAJOR RAINFALL EVENTS (MORE THAN ½ INCH) AND REPAIRED AND REPLANTED AS NEEDED UNTIL A NOTICE OF TERMINATION (NOT) IS FILED.


2. STRUCTURAL PRACTICES: DESILTING BASINS, DIVERSION DITCHES, DOWNDRAINS, INLETS, OUTLET PROTECTION MEASURES, AND OTHER PERMANENT WATER QUALITY AND SEDIMENT AND EROSION CONTROLS SHALL BE INSPECTED PRIOR TO OCTOBER 1ST OF EACH YEAR AND AFTER MAJOR RAINFALL EVENTS (MORE THAN 1/2 INCH). REPAIRS AND REPLACEMENTS SHALL BE MADE AS NEEDED AND RECORDED IN THE MAINTENANCE LOG IN PERPETUITY.

3. OPERATION AND MAINTENANCE, FUNDING: POST-CONSTRUCTION MANAGEMENT MEASURES ARE THE RESPONSIBILITY OF THE DEVELOPER UNTIL THE TRANSFER OF RESPECTIVE SITES TO HOME BUILDERS, INDIVIDUAL OWNERS, HOMEOWNERS ASSOCIATIONS, SCHOOL DISTRICTS, OR LOCAL AGENCIES AND/OR GOVERNMENTS. AT THAT TIME, THE NEW OWNERS SHALL ASSUME RESPONSIBILITY FOR THEIR RESPECTIVE PORTIONS OF THE DEVELOPMENT.

PRIVATE NOTE

ALL ONSITE, PRIVATE IMPROVEMENTS SHOWN ON THIS DRAWING ARE FOR INFOMRATION ONLY. THE CITY ENGINEER'S APPROVAL OF THIS DRAWING. IN NO WAY CONSTITUTES AN APPROVAL OF SAID PRIVATE IMPROVEMENTS. A SEPARATE PERMIT FOR SUCH IMPROVEMENTS MAY BE REQUIRED.

	AGREEN	MENT DA	TA		
APPR□VAL TYPE	DESCRIPTION	APPROVAL NO.	DOCUMENT NO.	SEE SHEET	NUMBER(S)

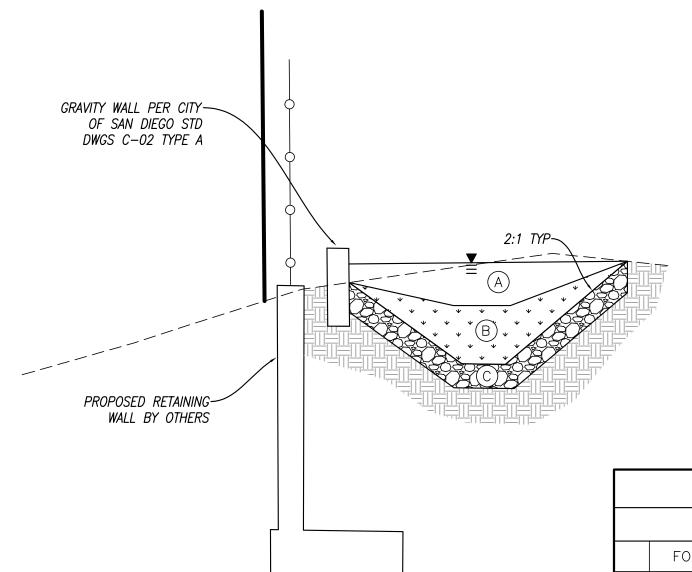

DETENTION BASIN DETAIL NO SCALE

	BASIN DETAILS		
		BASIN	
	FOOTPRINT SIZE	1000 SF	
	MAXIMUM PONDING ELEVATION	135.63	
)	PONDING DEPTH/ RISER SIZE	8 INCHES	
)	* ENGINEERED MEDIA LAYER	12 INCHES	
)	* FILTER COURSE	6 INCHES	
	TOTAL DEPTH OF BASIN	26 INCHES	
	OUTLET SIZE	4 INCHES	

HANSON A1 BIO RETENTION MIX 8A (PRODUCT CODE 804CY) HAS AN ENGINEERED MEDIA SOIL COMPOSITION

- 70% WASHED COURSE SAND
- 20% WANDY LOAM TOPSOIL - 10% COMPOST

FILTER COURSE GRAVEL

- 3" OF CLEAN AND WASHED ASTM 33 FINE
- AGGREGATE SAND. - 3" OF ASTM NO 8 STONE

SOURCE CONTROL	BMP CHECKLIST FOR STANDARD PROJECTS
SOUNCE CONTINUL	, DMF CHECKLIST FOR STANDARD FROJECTS

NOTE: ALL SELECTED BMPS MUST BE SHOWN ON THE CONSTRUCTION PLANS

FORM I-4A

ALL DEVELOPMENT PROJECTS MUST IMPLEMENT SOURCE CONTROL BMP'S. REFER TO CHAPTER 4 AND APPENDIX E OF THE BMP DESIGN MANUAL FOR INFORMATION TO IMPLEMENT BMPS SHOWN IN THIS CHECKLIST

SOURCE CONTROL REQUIREMENT		APPLIED?		
4.2.1 PREVENTION OF ILLICIT DISCHARGES INTO THE MS4	\boxtimes YES	\square N \square	□ N/A	
4.2.2 STORM DRAIN STENCILING OR SIGNAGE	\boxtimes YES	\square $N\square$	□ N/A	
4.2.3 PROTECT DUTDOOR MATERIALS STORAGE AREAS FROM RAINFALL, RUN-ON,	\square YES	\square $N\square$	⊠ N/A	
RUNOFF, AND WIND DISPERSAL				
4.2.4 PROTECT MATERIALS STORED IN OUTDOOR WORK AREAS FROM RAINFALL, RUN-ON,	\square YES	\square $N\square$	⊠ N/A	
RUNOFF, AND WIND DISPERSAL				
4.2.5 PROTECT TRASH STORAGE AREAS FROM RAINFALL, RUN-ON, RUNOFF, AND WIND DISF	PERSAL⊠ YES		□ N/A	
4.2.6 BMPS BASED ON POTENTIAL SOURCES OF RUNOFF POLLUTANTS				
UN-SITE STURM UNDAIN INLETS	⊠ YFς	ПИП	\square N/A	

	RUNOFF, AND WIND DISPERSAL						
4.2	4 PROTECT MATERIALS STORED IN OUTDOOR WORK AREAS FROM RAINFALL, RUN-O	IN, 🗆	YES	NΠ	\boxtimes	N/A	
	RUNOFF, AND WIND DISPERSAL						
4.2	5 PROTECT TRASH STORAGE AREAS FROM RAINFALL, RUN-ON, RUNOFF, AND WIND	DISPERSAL⊠	YES	NΠ		N/A	
4.2	6 BMPS BASED ON POTENTIAL SOURCES OF RUNOFF POLLUTANTS						
	ON-SITE STORM DRAIN INLETS	⊠	YES	NΠ		N/A	
	INTERIOR FLOOR DRAINS AND ELEVATOR SHAFT SUMP PUMPS		YES	ΝΠ	\boxtimes	N/A	
	INTERIOR PARKING GARAGES		YES	NΠ	\boxtimes	N/A	
	NEED FOR FUTURE INDOOR & STRUCTURAL PEST CONTROL		YES	NΠ	\boxtimes	N/A	
	LANDSCAPE/OUTDOOR PESTICIDE USE	\boxtimes	YES	NΠ		N/A	
	POOLS, SPAS, PONDS, DECORATIVE FOUNTAINS, AND OTHER WATER FEATURES		YES	NΠ	\boxtimes	N/A	
	FOOD SERVICE		YES	NΠ	\boxtimes	N/A	
	REFUSE AREAS		YES	NΠ	\boxtimes	N/A	
	INDUSTRIAL PROCESSES		YES	NΠ	\boxtimes	N/A	
	OUTDOOR STORAGE OF EQUIPMENT OR MATERIALS		YES	NΠ	\boxtimes	N/A	
	VEHICLE/EQUIPMENT REPAIR AND MAINTENANCE		YES	NΠ	\boxtimes	N/A	
	FUEL DISPENSING AREA		YES	NΠ	\boxtimes	N/A	
	LOADING DOCKS		YES	NΠ	\boxtimes	N/A	
	FIRE SPRINKLER TEST WATER	\boxtimes	YES	NΠ		N/A	
	MISCELLANEOUS DRAIN OR WASH WATER		YES	NΠ	\boxtimes	N/A	
	PLAZAS, SIDEWALKS, AND PARKING LOTS		YES	NΠ	\boxtimes	N/A	
	SC-6A: LARGE TRASH GENERATING FACILITIES		YES	NΠ	\boxtimes	N/A	
	SC-6B: ANIMAL FACILITIES		YES	NΠ	\boxtimes	N/A	

SC-6D:AUTOMOTIVE-RELATED USES DISCUSSION / JUSTIFICATION FOR ALL "NO" ANSWERS SHOWN ABOVE:

DISCUSSION / JUSTIFICATION FOR ALL "NO" ANSWERS SHOWN ABOVE:

SC-6C: PLANT NURSERIES AND GARDEN CENTERS

SITE DESIGN BMP CHECKLIST FOR STANDARD PROJECTS	FORM I-5A

ALL DEVELOPMENT PROJECTS MUST IMPLEMENT SITE DESIGN BMP'S, REFER TO CHAPTER 4 AND APPENDIX E OF THE BMP DESIGN MANUAL FOR INFORMATION TO IMPLEMENT BMPS SHOWN IN THIS CHECKLIST

	NOTE: ALL SELECTED BMPS MUST BE SHOWN ON THE CONSTRUCTION PLANS				
	SITE DESIGN REQUIREMENT		APPLIED?		
1	4.3.1 MAINTAIN NATURAL DRAINAGE PATHWAYS AND HYDROLOGIC FEATURES	\boxtimes YES	\square $N\square$	□ N/A	
	4.3.2 CONSERVE NATURAL AREAS, SOILS, AND VEGETATION	\boxtimes YES	\square $N\square$	□ N/A	
	4.3.3 MINIMIZE IMPERVIOUS AREA	\square YES	\square $N\square$	⊠ N/A	
	4.3.4 MINIMIZE SOIL COMPACTION	\square YES	\square $N\square$	⊠ N/A	
	4.3.5 IMPERVIOUS AREA DISPERSION	\bowtie YES	\square $N\square$	□ N/A	
	4.3.6 RUNDFF COLLECTION	\Box YES	⊠ N□	□ N/A	
	4.3.7 LANDSCAPING WITH NATIVE OR DROUGHT TOLERANT SPECIES	\bowtie YES	\square $N\square$	□ N/A	
	4.3.8 HARVESTING AND USING PRECIPITATION	□ YES	⊠ N□	□ N/A	

4.3.6 AND 4.3.8 ARE NOT BEING USED AS 4.3.5. WILL BE USED TO CONVY THE RUNOFF AND DISTRIBUTE ONTO NATIVE LANDSCAPE

BASIN DETAILS		
	BASIN	
FOOTPRINT SIZE	1000 SF	
MAXIMUM PONDING ELEVATION	135.63	
PONDING DEPTH/ RISER SIZE	8 INCHES	
* ENGINEERED MEDIA LAYER	12 INCHES	
FILTER COURSE	6 INCHES	
TOTAL DEPTH OF BASIN	26 INCHES	
OUTLET SIZE	4 INCHES	

Signatures:

Drawings Prepared By:

WILLIAM R. DICK Project No.:


Checked By:

X: \Land Projects\2019\365319 Garfield Road\Engineering\Civil 3D\365319—Garfield Rd grading plan set.dwg

RESIDENCE Garfield Rd. & Kane St. San Diego, CA

POWELL

Project Title:

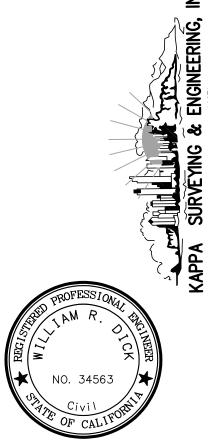

SPECIAL RAINY SEASON PROVISIONS

DURING THE RAINY SEASON, THE CONTRACTOR MUST TAKE SPECIAL CARE TO MAKE SURE THAT ALL PROVISIONS OF THIS PLAN AND THE WATER POLLUTION CONTROL PROGRAM ARE FULLY IMPLEMENTED.

1. THE RAINY SEASON IS DEFINED AS FROM OCTOBER 1ST TO MAY 1ST.

2. ALL EROSION CONTROL FEATURES (BMPs) SHALL BE INSPECTED AT LEAST ONCE EACH WEEK.

3. SEE PROVISIONS OF THE WATER POLLUTION CONTROL PROGRAM FOR REQUIRED WORK WHEN A RAIN EVENT IS ANTICIPATED.

ADDITIONAL NOTES

1-Interim binder note: Graded, disturbed, or eroded areas to be treated with a non-irrigated hydroseed mix shall receive an interim binder/tackifier as needed between april 2nd and august 31st for dust-erosion Control with subsequent application of hydroseed mix during the rainy season between october 1st and april 1st.

2— ALL GRADED, DISTURBED OR ERODED AREAS THAT WILL NOT BE PERMANENTLY PAVED OR CORVERED BY STRUCTURES SHALL BE PERMANENTLY REVEGETATED AND IRRIGATED AS SHOWN IN TABLE 142—04F AND IN ACCORDANCE WITH THE STANDARDS IN THE SDMC142—0411. ALL REQUIRED REVEGETATION AND EROSION CONTROL SHALL BE COMPLETED WITHIN 90 CALENDAR DAYS OF THE COMPLETION OF GRADING OR DISTURBANCE.

EROSION CONTROL NOTES

4.4 HYDROSEEDING PROCEDURES

4.4-1 SEED MIXES SHALL BE SPECIFIED BY THE PURE LIVE SEED OF EACH SPECIES.

4.4—2 FIBER MULCH SHALL BE APPLIED AT A MINIMUM RATE OF 2,000 POUNDS PER ACRE EXCEPT WHEN USED IN CONJUNCTION WITH STRAW MULCH, WHEN IT SHALL BE APPLIED AT A MINIMUM RATE OF 400 POUNDS PER ACRE.

4.4-3 A WETTING AGENT CONSISTING OF 95 PERCENT ALKYL POLYETHYLENE GLYCOL ETHER SHALL BE APPLIED AS PER MANUFACTURERS' RECOMMENDATIONS.30

4.4—4 EQUIPMENT USED FOR THE APPLICATION OF SLURRY SHALL HAVE A BUILT—IN AGITATION SYSTEM TO SUSPEND AND HOMOGENEOUSLY MIX THE SLURRY. THE SLURRY MIX SHALL BE DYED GREEN. THE EQUIPMENT MUST HAVE A PUMP CAPABLE OF APPLYING SLURRY UNIFORMLY.

ADD INTERIM BINDER NOTE:

GRADED, DISTURBED, OR ERODED AREAS TO BE TREATED WITH A NON-IRRIGATED
HYDROSEED MIX SHALL RECEIVE AN INTERIM BINDER/TACKIFIER AS NEEDED BETWEEN
APRIL 2NDAND AUGUST 31STFOR DUST-EROSION CONTROL WITH SUBSEQUENT
APPLICATION OF HYDROSEED MIX DURING THE RAINY SEASON BETWEEN OCTOBER 1ST
AND APRIL 1ST

4.5 MAINTENANCE REQUIREMENTS

4.5-1 PERMANENTLY IRRIGATED SLOPES SHALL BE MAINTAINED FOR A PERIOD NO


LESS THAN 90 DAYS.

4.5-2 NON-PERMANENTLY IRRIGATED AREAS SHALL BE MAINTAINED FOR A PERIOD

NOT LESS THAN 25 MONTHS.

4.5-3 ALL REVEGETATED AREAS SHALL BE MAINTAINED BY THE PERMITTEE UNTIL FINAL APPROVAL BY THE CITY MANAGER. THE MAINTENANCE PERIOD BEGINS ON THE FIRST DAY FOLLOWING ACCEPTANCE AND MAY BE EXTENDED AT THE DETERMINATION OF THE CITY MANAGER.


4.5—4 PRIOR TO FINAL APPROVAL, THE CITY MANAGER MAY REQUIRE CORRECTIVE ACTION INCLUDING BUT NOT LIMITED TO, REPLANTING, THE PROVISION OR MODIFICATION OF IRRIGATION SYSTEMS, AND THE REPAIR OF ANY SOIL EROSION OR SLOPE SLIPPAGE.

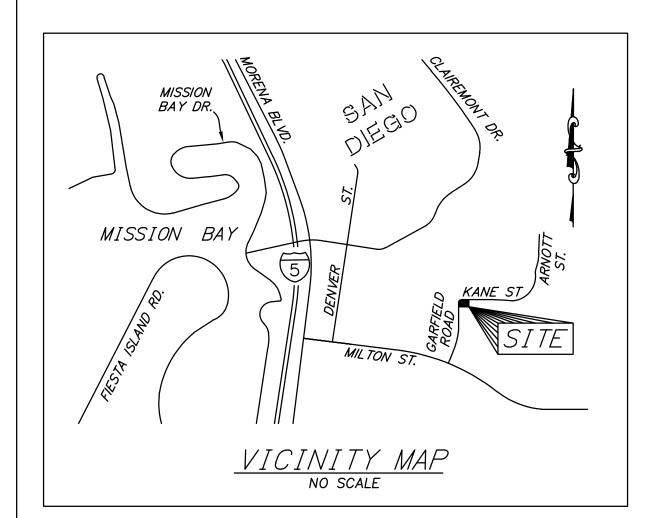

EROSION CONTROL LEGEND

THE FOLLOWING EROSION CONTROL BMPs WILL BE USED ON THIS PROJECT, ALONG WITH ALL ELEMENTS OF THE PROJECT'S WATER POLLUTION CONTROL PROGRAM (WPCP) WHICH ARE INCLUDED HEREIN BY REFERENCE.


TEMPORARY BMP NAME <u>BMP DWG NO</u> <u>SYMBOL</u> RESOURCE PROTECTION BMPS -0----LINEAR SEDIMENT CONTROLS MATERIAL STORAGE & HANDLING BMPS WM-1 MATERIAL STORAGE WM-3 WM-3LANDSCAPE MATERIAL MANAGEMENT PAVING AND GRADING OPERATIONS NS-12 NS-14 NS-12 NS-14 CONCRETE CURING CONCRETE FINISHING <u>WASTE MANAGEMENT BMPS</u> WM-5 WM-7 WM-9 WM-8 WM-3 WM-5 WM-7 SOLID WASTE MANAGEMENT CONTAMINATED SOIL MANAGEMENT WM-9 WM-8 WM-3 SANITARY/SEPTIC WASTE MANAGEMENT CONCRETE WASTE MANAGEMENT STOCKPILED WASTE MANAGEMENT <u>VEHICLE & EQUIPMENT MANAGEMENT BMPS</u> VEHICLE & EQUIPMENT CLEANING NS-9 NS-9 VEHICLE & EQUIPMENT FUELING NS-10 NS-10 VEHICLE & EQUIPMENT MAINTENANCE NON-STORM WATER MANAGEMENT BMPS ILLICIT NS-6 NS-6 CONNECTION/DISCHARGE DETECTION & REPORTING NS-7 NS-7 POTABLE WATER/IRRIGATION GENERAL EROSION CONTROL BMPS SS-1 WM-3 SS-1 SCHEDULING/PHASING CONSTRUCTION WM-3 STOCKPILE MANAGEMENT <u>VEGETATIVE STABILIZATION BMPS</u> SD-10 SD-10 ESTABLISH PERMANENT LANDSCAPING* *CASQA BMP DUST CONTROL BMPS WE-1 WE-1 WIND EROSION CONTROL PERIMETER & LINEAR SEDIMENT CONTROL BMPS SC-1 SC-6 SC-8 -----CHAINLINK FENCE GRAVEL BAG BERM SAND BAG BARRIER SEDIMENT CAPTURE BMPS SC-10 STORM DRAIN INLET PROTECTION OFF-SITE SEDIMENT TRACKING BMPS TC-1 CONSTRUCTION ENTRANCE SC-7 SC-7 STREET SWEEPING & VACUUMING

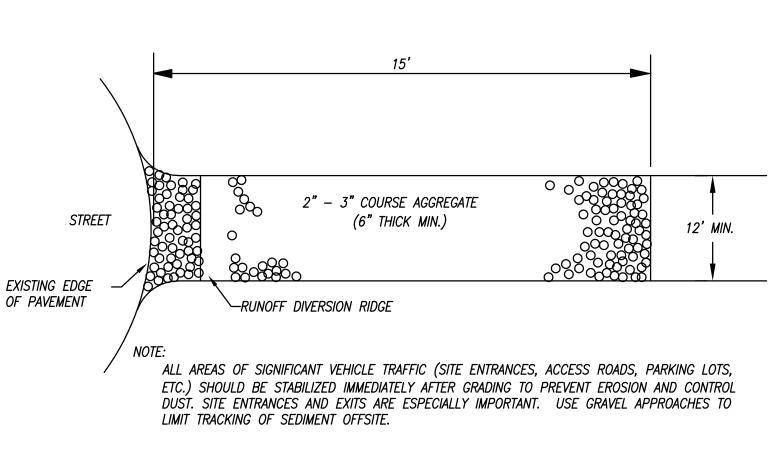

STABILIZED CONSTRUCTION ENTRANCE


ND SCALE


TC-1

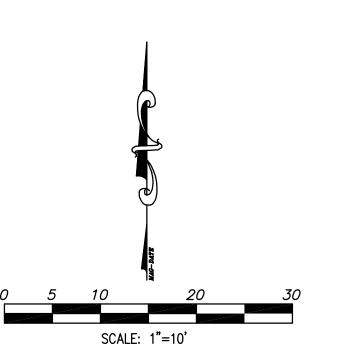

UNG. 110. 11/00-3-D

STREET

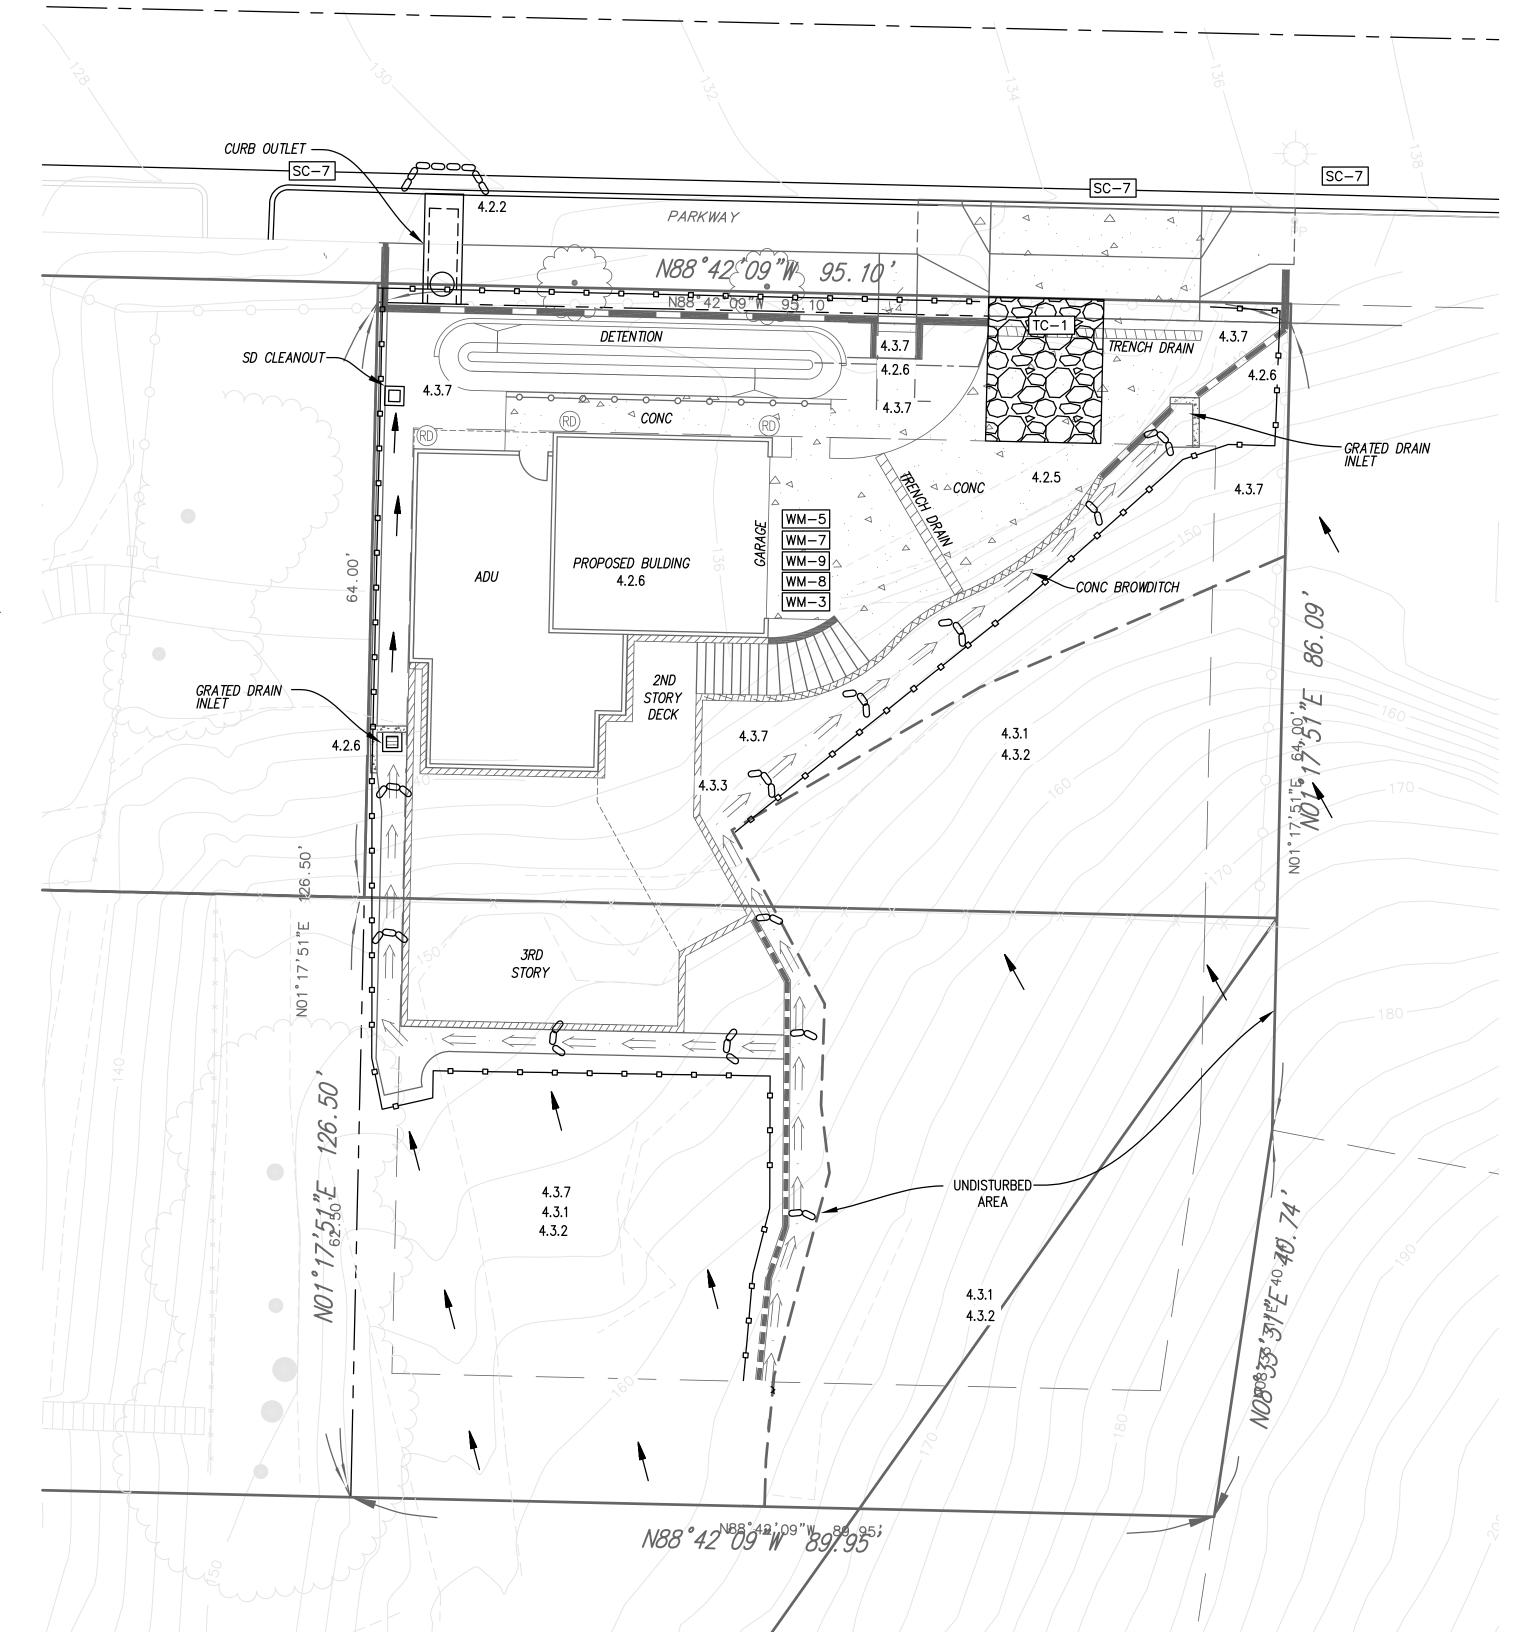

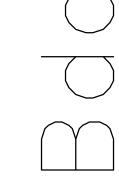

BALLERINO DESIGNASSOCIATES, LLC ASSOCIATES, LLC P.O. BOX 122689 SAN DIEGO, CA 92112—2689 858.21.65241 TEL

Project Title:

POWELL RESIDENCE Garfield Rd. & Kane St. San Diego, CA

Development Permit (S.D.P.)



EROSION CONTROL

Signatures:

Drawings Prepared By:


WILLIAM R. DICK

Project No.:

Drawn By: Checked By:

Date:

C 6

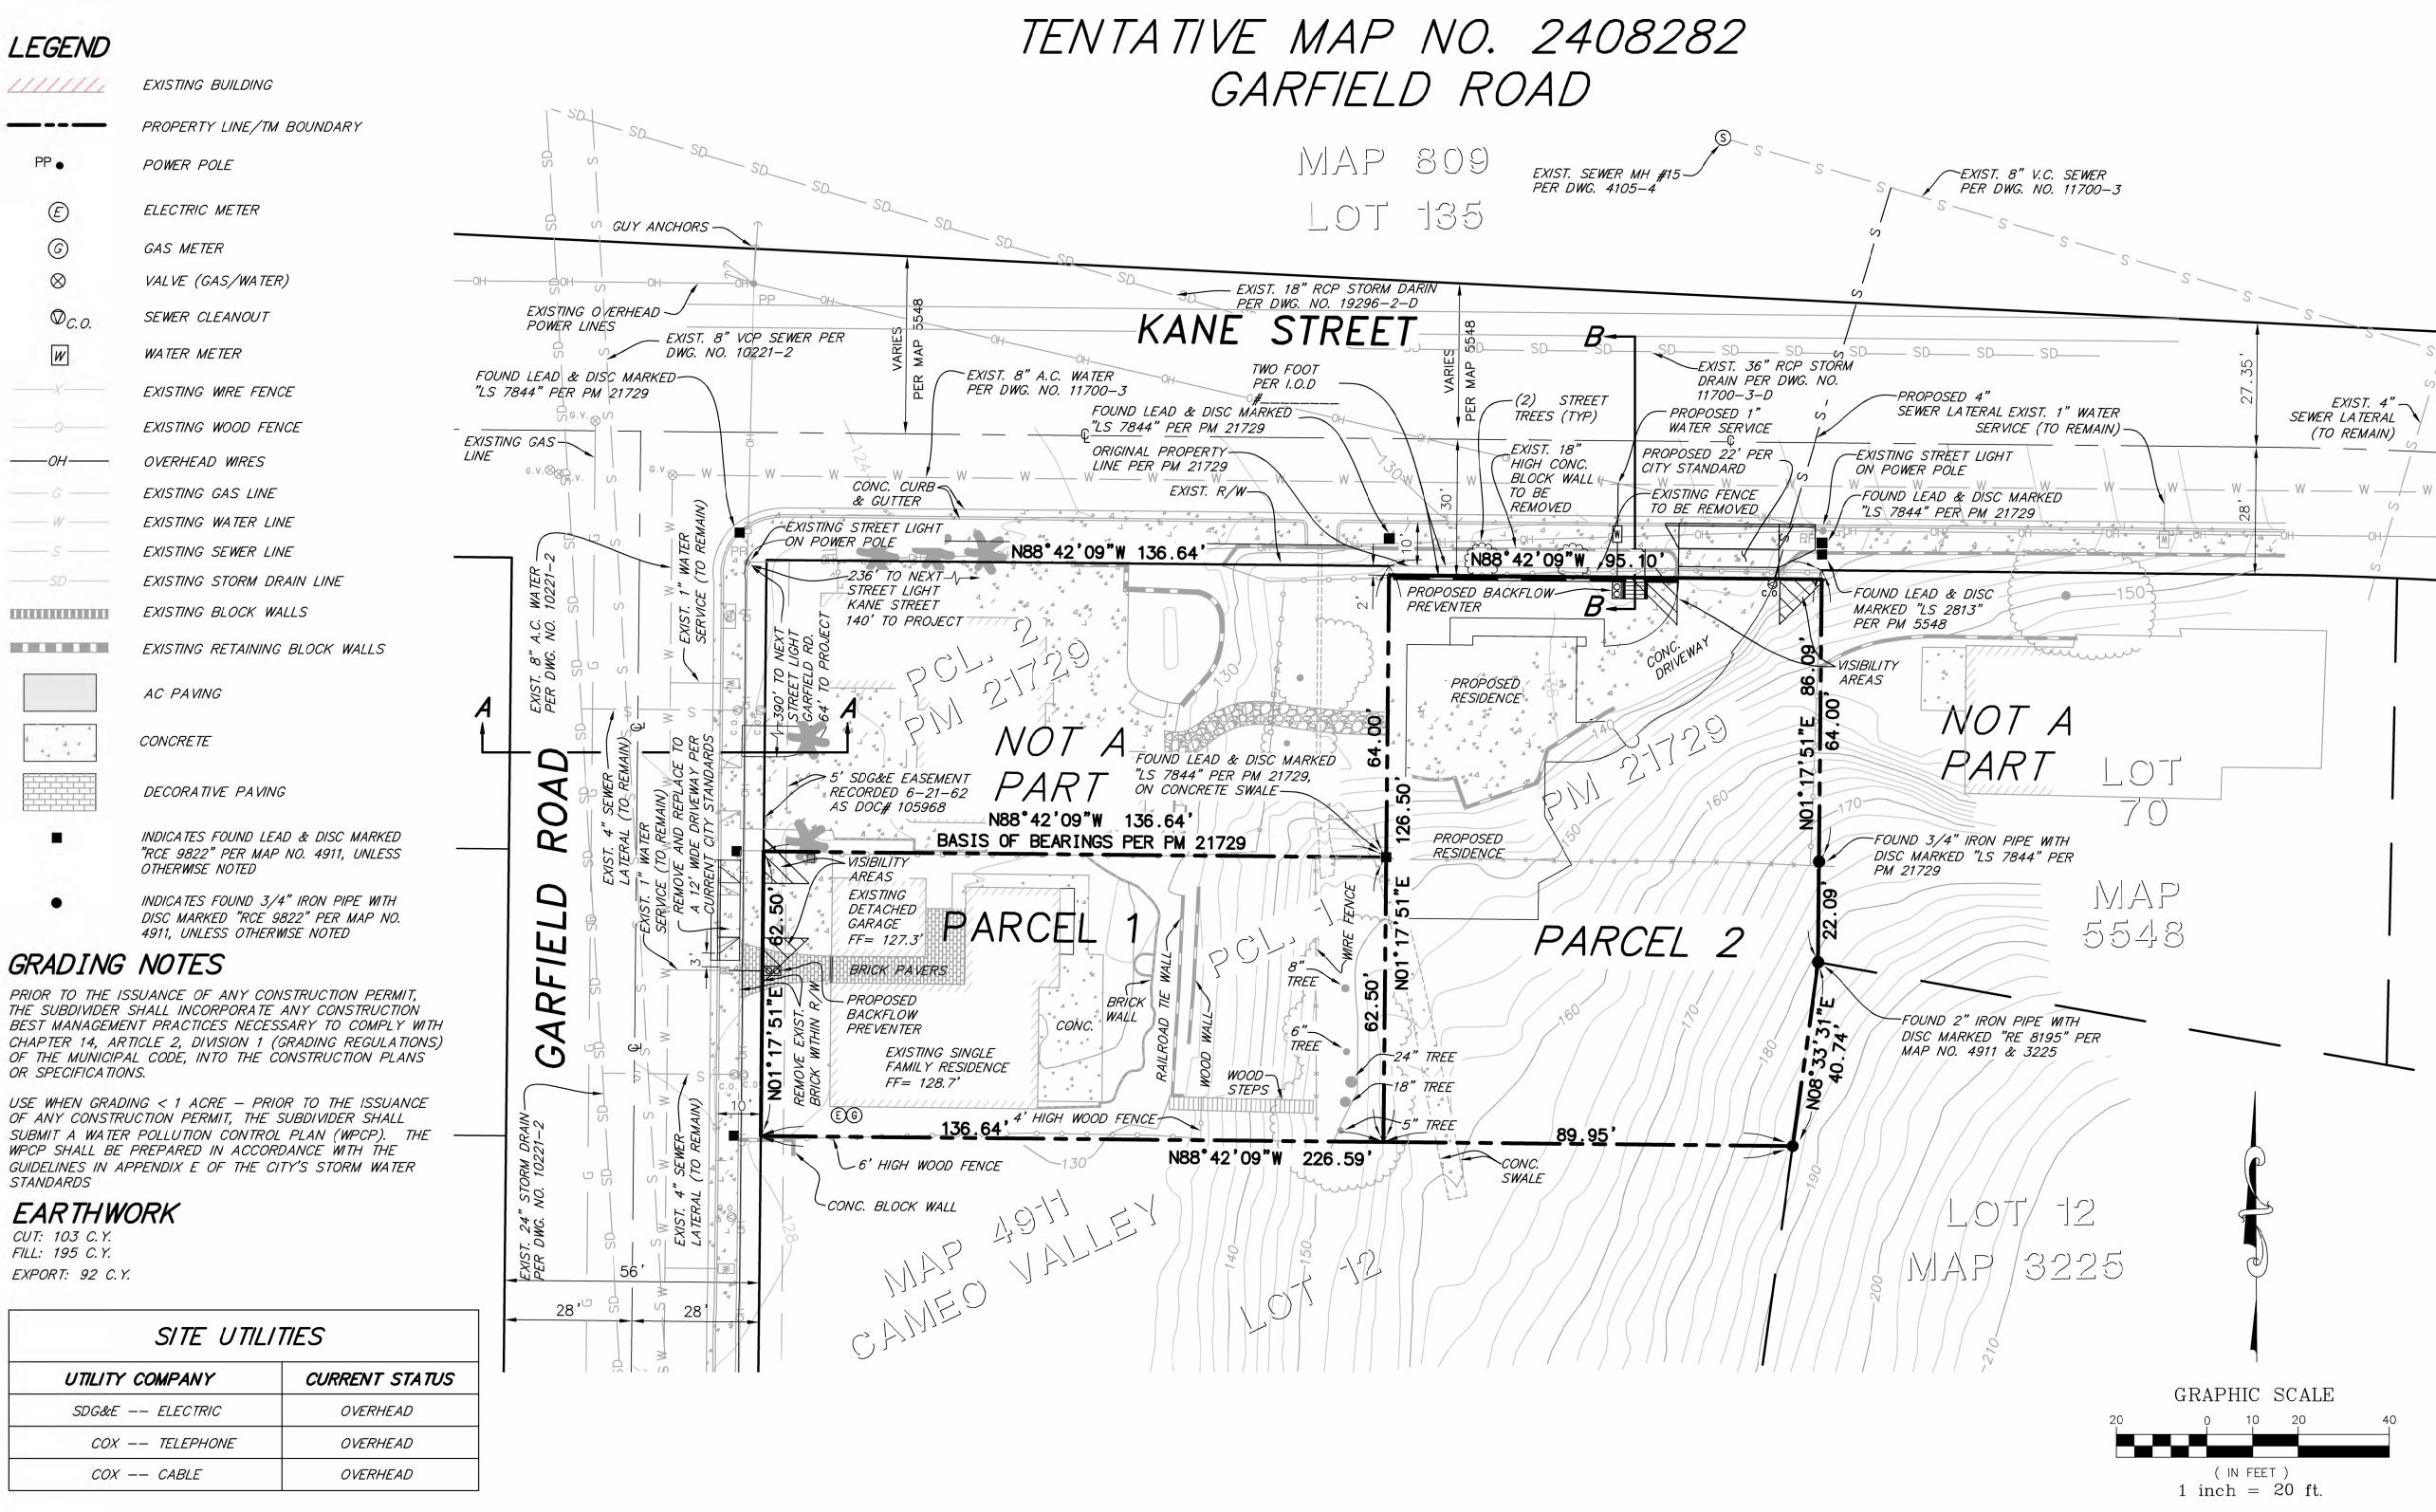

2' REQUEST IRREVOCABLE

OFFER TO DEDICATE

REMOVE

EXISTING -FENCE

NEW PROPOSED

RETAINING WALL-

CONCRETE SIDEWALK

EASTERLY —

R/W LINE

- WESTERLY

R/W LINE

EXISTING — CONCRETE SIDEWALK

EXISTING AC PAVING

EXISTING CONCRETE CURB

SECTION A-A

GARFIELD ROAD

NOT TO SCALE

PREVIOUS

R/W LINE

4.5 '| *5.5* '

EXISTING —)
CONCRETE SIDEWALK

RETAINING WALL TO BE REMOVED

SOUTHERLY

-GRADE BACK

MISSION

MISSION BAY

VICINITY MAP

NOTES

CONCRETE

SIDEWALK

NORTHERLY —

R/W LINE

- VARIES

-EXISTING AC PAVING

EXISTING CONCRETE CURB

SECTION B-B

KANE STREET

NOT TO SCALE

- 1. SITE ADDRESS: PARCEL 1 - 2343 GARFIELD ROAD, SAN DIEGO PARCEL 2 — (HOUSE NUMBER TBD) KANE STREET, SAN DIEGO
- SOURCE OF TOPOGRAPHY IS A FIELD SURVEY PERFORMED BY KAPPA SURVEY INC. ON JANUARY 5, 2018.
- UTILITIES: ALL OVERHEAD FACILITIES THAT SERVE THE SITE WILL BE PLACED UNDERGROUND. PARCEL 2
- 4. (1) EXISTING SDG&E 5' WIDE EASEMENT AS SHOWN ON PLAN
- NO PROPOSED EASEMENTS
- NAD 27 COORDINATES: 226-1707 NAD 83 COORDINATES: 1866-6269
- ALSO REQUESTING A WAIVER OF THE CITY UNDERGROUND REQUIREMENT FOR EXISTING MAIN OVERHEAD FACILITIES. PARCEL 1
- NO OBSTRUCTION INCLUDING SOLID WALLS IN THE VISIBILITY AREA SHALL EXCEED 3 FEET IN HEIGHT PER SDMC SECTION 142.0409 (b)(2). PLANT MATERIAL, OTHER THAN TREES, LOCATED WITHIN VISIBILITY AREAS OR THE ADJACENT PUBLIC RIGHT-OF-WAY SHALL NOT EXCEED 36" INCHES IN HEIGHT, MEASURED FROM THE LOWEST GRADE ABUTTING THE PLANT MATERIAL TO THE TOP OF THE PLANT MATERIAL.


9. REFERENCE APPROVAL SDP #2574874

LEGAL DESCRIPTION

PARCEL 1 OF PARCEL MAP 21729, IN THE CITY OF SAN DIEGO, IN THE COUNTY OF SAN DIEGO, STATE OF CALIFORNIA, FILED IN THE OFFICE OF THE COUNTY RECORDER OF SAN DIEGO COUNTY OCTOBER 10, 2019.

OWNER

POWELL FAMILY TRUST DATED MAY 17, 2011 2343 GARFIELD ROAD SAN DIEGO, CA 92110 (858) 414-6444

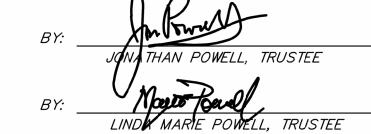

NUMBER OF EXISTING PARCELS = 1

NUMBER OF PROPOSED PARCELS = 2

ZONING

BASE ZONE: RS-1-7 NO CHANGES PROPOSED COMMUNITY PLAN NAME: CLAIREMONT MESA

ASSESSOR'S PARCEL NUMBER

430-820-13 AND 430-820-28

TOTAL MAP AREA

PARCEL 1 - 8,540.27 SF/0.19 AC

PARCEL 2 - 11,925.57 SF/0.27 AC

BASIS OF BEARINGS

THE SOUTHERLY LINE OF PARCEL 2 OF PARCEL MAP 21729

N88°42'09"W.

BENCHMARK

BENCH MARK FOR THIS SURVEY IS CITY OF SAN DIEGO ENGINEERING DEPARTMENT VERTICAL CONTROL MONUMENT, #12945, A BRASS PLUG AT THE SOUTHEASTERLY RETURN OF MILTON STREET AND ILLION STREET.

ELEVATION: 163.777

DATUM: NGVD 29

PROJECT DESCRIPTION

THIS PROJECT IS PROPOSING THE CREATION OF (2) TWO PARCELS. THE OFF-SITE IMPROVEMENT IS THE CONSTRUCTION OF A RESIDENTIAL TYPE DRIVEWAY. ANY NEW ON-SITE UTILITIES WILL BE UNDERGROUNDED. THE PARCEL 2 SITE IS CURRENTLY VACANT.

MAPPING NOTE

ALL PROPERTY CORNERS WILL BE SET AND A TWO LOT PARCEL MAP WILL BE FILED UPON APPROVAL OF THE TENTATIVE MAP. A DETAILED PROCEDURE OF SURVEY WILL BE SHOWN ON THE PARCEL MAP.

SURVEYOR

KAPPA SURVEYING & ENGINEERING, INC. 8402 N. MAGNOLIA AVE. STE C SANTEE, CA 92071 TELEPHONE: (619) 449-2600



ALLEN R.A. TURNER III, PLS REGISTRATION NUMBER: L.S. 7844 EXPIRATION DATE: EXP. 12/31/2024





TENTATIVE MAP 2343 GARFIELD ROAD

DATE: 09/08/2023 *REVISIONS* L.C. 226-1709 PROJECT NAD83 1866-6269 PTS #657970