VICINITY MAP

PROJECT DESCRIPTION

A COASTAL DEVELOPMENT PERMIT AND SITE DEVELOPMENT PERMIT TO DEMOLISH AN EXISTING HISTORICALLY DESIGNATED 3,036 SQUARE-FOOT (SF) 2-STORY RESIDENCE AND CONSTRUCT A NEW 2-STORY 8,649 SF RESIDENCE WITH A BASEMENT LOCATED AT 6110 CAMINO DE LA COSTA. THE PROJECT WOULD ALSO INCLUDE A SWIMMING POOL AT GROUND LEVEL, A SPA AT THE LOWER LEVEL AND ASSOCIATED SITE IMPROVEMENTS (I.E. HARDSCAPE AND LANDSCAPING). THE PROJECT WOULD PRESERVE THE EXISTING WALL ALONG THE FRONTAGE OF THE SITE AND DETACHED GARAGE IN PLACE.

THE PROPOSED DEVELOPMENT WOULD INCLUDE LANDSCAPE IMPROVEMENTS INCLUDING HEDGES ALONG THE FRONTAGE OF THE SITE AND EDGES OF THE SITE ADJACENT TO THE NEIGHBORING PROPERTIES ON THE NORTH AND SOUTH. LANDSCAPING WOULD ALSO INCLUDE TREES, SUCCULENTS, AND SHRUBS IN THE FRONT PORTION OF THE SITE. THE SITE WOULD BE ACCESSIBLE FROM A NEW DRIVEWAY OFF CAMINO DE LA COSTA AND THE PROJECT WOULD CONNECT TO EXISTING UTILITIES WITHIN CAMINO DE LA COSTA. DRAINAGE WOULD BE DIRECTED AWAY FROM THE COASTAL BLUFF AND DIRECTED INTO THE EXISTING STORM DRAIN SYSTEM.

THE PROPOSED PROJECT WOULD ALSO INCLUDE REMOVAL OF THE EXISTING WALLS AND STAIRS WEST OF THE BLUFF EDGE AND WOULD PRESERVE ALL PORTIONS OF THE LOT WEST OF THE BLUFF EDGE AS ENVIRONMENTALLY SENSITIVE LANDS (SENSITIVE COASTAL BLUFF) WITHIN A COVENANT OF EASEMENT. THE COVENANT OF EASEMENT WOULD INCLUDE LAND USE RESTRICTIONS WITH THE INTENT TO PRECLUDE FUTURE DEVELOPMENT AND TO PRESERVE THE AREA.

THE PROPOSED RESIDENCE WOULD BE A MAXIMUM HEIGHT OF 30 FEET WITHIN THE 30-FOOT COASTAL HEIGHT LIMIT. THE RESIDENCE WOULD INCLUDE CAST IN PLACE NATURAL GREY WALLS, FROSTED & CLEAR GLASS LINED BY BLACK METAL, WOOD PANELS, DECORATIVE METAL & STONE SCREENING, METAL ENTRY AND SLIDING GATES.

THE TOTAL AREA WITHIN THE PROJECT SITE TO BE GRADED IS 0.17 ACRES, OR 46.3% OF THE PROJECT SITE. GRADING WOULD REQUIRE APPROXIMATELY 1155 CUBIC YARDS OF CUT (150 CUBIC YARDS OF NATIVE SOIL AND 1005 CUBIC YARDS OF ARTIFICIAL FILL), AND 20 CUBIC YARDS OF FILL, RESULTING IN A NET EXPORT OF 1135 CUBIC YARDS OF SOIL.

PROJECT TEAM

OWNER: JMAN AT THE Q, L.P. 2121 SUNSET BLVD SAN DIEGO, CA 92103 619-993-6269 CONTACT: MATTHEW SEGAL

EMAIL: MRMATTHEWSEGAL@GMAIL.COM **APPLICANT DEVELOPER:** JMAN INVESTMENTS INC

2121 SUNSET BLVD SAN DIEGO, CA 92103 619-993-6269 CONTACT: MATTHEW SEGAL EMAIL: MRMATTHEWSEGAL@GMAIL.COM

ARCHITECT: JONATHAN SEGAL FAIA 2121 SUNSET BLVD SAN DIEGO, CA 92103

619-993-6269 CONTACT: MATTHEW SEGAL EMAIL: MRMATTHEWSEGAL@GMAIL.COM

STRUCTURAL ENGINEER

DCI ENGINEERS 101 W. BROADWAY STE 1260 SAN DIEGO, CALIFORNIA 92101 619-400-1704 CONTACT: JON DECK

EMAIL:JDECK@DCI-ENGINEERS.COM

GEOTECHNICAL ENGINEER 1 CHRISTIAN WHEERER ENGINEERING

3980 HOME AVENUE SAN DIEGO, CA 92105

619-550-1721 CONTACT: DAVID RUSSELL EMAIL: DRUSSEL@CHRISTIANWHEELER.COM

GEOTECHNICAL ENGINEER 2 GEOSOILS INC 18451 COLLIER AVE SUITE A LAKE ELSINORE, CA, 92530 951-471-0700 CONTACT: BRYAN E. RODRIGUEZ

EMAIL: WMACK@PLSAENGINEERING.COM

CIVIL ENGINEER: PASCO LARET SUITER 535 N HWY 101 SOLANA BEACH, CA 92075 858-259-8212 CONTACT: WILL MACK EMAIL: BRODRIGUEZ@GEOSOILSINC.COM

ELECTRICAL ENGINEER: NEDC, INC 3103 FALCON STREET SUITE J SAN DIEGO, CA 92103 619-278-0076 CONTACT: DAVID NUTTER EMAIL: DAVID@NEDINC.NET

6110 CAMINO DE LA COSTA, LA JOLLA, CA 92037

TEN (10) AND ELEVEN (11), IN BLOCK ONE-A, IN LA JOLLA HERMOSA, IN THE CITY OF SAN DIEGO, THE OFFICE OF THE COUNTY RECORDER OF SAID SAN DIEGO COUNTY, NOVEMBER 21, 1924; EXCEPTING FROM THE ABOVE-DESCRIBED PROPERTY THAT PORTION THEREOF HERETOFORE OR NOW LYING BELOW THE MEAN HIGH TIDE LINE OF THE PACIFIC OCEAN.

PROJECT DATA

EASEMENTS NO EXISTING EASEMENTS ON SITE

PERMITS REQUIRED:

PMT-3169345 COASTAL DEVELOPMENT PERMIT (CDP) PMT-3169346 SITE DEVELOPMENT PERMIT (SDP) PMT-3275100 NEIGHBORHOOD DEVELOPMENT PERMIT (NDP)

DISCRETIONARY PERMIT

PROJECT#

357-141-05-00

ZONE:

USE / STRUCTURES ON SITE:

EXISTING:

SINGLE FAMILY RESIDENCE PRIMARILY CONSTRUCTED IN 1924

SINGLE FAMILY RESIDENCE

PROPOSED REHABILITATION/ REMOVAL OF HISTORIC RESOURCE

HERBERT YORK/ HERBERT PALMER / CASA DE LOS AMIGOS

PROPOSED USE:

COASTAL OVERLAY ZONE (COZ) CST-APP COASTAL OVERLAY ZONE FIRST PUBLIC ROADWAY COASTAL HEIGHT LIMIT OVERLAY ZONE (CHLOZ) PARKING IMPACT OVERLAY ZONE - COASTAL & BEACH IMPACT SENSITIVE COASTAL OVERLAY ZONE: SCOZ-CB

TRANSIT AREA OVERLAY ZONE TRANSIT PRIORITY AREA COASTAL BLUFF EDGE

GEOLOGICAL HAZARD CATEGORY 12 & 43

TYPE IIIA **TYPE OF CONSTRUCTION:**

R-3 OCCUPANCY CLASSIFICATION

LOT SIZE: 16,058.31 sq ft 0.368 acres

BASE ZONING DENSITY: MAX PER LOT - 1DU

> ALLOWED RESIDENTIAL: INTERIOR LOT COVERAGE 40% PERMITTED FAR:

1 DU PER 8000 SQ FT = 1

EXEMPT PER 113.0234 BASEMENT GROUND LEVEL LEVEL 1 LEVEL 2 3323 TOTAL

SETBACKS:

FRONT REQUIRED:

VARIES DUE TO PREVIOUSLY CONFORMING STRUCTURE(S) PROPOSED:

20'-0" FOR NEW DEVELOPMENT VARIES DUE TO PREVIOUSLY CONFORMING STRUCTURE(S) SIDE REQUIRED:

7' - 1" FEET PER 113.0243(C) FOR NEW DEVELOPMENT

PROPOSED: NORTH = 7'-1" SOUTH = 7'-1" (NEW CONSTRUCTION)

VARIES 78 FEET TO 110 FEET

REAR YARD REQUIRED 20 FEET

FRONT YARD HARDSCAPE AND MAXIMUM PAVING §131.0447 SEE DIAGRAM T1.0

PROPOSED

REQUIRED MAX: 60% PROPOSED HARDSCAPE: 39%

BUILDING AREA:

FAR GOVERNED ALLOWED: SUBTERRANEAN LEVEL 3138 SQ FT 2761 SQ FT LEVEL 1 LEVEL 2 2750 SQ FT TOTAL 8649 SQ FT **GARAGE AREA** 499 SQ FT

30'-0" AT PLUMB LINE PROPOSED MAX: MAX HEIGHT ALLOWED 30'-0" PLUMB LINE + 10'-0"

PARKING:


HEIGHT:

2 SPACES + TWO GUEST REQUIRED: 2 SPACES + TWO GUEST PROPOSED: 4 TOTAL PARKING LOCATIONS

MODIFICATIONS

VISIBLITY TRIANGLE §113.0273 DIAGRAM 113.02SS

PROPOSED REDUCED

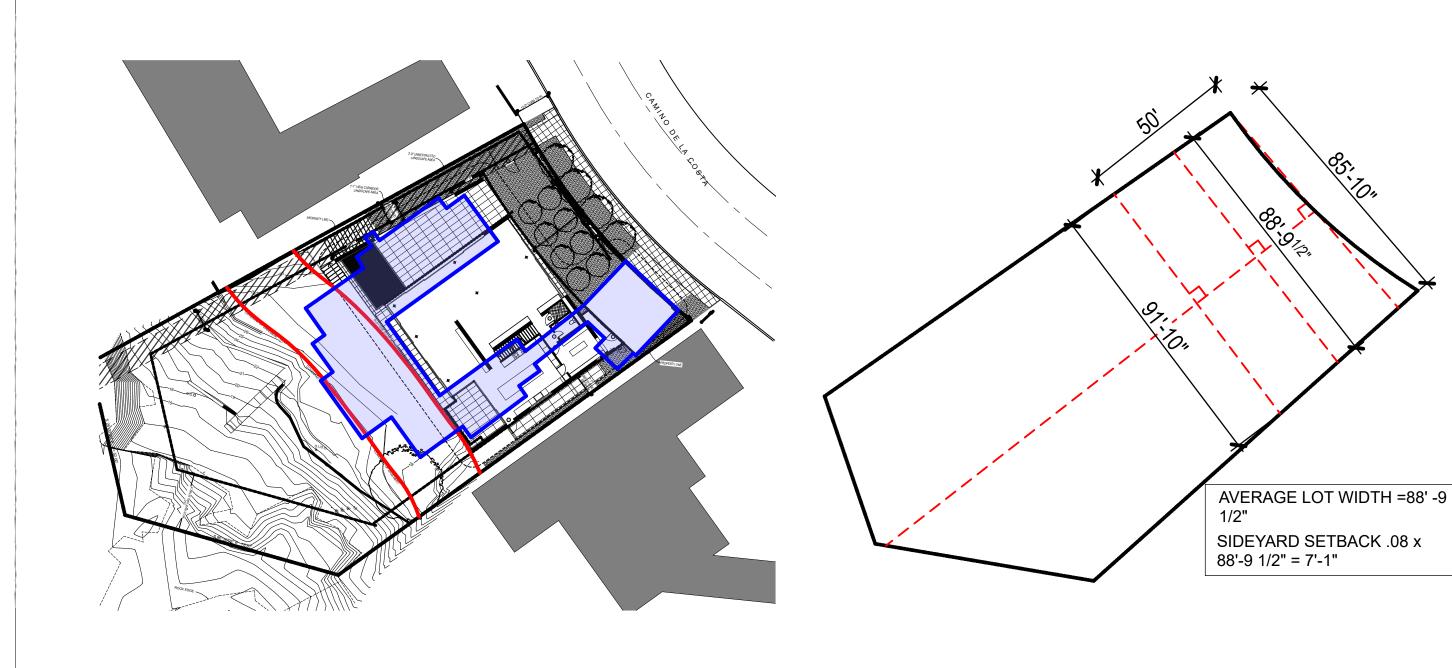

EXISTING VS PROPOSED

SHEET INDEX

T1.0 TITLE SHEET

T1.1 SURVEY T1.2 GRADING PLAN

T1.3 DEMOLITION PLAN

A0.0 SITE PLAN A1.0 BASEMENT PLAN

A1.1 GROUND LEVEL PLAN

A1.2 LEVEL 2

A1.3 ROOF LEVEL A1.4 FAR DIAGRAM

A2.0 SOUTH ELEVATION

A2.1 EAST ELEVATION A2.2 NORTH ELEVATION


A2.3 WEST ELEVATION

A3.0 BUILDING SECTIONS NORTH SOUTH A3.1 BUILDING SECTION EAST WEST

L1.0 LANDSCAPE GROUND LEVEL

L1.1 LANDSCAPE LOWER LEVEL

FIRE HYDRANT MAP

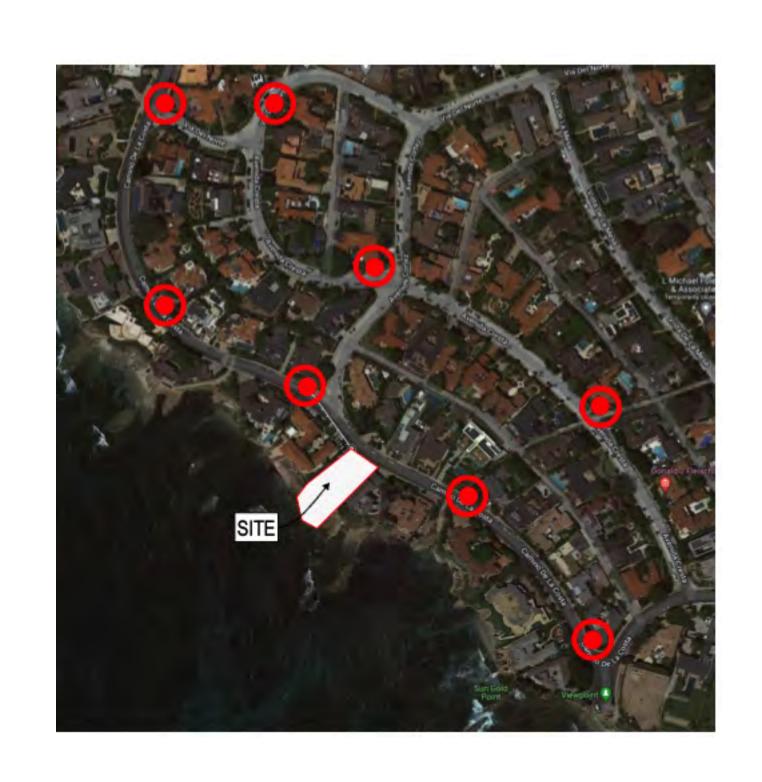

FRONT YARD HARDSCAPE CALC

FRONT YARD HARDSCAPE: COMPLIES WITH THE 60% MAXIMUM ALLOWED FOR PAVING AND HARDSCAPE WITHIN THE FRONT YARD PER SDMC §131.0447

TOTAL FRONT YARD AREA: TOTAL FRONT YARD PREVIOUSLY CONFORMING STRUCTURE: 614 SF PLANTING AREA REQUIRED: 706 SF PLANTING AREA PROVIDED: 40 + 980 + 59 = 1079 SF

COMPLIANCE:

1079 > 706 = OK

SIDE YARD CALCULATION

PROPERTY LINE-~ 40.01 sg ft~ 144.07 sq f

~~`g7g`70 sq.f

FRONT YARD

SETBACK

-PROPERTY LINE 1066101 PLANTING AREA SHEET TITLE:

-PLANTING AREA

PROPERTY LINE

-PLANTING AREA

494.36 sq ft

EXISTING PREVIOUSLY

-CONFORMING_

HISTORIC

GARAGE

59.37 sq f

SCALE 6/15/2022 **REVISION 1** 2/1/2023

TITLE SHEET

REVISION 2: 6/14/2023 **REVISION 3** 10/9/2023


REVISION 4:

REVISION 5: REVISION 6:

11/29/2023

1/12/24 FINAL DOCUMENT 2/26/24

SHEET NAME:

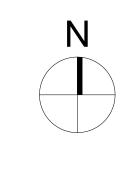



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6/15/2022

2/1/2023

REVISION 2: 6/14/2023 REVISION 3:


10/9/2023 REVISION 4:


11/29/2023 REVISION 5:

REVISION 6: 1/12/24 FINAL DOCUMENT

2/26/24

SHEET NAME:

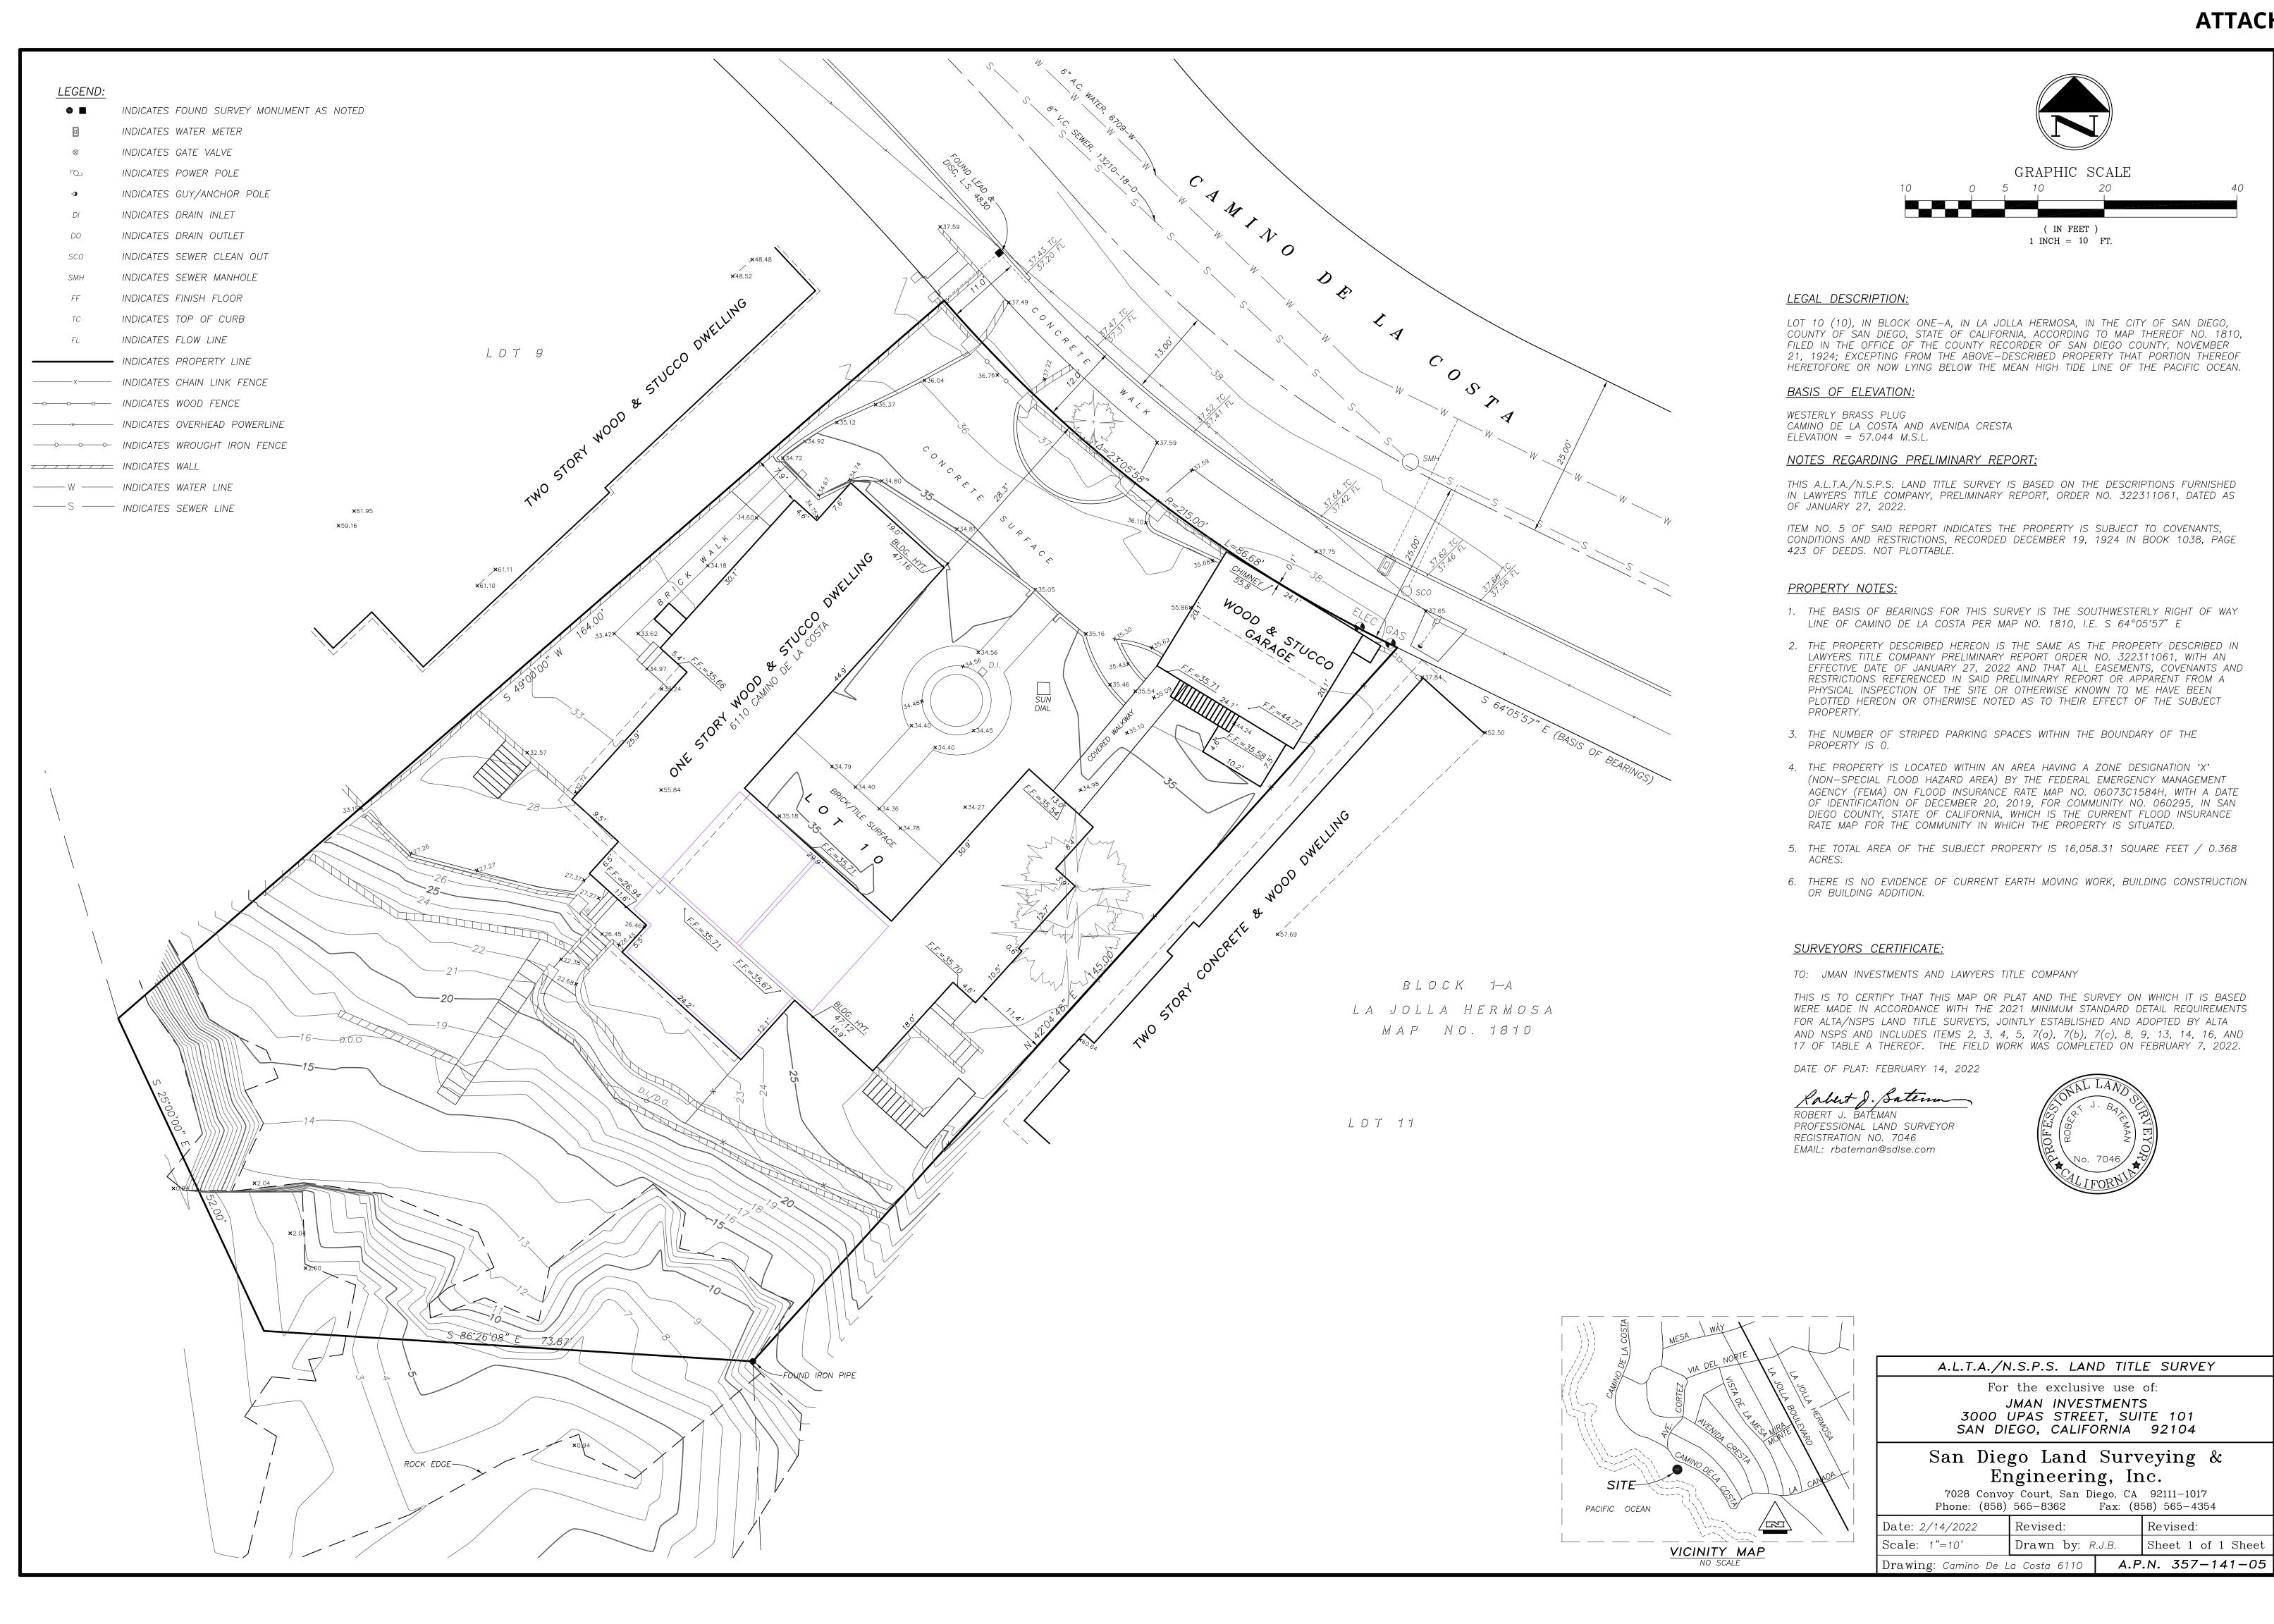


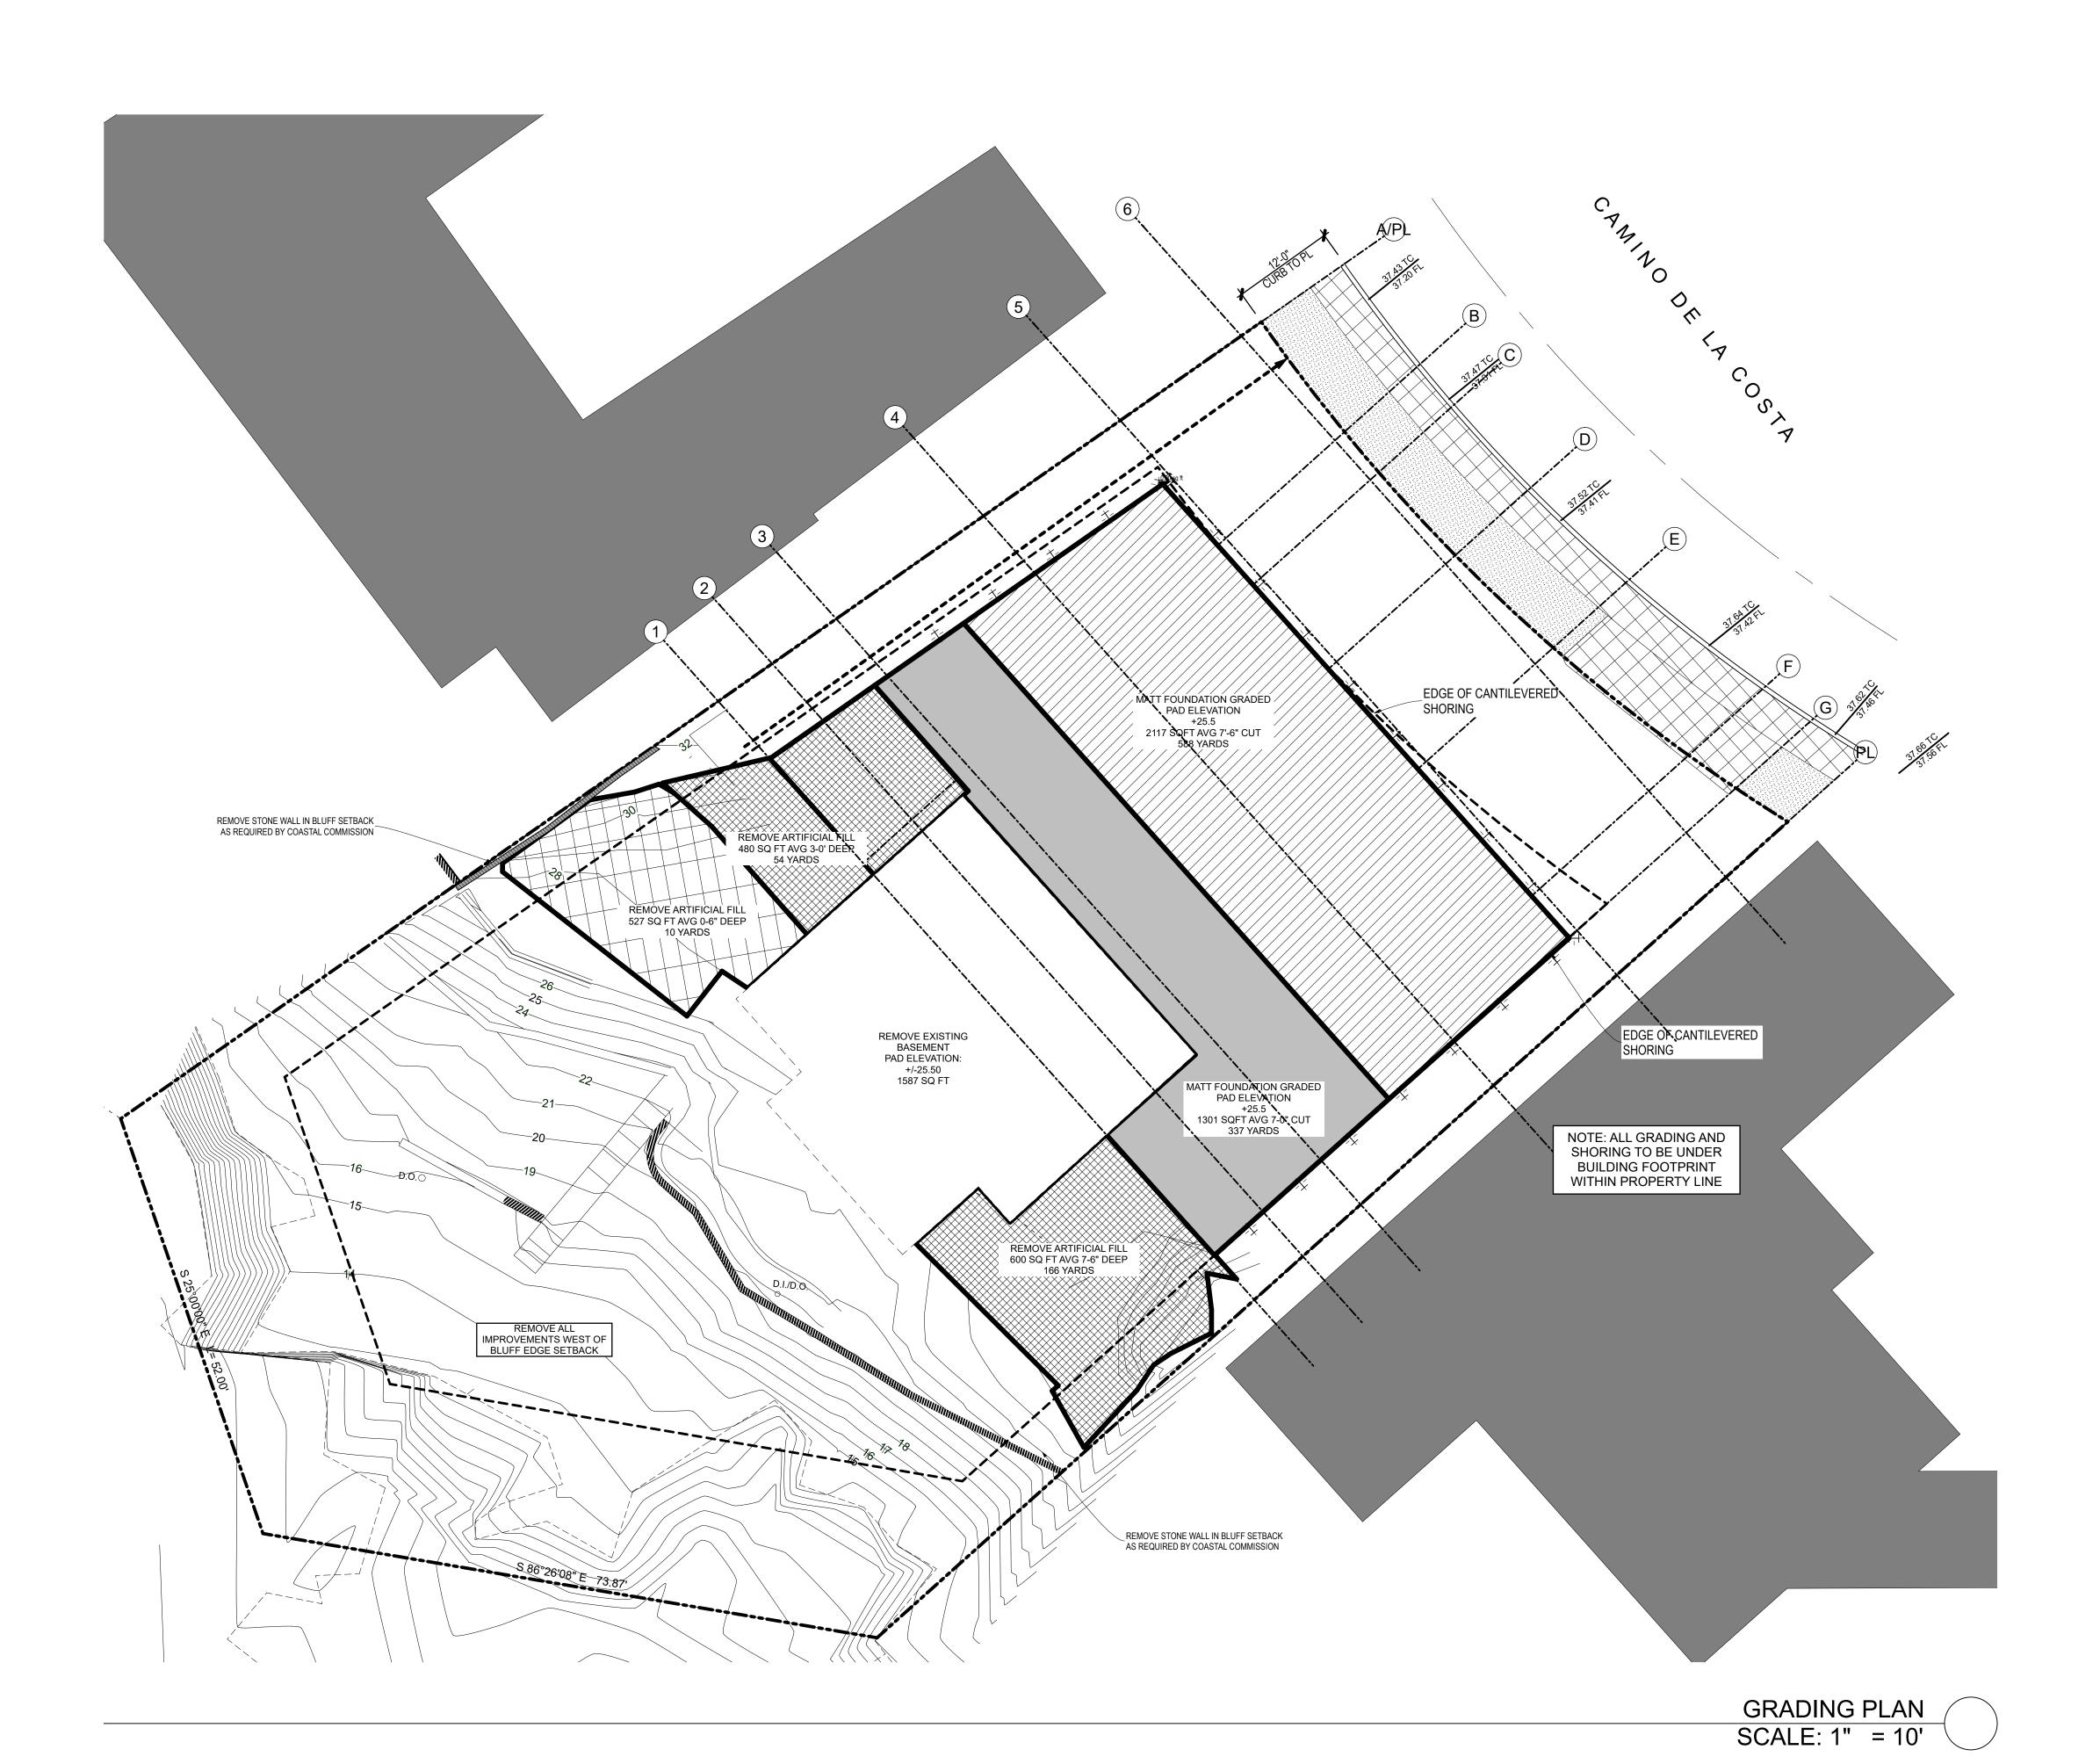

ATTACHMENT 9

ONSITE	
TOTAL DISTURBANCE AREA	
EXISTING AMOUNT OF IMPERVIOUS AREA6,235 SF	
PROPOSED AMOUNT OF IMPERVIOUS AREA5,755 SF	
OFF-SITE (PUBLIC IMPROVEMENTS)	
TOTAL DISTURBANCE AREA550 SF	
EXISTING AMOUNT OF IMPERVIOUS AREA579 SF	
PROPOSED AMOUNT OF IMPERVIOUS AREA662 SF	

.12 yards

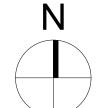

ON-SITE

ALL GRADING TO BE UNDER THE FOOTPRINT OF THE	=
STRUCTURE	

SEWER AND WATER LINES EXCAVATION.

IMPERVIOUS AREA SUMMARY TABLE

TOTAL AMOUNT OF SITE TO BE GRADED PERCENTAGE OF SITE AREA	
MAXIMUM DEPTH OF CUT	
AMOUNT OF BACKFILL	-
MAXIMUM HEIGHT OF FILL SLOPEAMOUNT OF SOIL EXPORT	N/A
RETAINING LENGTH	

TOTAL AMOUNT OF NATIVE SOIL	
TO BE EXCAVATED	150 yards
TOTAL AMOUNT OF ARTIFICIAL FILL TO	

TO BE EXCAVATED. ..1005 yards

NOTE:

PRIOR TO THE ISSUANCE OF ANY CONSTRUCTION PERMIT, THE OWNER/ PERMITTEE SHALL INCORPORATE ANY BEST MANAGEMENT PRACTICES NECESSARY TO COMPLY WITH CHAPTER 14, ARTICLE 2, DIVISION 1 (GRADING REGULATIONS) OF THE SAN DIEGO MUNICIPAL CODE, INTO THE CONSTRUCTION PLANS OR SPECIFICATIONS.

PRIOR THE ISSUANCE OF ANY CONSTRUCTION PERMIT THE OWNER/ PERMITTEE SHALL SUBMIT A WATER POLLUTION CONTROL PLAN (WPCP). THE WPCP SHALL BE PREPARED IN ACCORDANCE WITH GUIDELINES IN PART 2 CONSTRUCTION BMP STANDARDS CHAPTER 4 OF THE CITY'S STORM WATER STANDARDS.

ENCROACHMENT MAINTENANCE AND REMOVAL AGREEMENT (EMRA) WILL BE REQUIRED FOR ALL PRIVATE **IMPROVEMENTS**

ALL PROPOSED PUBLIC DOMESTIC WATER SERVICE LINE DIAMETERS ARE PROVIDED FOR CLARITY OF INTENT ONLY. ACTUAL SERVICE LINE DIAMETERS WILL BE BASED UPON THE PUBLIC UTILITIES APPROVED WATER METER DATA CARD.

NOTE:

PROPOSED DRIVEWAY PER CITY STANDARD SDG-159

PER SDMC 143.0143(d) ALL DRAINAGE FROM THE IMPROVEMENTS ON THE PREMISES SHALL BE DIRECTED AWAY FROM COASTAL BLUFF AND DIRECTED INTO EXISTING STORM DRAIN SYSTEM.



7

PROJECT# 1066101 SHEET TITLE:

GRADING PLAN SCALE:

6/15/2022

2/1/2023 **REVISION 2:**

6/14/2023 **REVISION 3:**

REVISION 1

10/9/2023 **REVISION 4**: 11/29/2023

REVISION 5:

REVISION 6: 1/12/24 FINAL DOCUMENT 2/26/24

SHEET NAME:

SHEET TITLE:

DEMOLITION PLAN

DATE: 6/15/2022

REVISION 1:

2/1/2023 REVISION 2: 6/14/2023

REVISION 3: 10/9/2023

REVISION 4: 11/29/2023 REVISION 5:


REVISION 5: 1/9/24

REVISION 6: 1/12/24 FINAL DOCUMENT 2/26/24

SHEET NAME:

DEMOLITION AND REMOVAL PLAN
SCALE: 1' = 1'-0"

T1.3

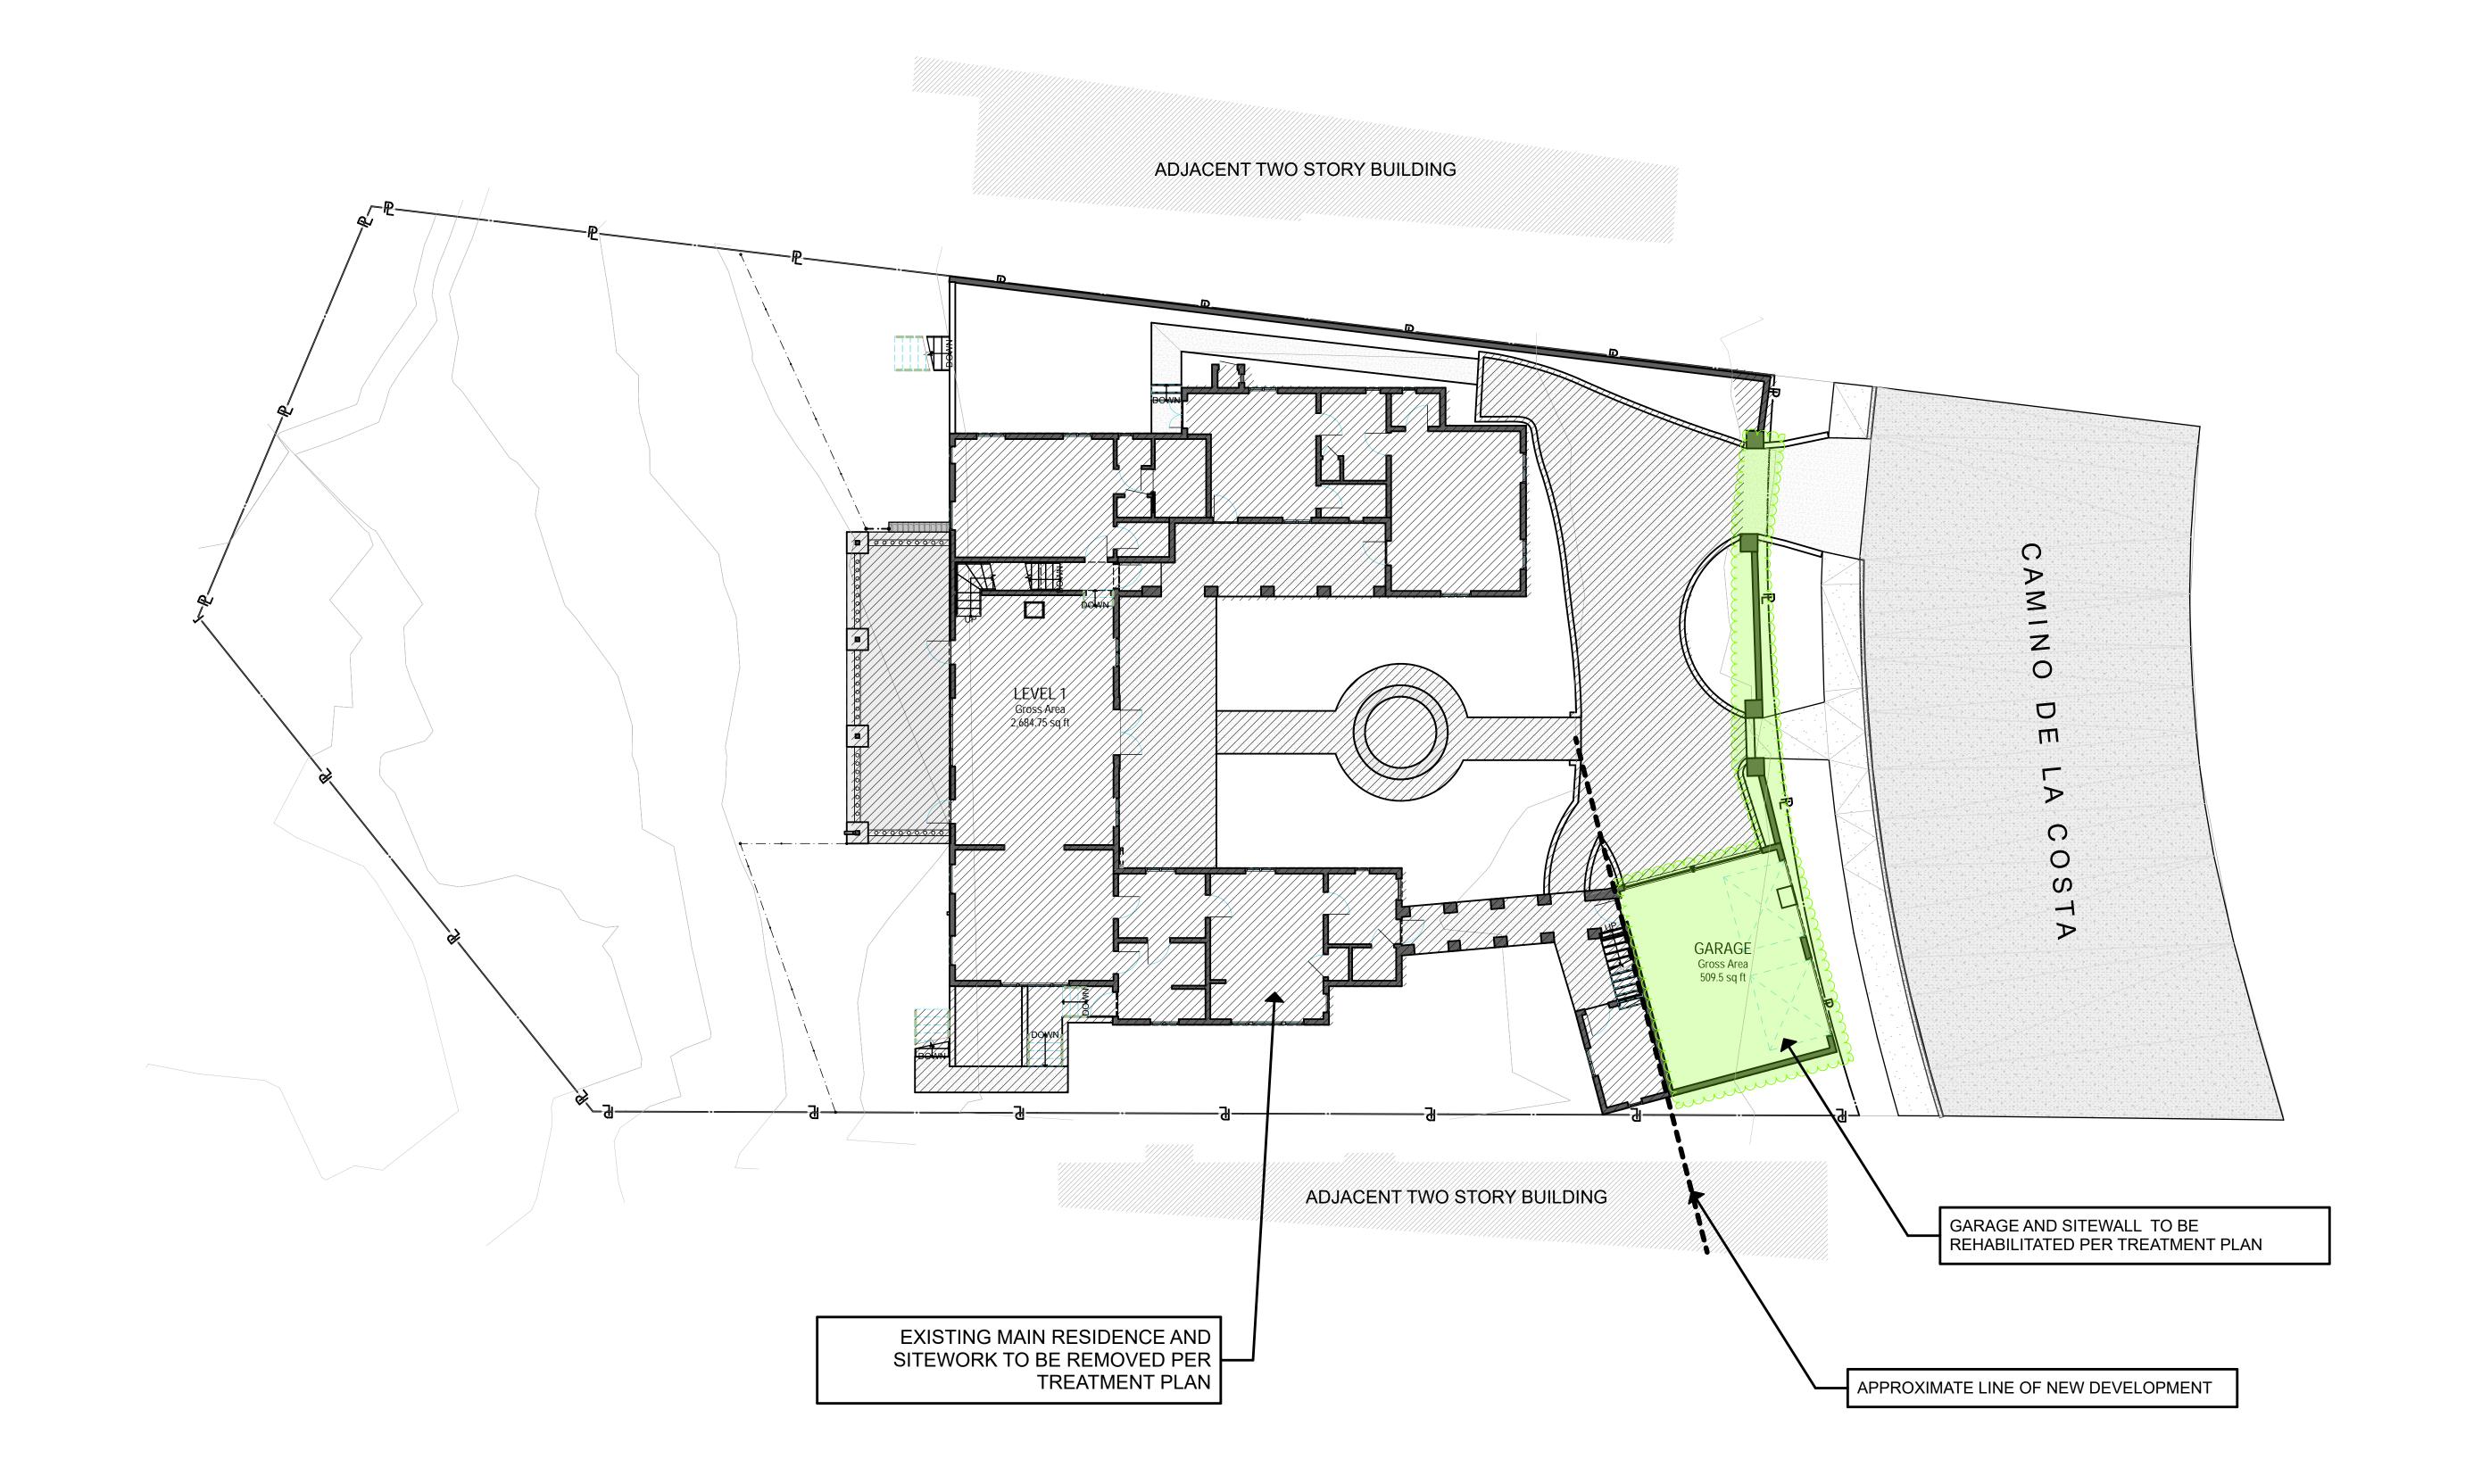

ATTACHMENT 9

PRIOR TO THE ISSUANCE OF ANY CONSTRUCTION PERMIT, THE OWNER/PERMITTEE SHALL

SHEET TITLE:

SITE PLAN

6/15/2022

REVISION 2: 6/14/2023 **REVISION 3:**


10/9/2023 **REVISION 4**:

11/29/2023

REVISION 6: 1/12/24 FINAL DOCUMENT 2/26/24

SHEET NAME:

A0.0

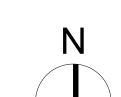

SHEET TITLE:

BASEMENT LEVEL


6/15/2022 2/1/2023

6/14/2023 REVISION 3: 10/9/2023

REVISION 6: 1/12/24 FINAL DOCUMENT 2/26/24

SHEET NAME:

A1.0

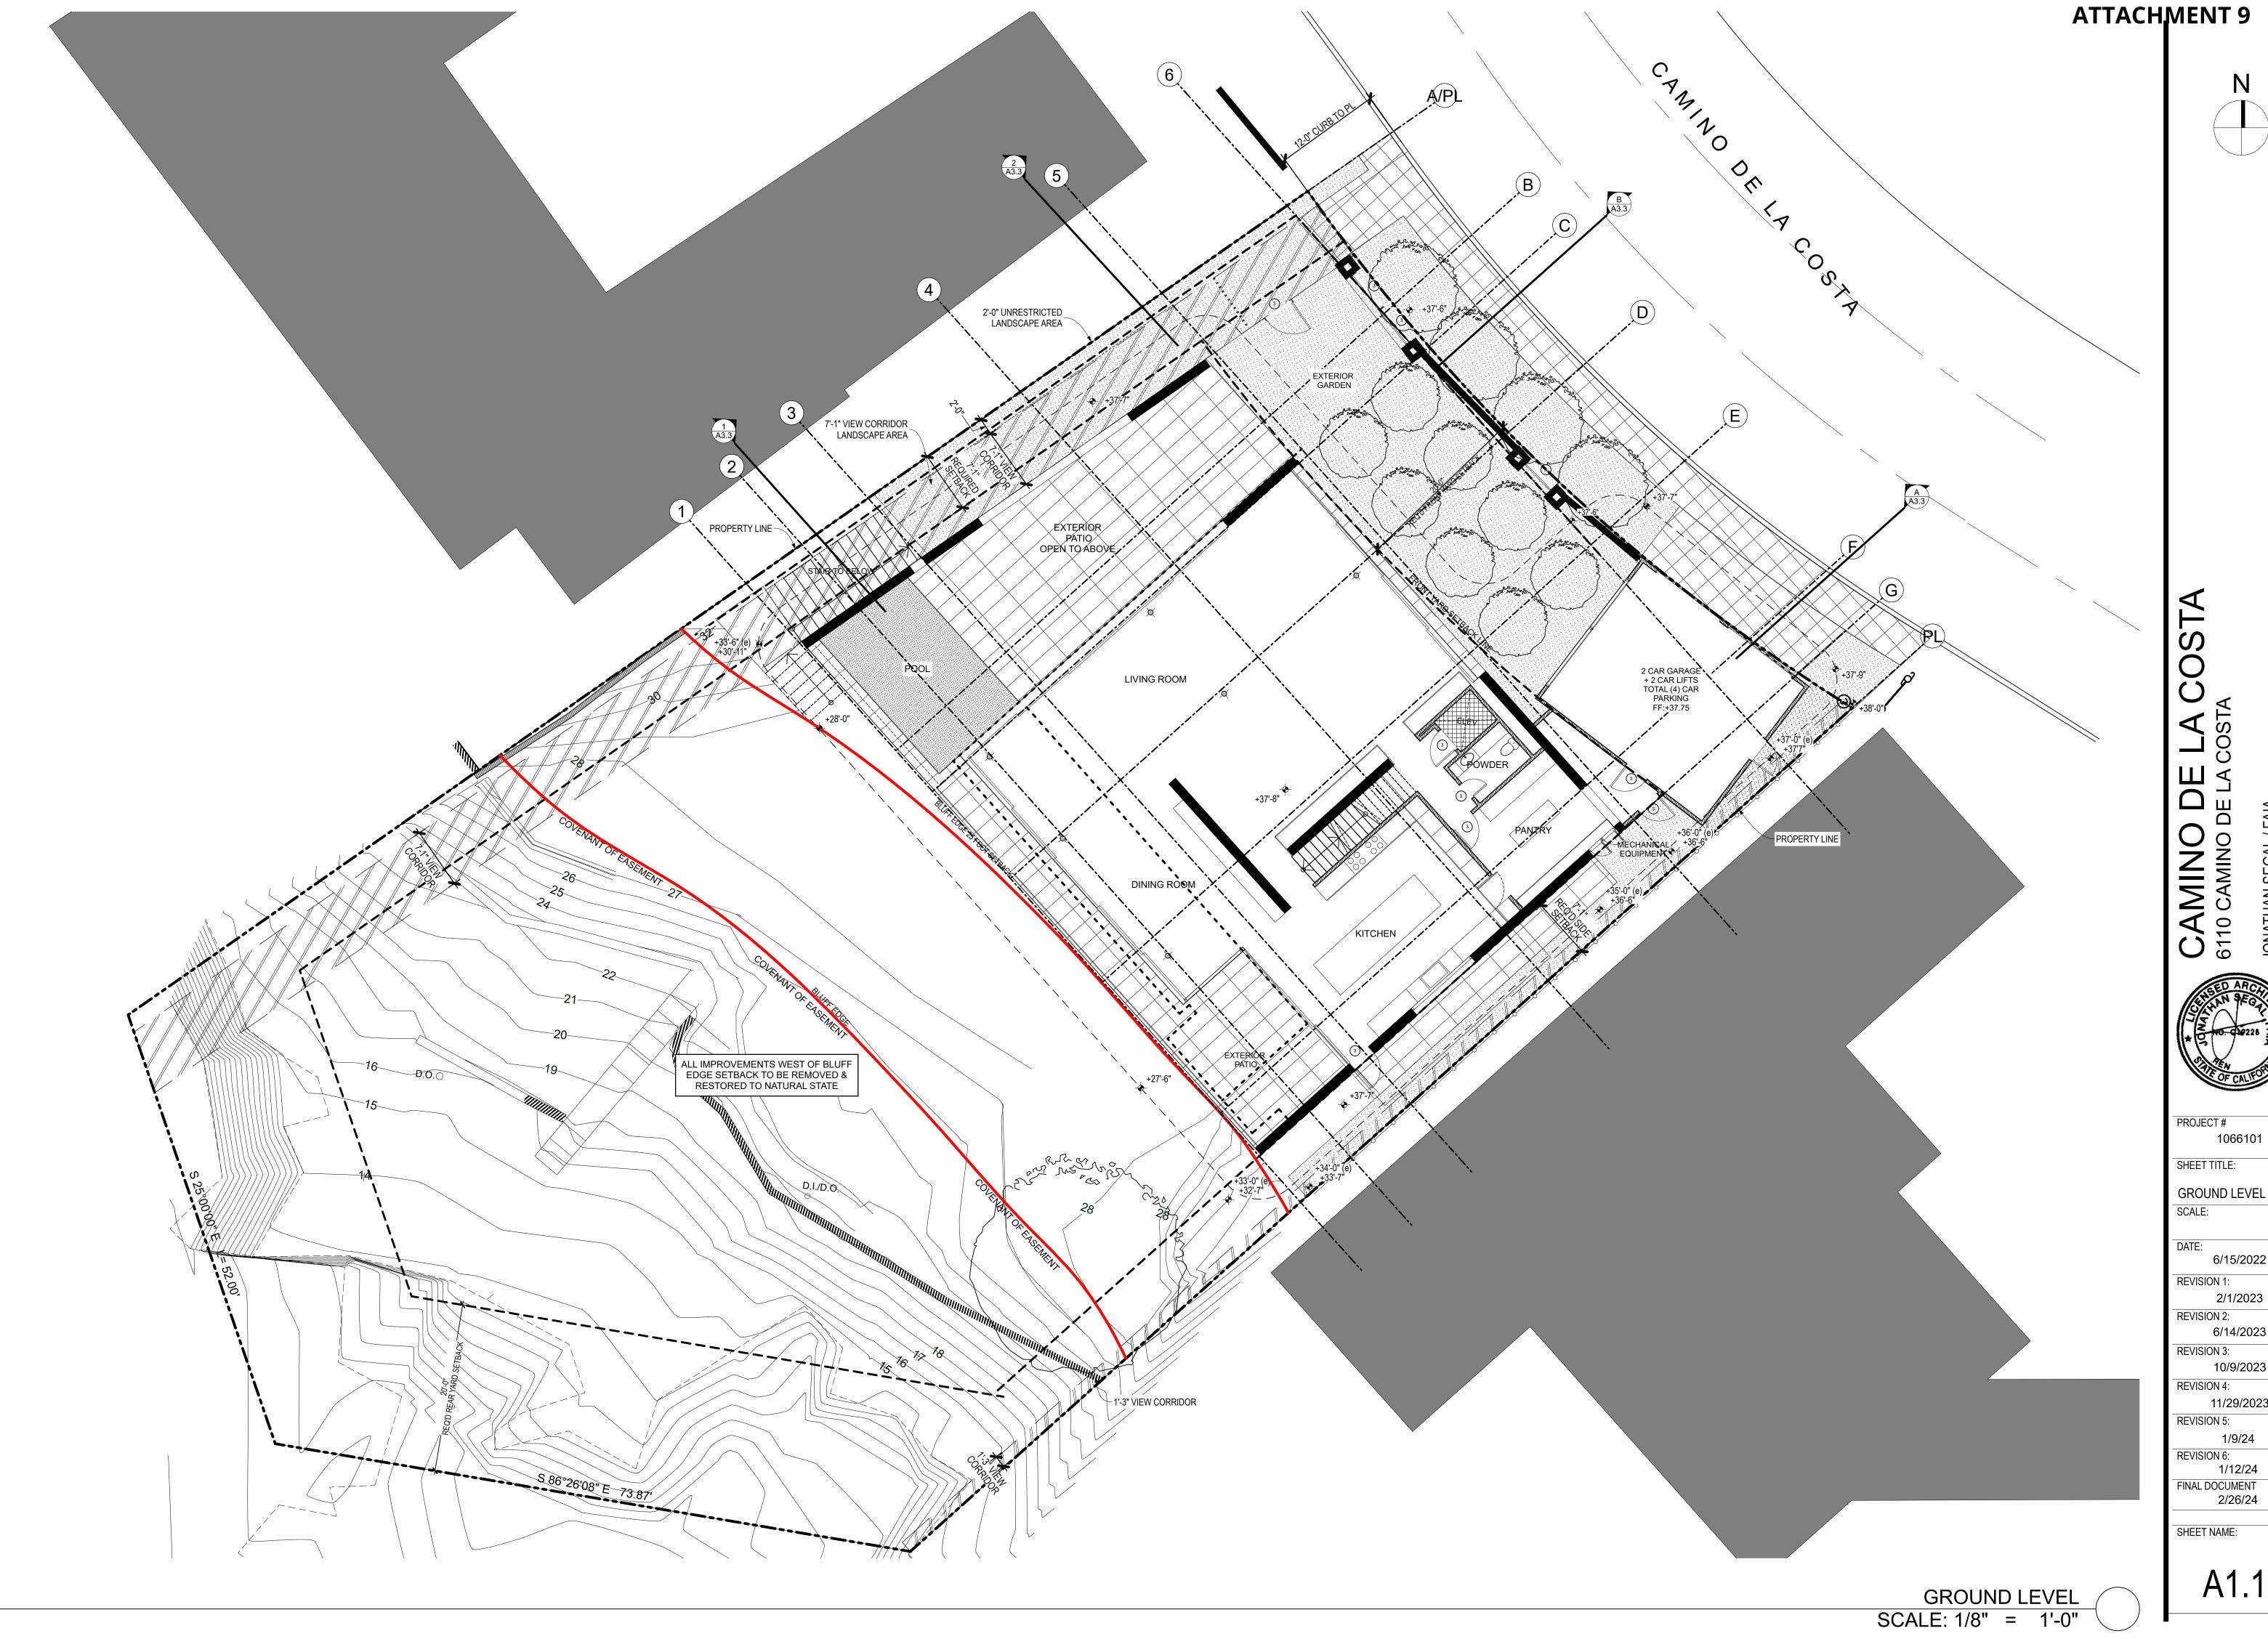

6/15/2022

2/1/2023

6/14/2023 10/9/2023

1/12/24 FINAL DOCUMENT 2/26/24

A1.1


BASEMENT LEVEL SCALE: 1/16" = 1'-0"

NOTE: BASEMENT AREA EXCLUDED IN GROSS FLOOR AREA PER SDMC SECTION 113.0234 & DIAGRAM 113-02J BASEMENTS WITH 5% OR MORE SLOPE FAR:


:0000 SQFT BASEMENT LEVEL LEVEL 1 (GROUND LEVEL) :3320 SQFT :3323 SQFT LEVEL 2


TOTAL FAR :6643 SQ FT :7708 SQ FT ALLOWED FAR

COMPLIANCE 6643 < 7708 SQ FT

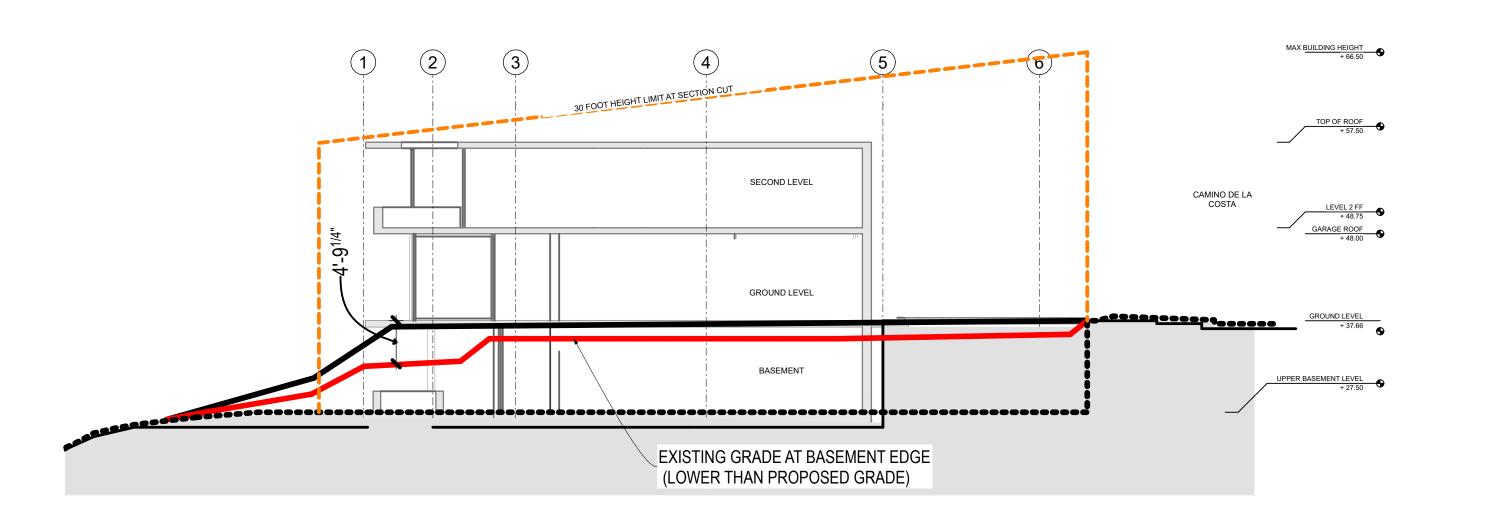

SECTION FAR DIAGRAM LONG SCALE: 3/32" = 1'-0"

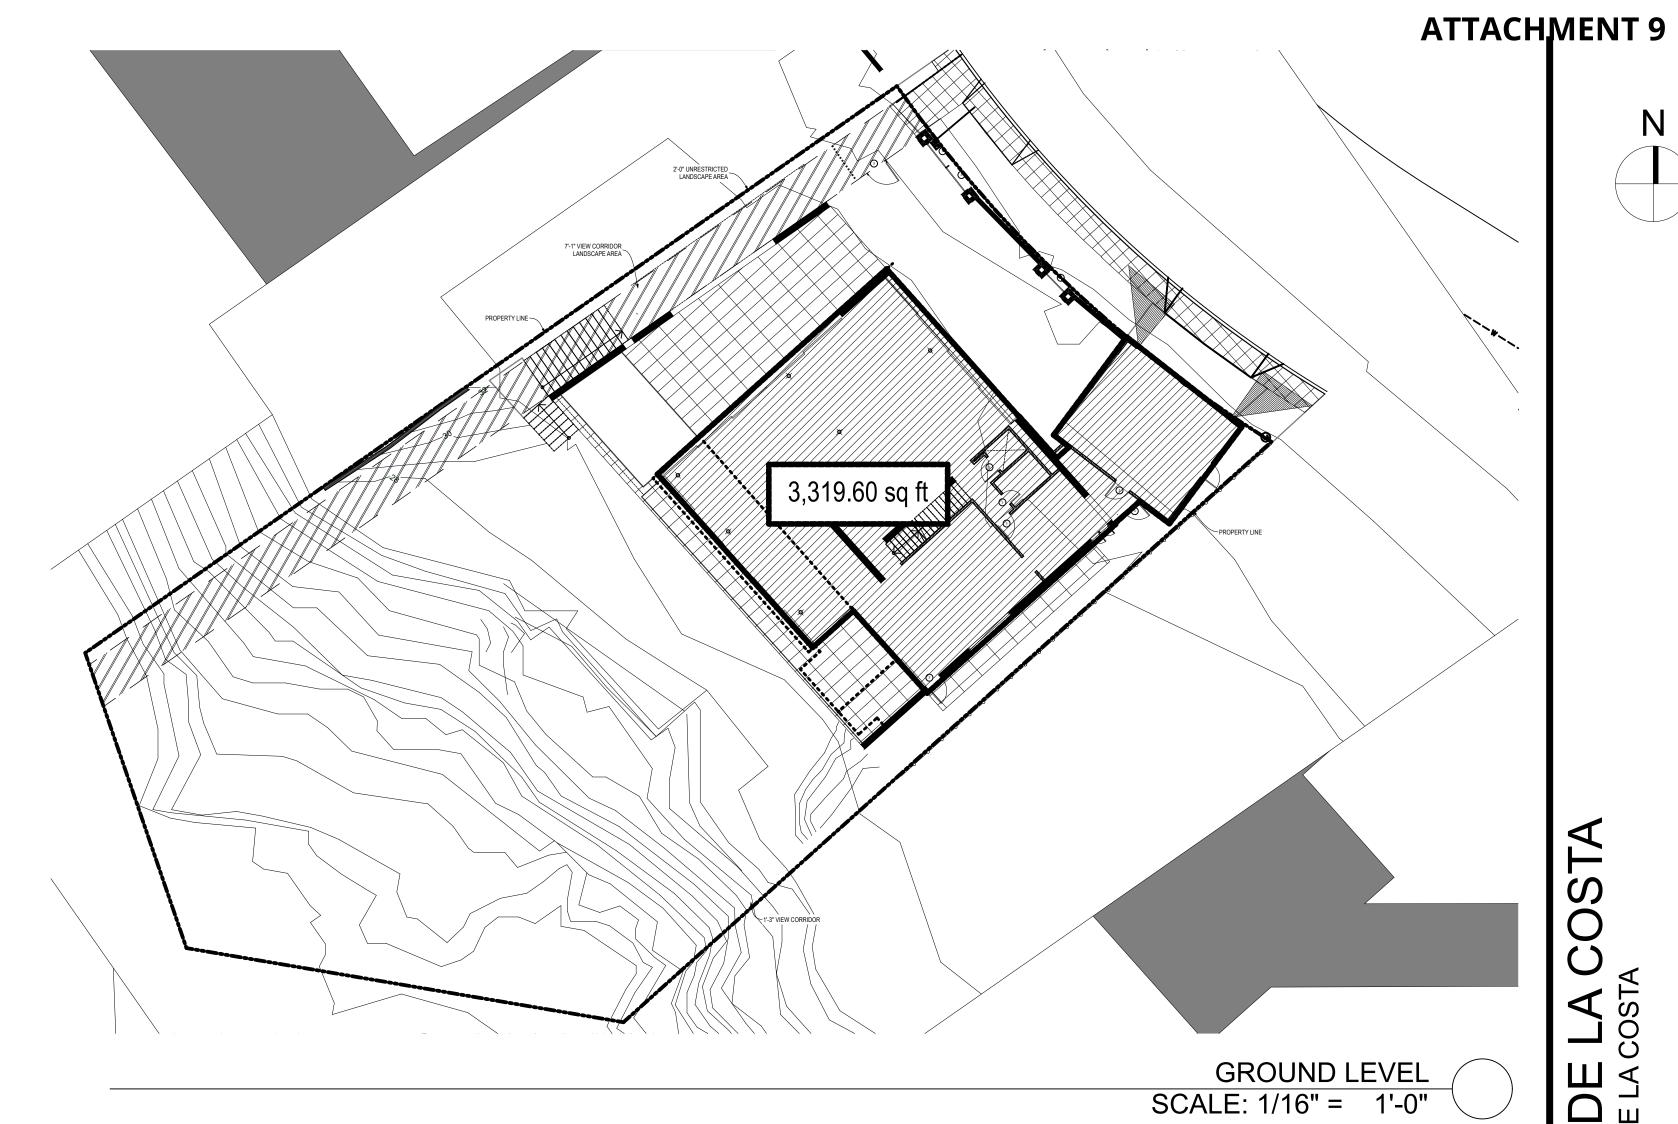

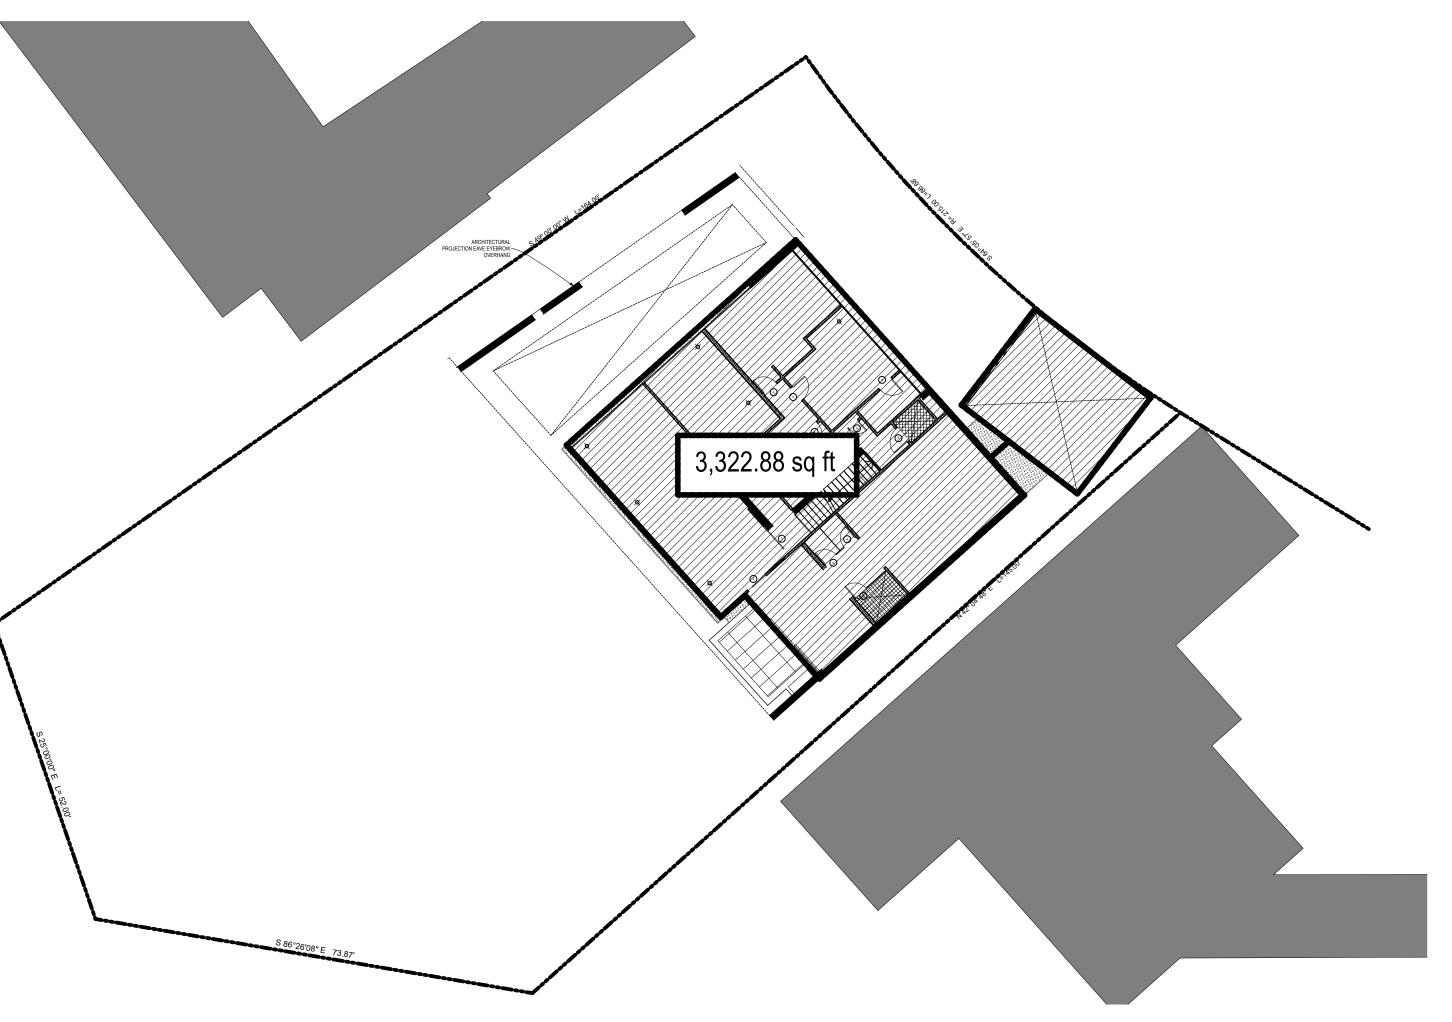

JONATHAN SEGAL / FAIA 3000 Upas Street Suite 101 San Diego, CA 92104



1066101 SHEET TITLE:

FAR DIAGRAM

6/15/2022

2/1/2023 REVISION 2: 6/14/2023

REVISION 3: 10/9/2023 REVISION 4:

11/29/2023

REVISION 6: 1/12/24 FINAL DOCUMENT 2/26/24

SHEET NAME:

SECOND LEVEL

SCALE: 1/16" = 1'-0"

A1.4



NOS DARCHINOS DE CALIFORNIO DE

PROJECT #
1066101
SHEET TITLE:

NORTH ELEVATION SCALE:

DATE: 6/15/2022 REVISION 1:

NORTH SCALE: 3/16" = 1'-0"

2/1/2023 REVISION 2: 6/14/2023


REVISION 3: 10/9/2023 REVISION 4:

REVISION 4: 11/29/2023 REVISION 5: 1/9/24

REVISION 6: 1/12/24 FINAL DOCUMENT 2/26/24

SHEET NAME:

A2.0

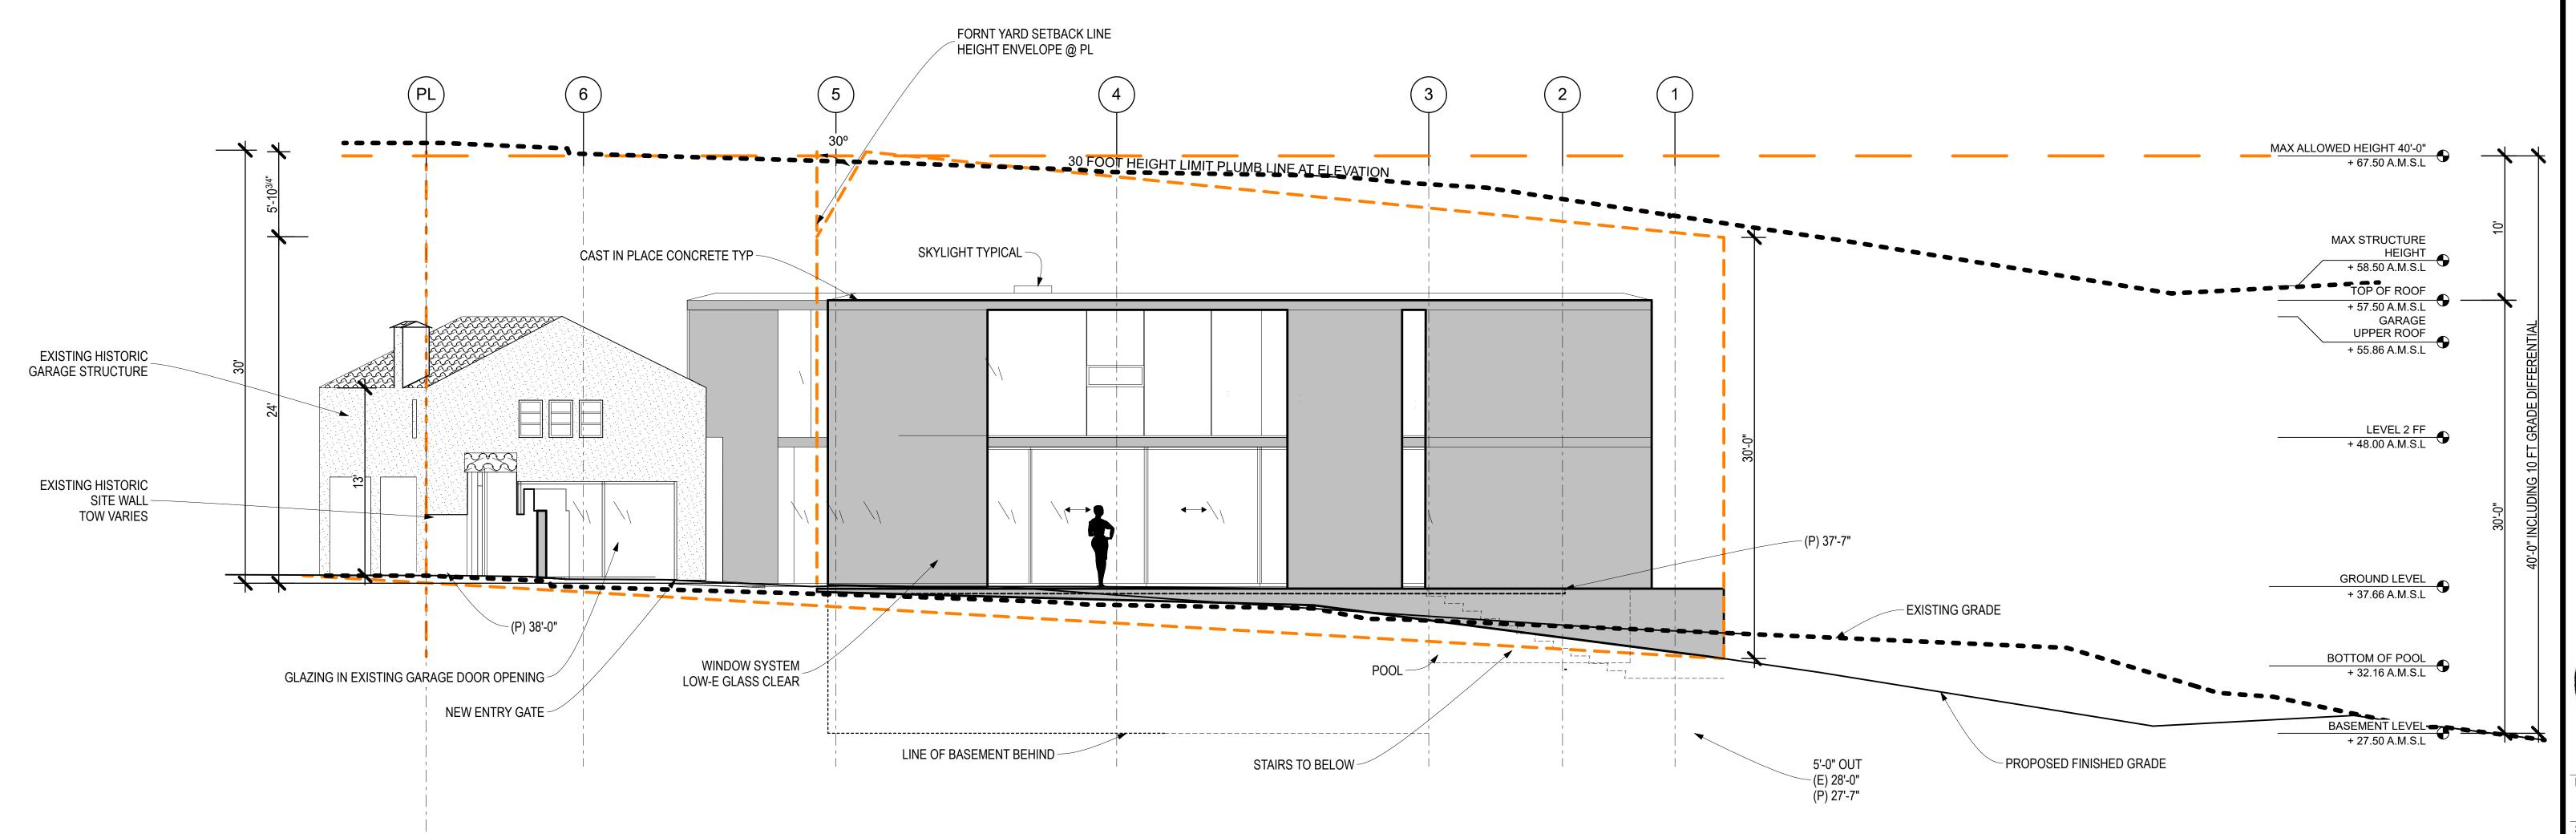

SHEET TITLE:

EAST ELEVATION

SCALE:

EAST

SCALE: 3/16" = 1'-0"

DATE: 6/15/2022

REVISION 1: 2/1/2023 REVISION 2: 6/14/2023


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REVISION 4: 11/29/2023 REVISION 5: 1/9/24

REVISION 6: 1/12/24 FINAL DOCUMENT 2/26/24

SHEET NAME:

A2 1



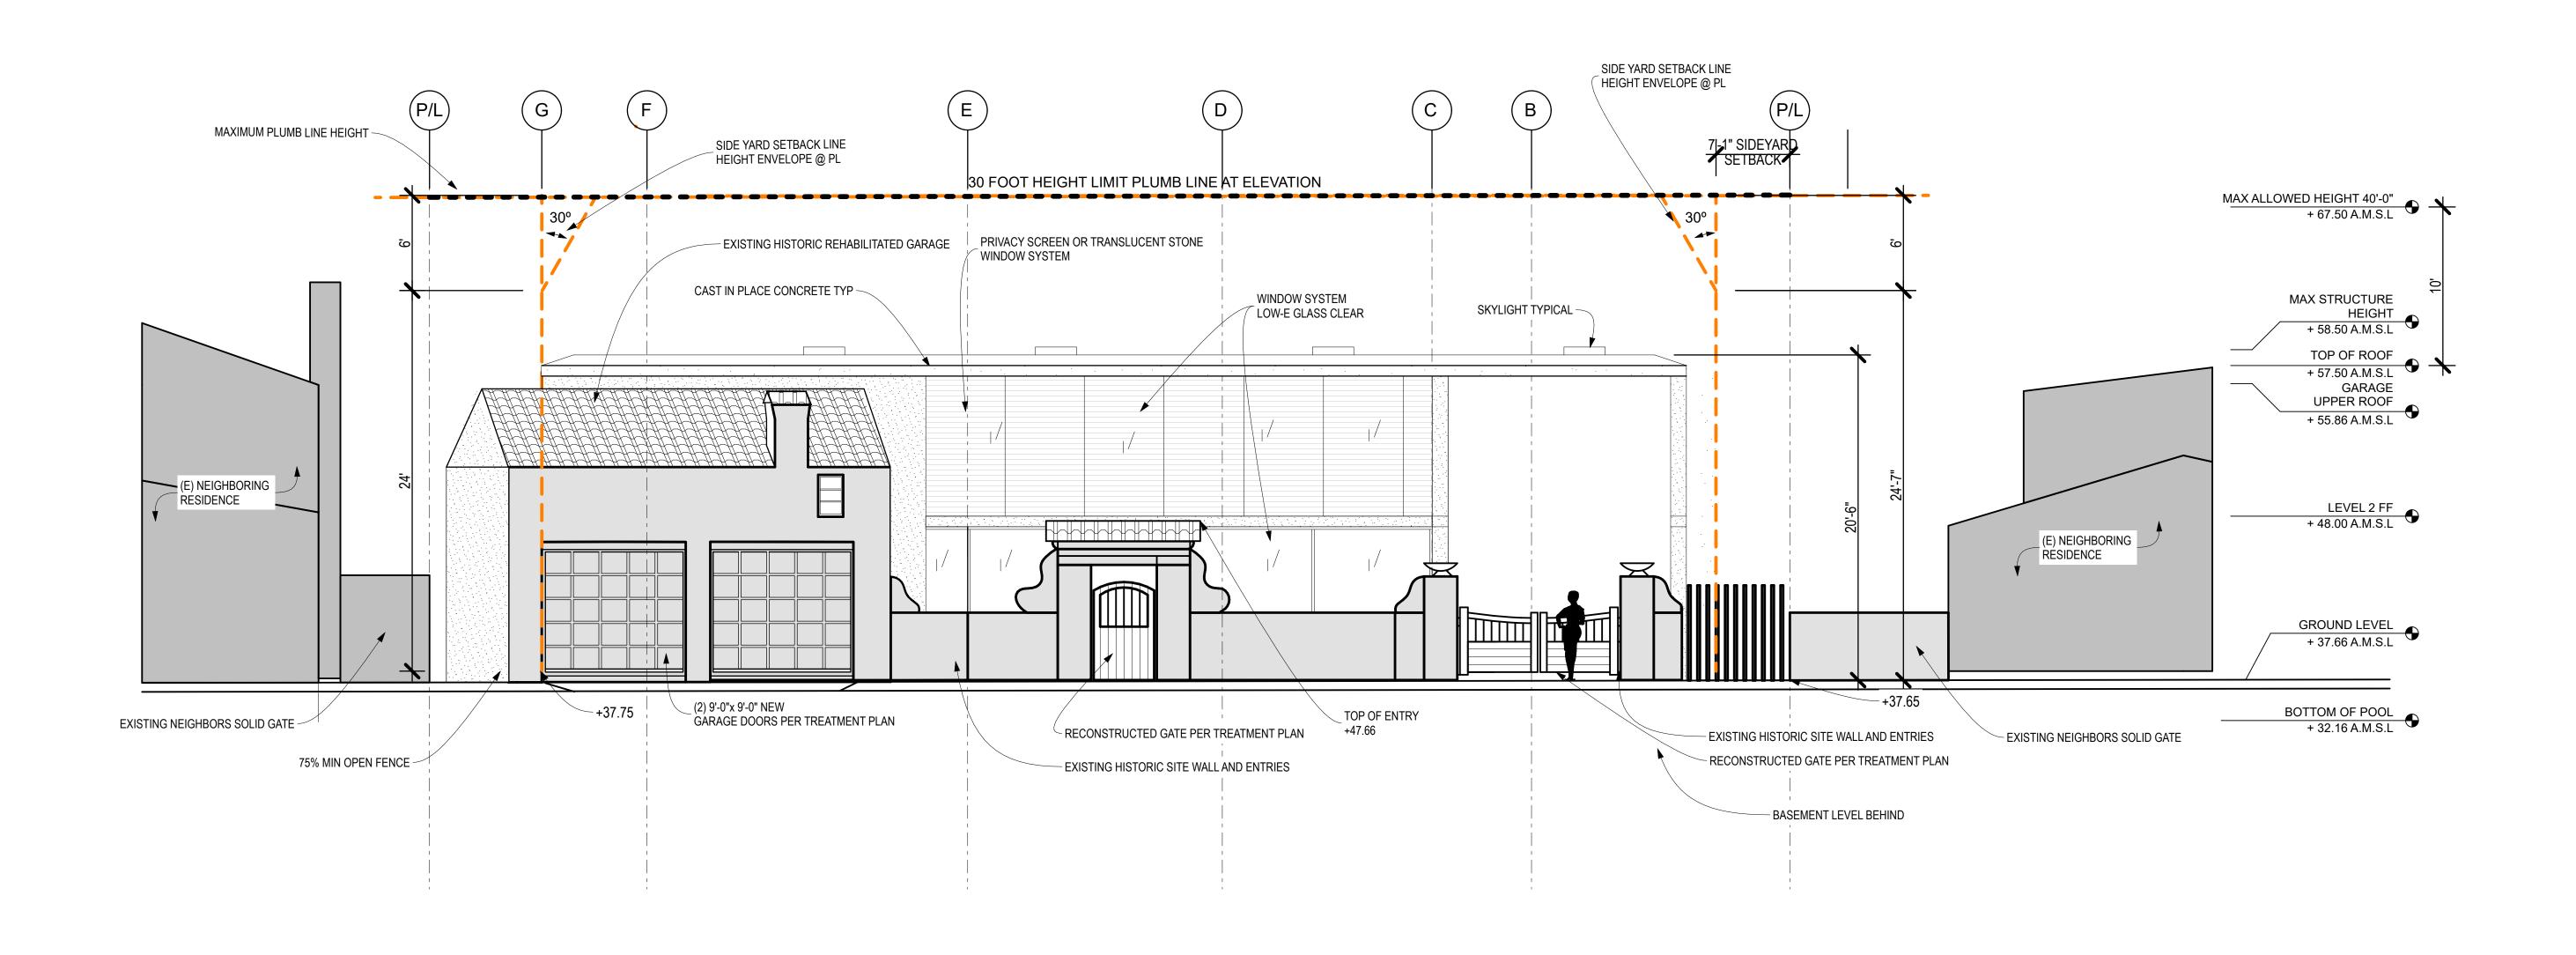

1066101 SHEET TITLE:

SOUTH ELEVATION SCALE:

SOUTH

SCALE: 3/16" = 1'-0"

6/15/2022 REVISION 1: 2/1/2023


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REVISION 4: 11/29/2023 REVISION 5:


REVISION 6: 1/12/24 FINAL DOCUMENT 2/26/24

SHEET NAME:

A2.2



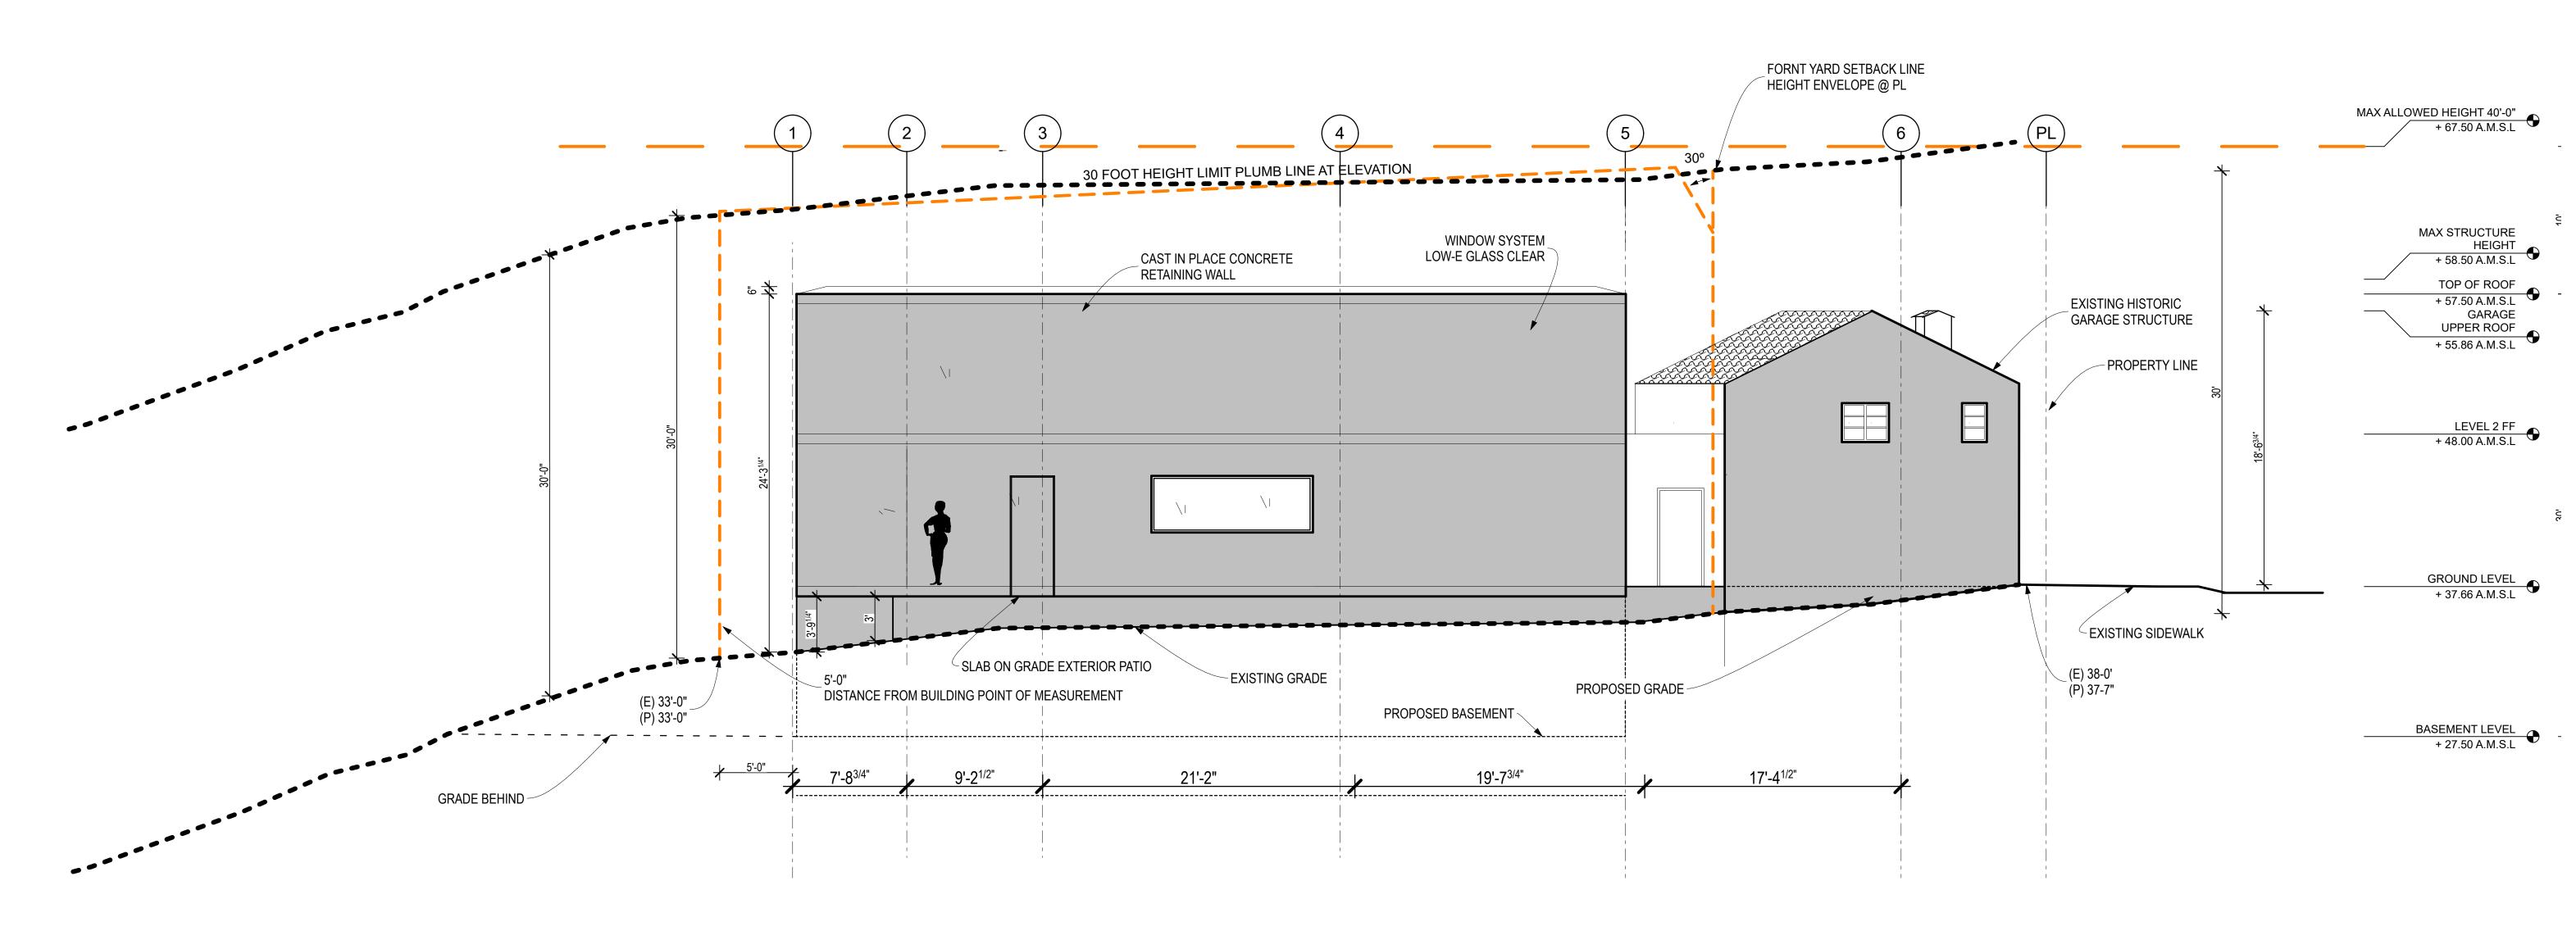

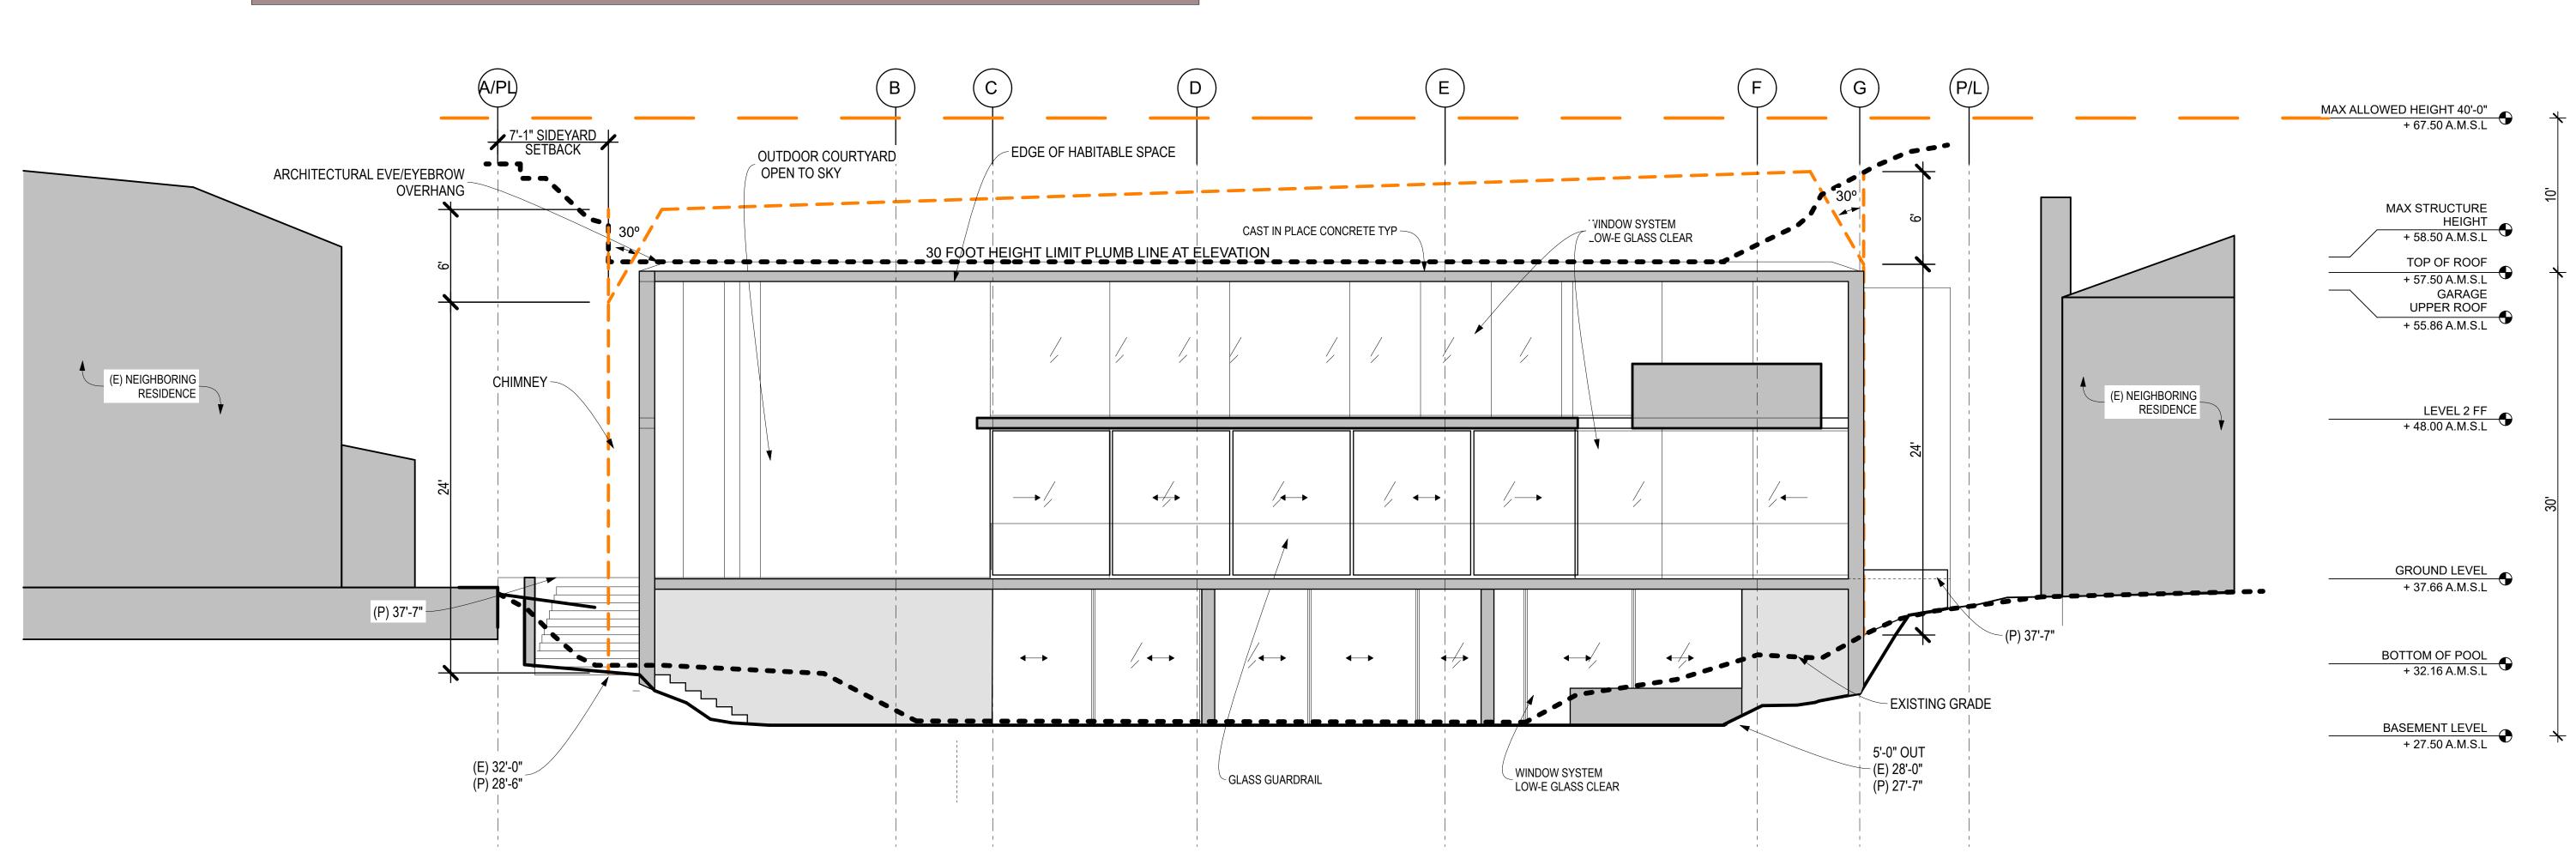

WEST SCALE: 3/16" = 1'-0"

JONATHAN SEGAL / FAIA 3000 Upas Street Suite 101 San

DATE: 6/15/2022 REVISION 1: 2/1/2023

REVISION 2: 6/14/2023 REVISION 3: 10/9/2023

10/9/2023 REVISION 4: 11/29/2023

REVISION 5: 1/9/24 REVISION 6:

1/12/24 FINAL DOCUMENT 2/26/24

SHEET NAME:

A2.3

N

CAMINO DE LA COSTA 6110 CAMINO DE LA COSTA

JONATHAN SEGAL / FAIA 3000 Upas Street Suite 101 San Diego, CA 92104

AFCAIL FAIA

AFCAI

1066101

SHEET TITLE:
NORTH SOUTH

SECTION
SCALE:
DATE:

6/15/2022 REVISION 1: 2/1/2023

REVISION 2: 6/14/2023 REVISION 3:


REVISION 3: 10/9/2023 REVISION 4:

11/29/2023 REVISION 5: 1/9/24

REVISION 6: 1/12/24 FINAL DOCUMENT 2/26/24

SHEET NAME:

A3.0

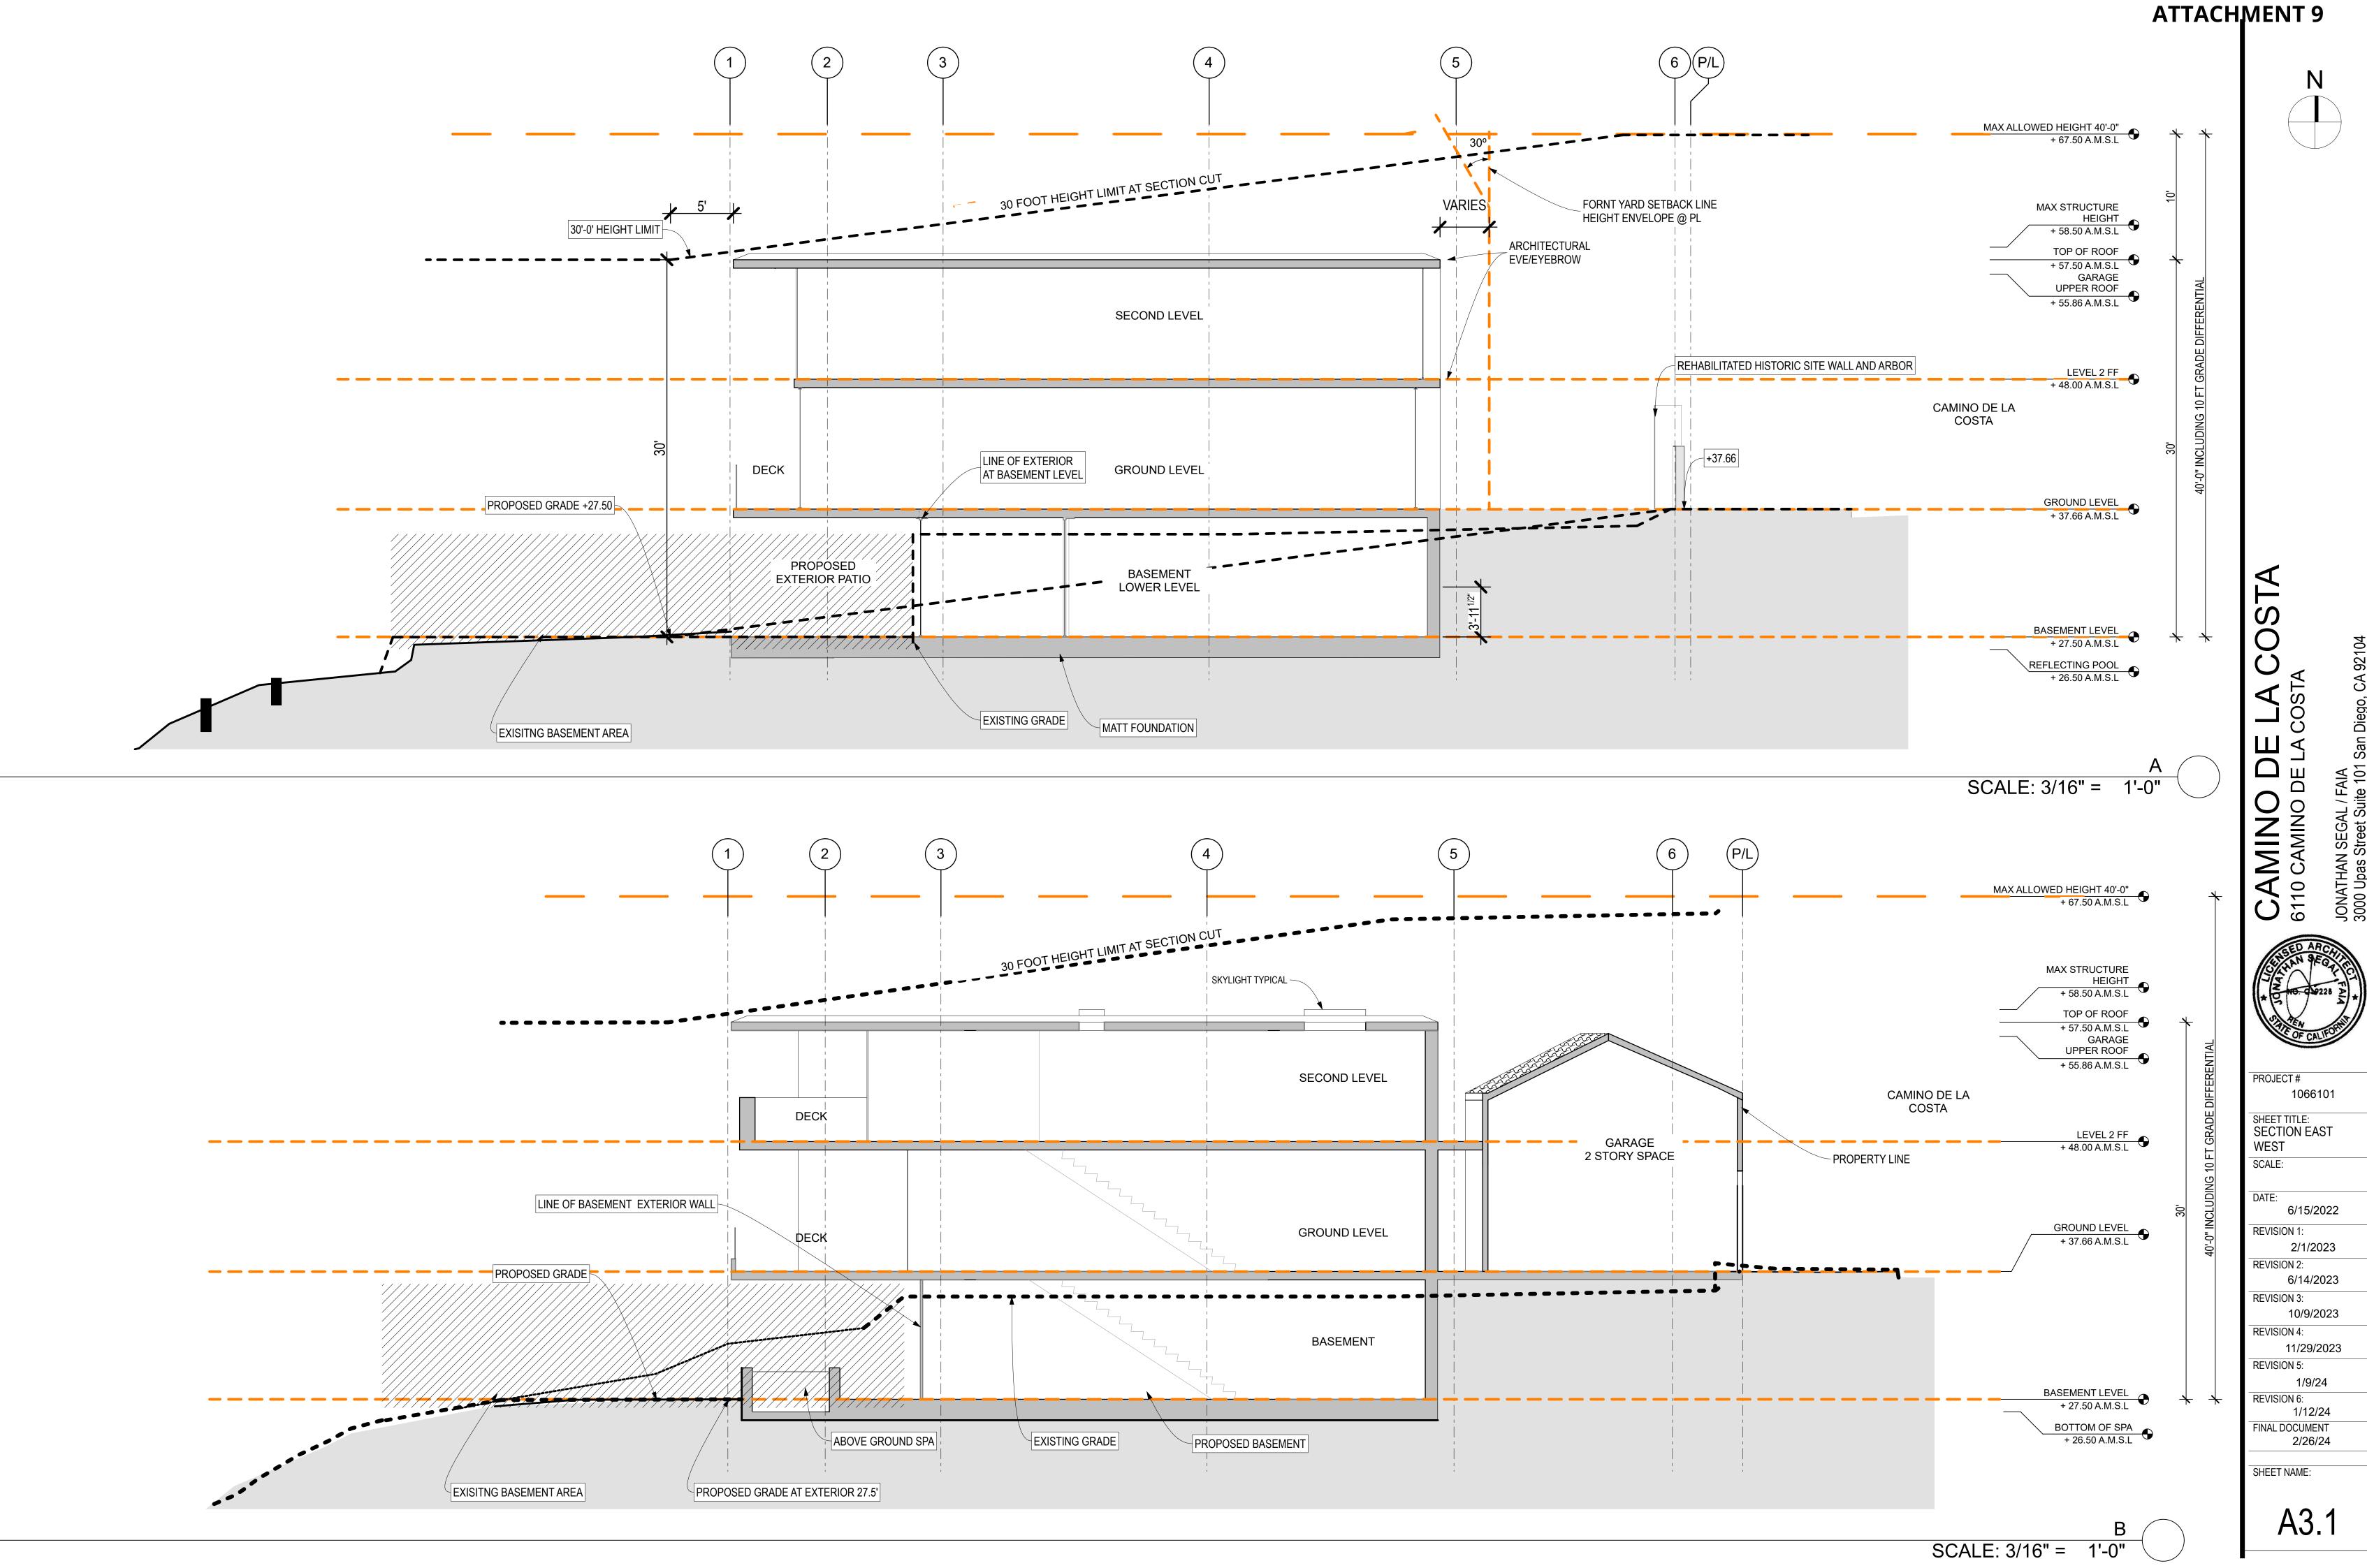

1066101 SHEET TITLE: LANDSCAPE BASEMENT LEVEL

SCALE: 6/15/2022

2/1/2023 **REVISION 2:**

6/14/2023 **REVISION 3:** 10/9/2023 **REVISION 4:**

11/29/2023 **REVISION 5:**


REVISION 6: 1/12/24 FINAL DOCUMENT

2/26/24

SHEET NAME:

BASEMENT LEVEL LANDSCAPE

SCALE: 1/8" = 1'-0"

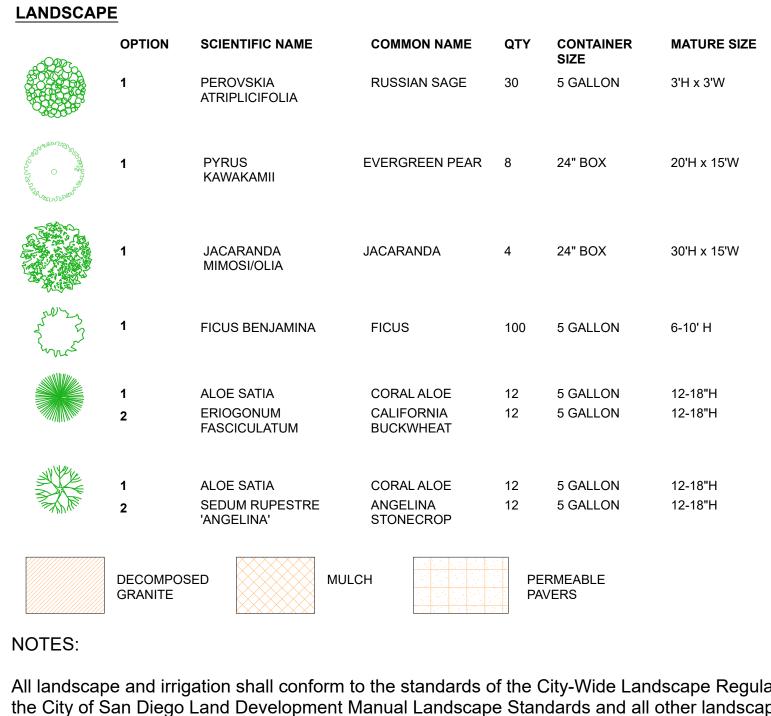

All landscape and irrigation shall conform to the standards of the City-Wide Landscape Regulations and the City of San Diego Land Development Manual Landscape Standards and all other landscape related City and Regional Standards.

Maintenance: All required landscape areas shall be maintained by Owner. Landscape and irrigation areas in the public right-of-way shall be maintained by Owner. The landscape areas shall be maintained free of debris and litter, and all plant material shall be maintained in a healthy growing condition. Diseased or dead plant material shall be satisfactorily treated or replaced within 30 days of a final landscape inspection."

Trees shall be maintained so that all branches over pedestrian walkways are 6 feet above the walkway grade and branches over vehicular travel ways are 16 feet above the grade of the travel way per SDMC 142.0403(b)(11)

A minimum root zone of 40sf in area shall be provided for all trees. The minimum dimension for this area shall be 5 feet, per SDMC 142.0403(b)(5)

Tree root barriers shall be installed where trees are placed within 5 feet of public improvements including walks, curbs, or street pavements or where new public improvements are placed adjacent to existing trees. The root barrier will not wrap the root ball".

All pruning shall comply with the standards of the American National Standards Institute (ANSI) for tree care operations and the International Society of Arboriculture (ISA) for tree pruning. Topping of trees is not

Mulch: All required planting areas and all exposed soil areas without vegetation shall be covered with mulch to a minimum depth of 3 inches, excluding slopes requiring revegetation per SDMC 142.0411.

MINIMUM TREE SEPARATION DISTANCE

Traffic signals / stop signs - 20 feet

Underground utility lines - 5 feet (10' for sewer)

Above ground utility structures - 10 feet

Driveway (entries) - 10 feet (5' for residential streets < 25mph) Intersections (intersecting curb lines of two streets) - 25 feet

Maximum	Applied W	ater Allowa	ance (MAWA)					
ETWU = [(ETo)(0.62)][(PF/IE x H/	A/IE) + SLA] =	gallons per year					
ЕТо	40	Evaptranspiration	on (inches per year)					
CONV FACTOR	0.62							
PF	0.1	plant factor						
HA	2609	total hydrozone	area sq ft					
IE	0.81	Irrigation Efficie	ncy					
		(.81 for Drip Sys	stems)					
SLA	0	Special Landsc	sape Area					
	14,874	Total Gallons A	Allowed					
Controller No	Hydrozone No	Valve Circuit	Plant Factor	Hydrozone Area in SF	Irrigation Method	Irrigation Effiency	% Total Landscape	Allowed Gallons
1	1	1	0.2	995	Microsprayers	0.75	38.14%	8773
2	2	2	0.1	1003	Drip	0.81	38.44%	3791
3	3	3	0.1	198	Drip	0.81	7.59%	748
4	4	4	0.1	413	Drip	0.81	15.83%	1561

Estimated To	tal Water Use	e (ETWU)					
Hydrozone	ETo	Factor	Plant Factor	Hydrozone Area	Irrigation Efficiency	Special Lanscape Aea	Gallons
	(Annual Inches)	(Conversion)	(PF)	(HA)	(IE)	(SLA)	(ETWU)
1-MicroSprayer	40	0.62	0.2	995	0.75	0	6580
2-Drip	40	0.62	0.1	1003	0.81	0	3071
3-Drip	40	0.62	0.1	198	0.81	0	606
4-Drip	40	0.62	0.1	413	0.81	0	1264
			Total Area=	2,609			
						ETWU Total =	11,522
MWELO Req	uirement						
ETWU Total	<	MAWA					

14,874

11,522





ATTACHMENT 9

6/15/2022

2/1/2023

6/14/2023

11/29/2023

1/12/24