


BALBOA PARK ACTIVITY CENTER 2117 PARK BOULEVARD SAN DIEGO, CA 92101 NAVAL HOSPITAL

VICINITY MAP

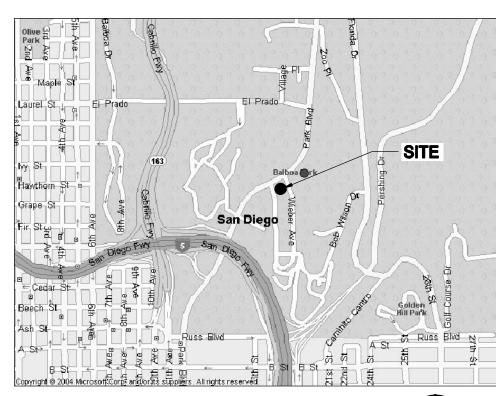



THOMAS GUIDE PAGE 1289, C1

ADDRESS: 2117 PARK BOULEVARD SAN DIEGO, CA 92101

COORDINATES OF ANTENNA SECTORS (NAD 83) ALPHA,: LATITUDE: 32° 43' 37.81" NORTH

BETA & LONGITUDE: 117° 08' 50.93" WEST

COORDINATES OF ANTENNA SECTORS (NAD 27) ALPHA,: LATITUDE: 32° 43' 37.63" NORTH BETA & LONGITUDE: 117° 08' 47.81" WEST

DIRECTIONS:

(FROM VZW'S OFFICES IN IRVINE:) TAKE I-5 SOUTH TO I-805 SOUTH; CONTINUE ON I-805 SOUTH TO I-163 SOUTH; CONTINUE SOUTH ON I-163 TO PARK BOULEVARD EXIT; TAKE THE PARK BOULEVARD EXIT AND TURN LEFT ON PARK BOULEVARD; CONTINUE NORTH ON PARK BOULEVARD AND FOLLOW SIGNS TO ACTIVITY CENTER.

NOTE

THE ANTENNAS ARE LOCATED MORE THAN 100 FEET FROM THE PROPERTY LINE OF THE FOLLOWING PRIMARY USES: DAY CARE, ELEMENTARY OR MIDDLE SCHOOL, OR RESIDENTIAL. THIS WILL DETERMINE THE PERMIT PROCESS LEVEL.

CONSULTANT TEAM

ARCHITECT:

BOOTH & SUAREZ ARCHITECTURE, INC. 325 CALSBAD VILLAGE DRIVE, SUITE D2 CARLSBAD, CA 92008 (760) 434-8474 (760) 434-8596 (FAX)

LEASING/PLANNING:

PLANCOM, INC. BRENT HELMING **302 STATE PLACE** ESCONDIDO, CA 92029 (760) 533-6065

FLOYD SURVEYING 11576 NORGATE CIRCLE CORONA, CA 92880 (951) 739-7949

SURVEYOR:

PERMITS REQUIRED

● PLANNED DEVELOPMENT PERMIT (PDP) - PROCESS 4

SCALE

THE DRAWING SCALES SHOWN IN THIS SET REPRESENT THE CORRECT SCALE ONLY WHEN THESE DRAWINGS ARE PRINTED IN A 24" x 36" FORMAT. IF THIS DRAWING SET IS NOT 24" x 36", THIS SET IS NOT TO SCALE.

PROJECT SUMMARY

APPLICANT: VERIZON WIRELESS

15505 SAND CANYON AVENUE IRVINE, CA 92618

PHONE: (760) 533-6065

1200 THIRD AVENUE, SUITE 1700 SAN DIEGO, CA 92101

CONTACT: CAROL YOUNG SUPERVISING PROPERTY AGENT PHONE: (619) 236-6081

PROJECT DESCRIPTION:

- INSTALLATION OF VERIZON WIRELESS TELECOMMUNICATION EQUIPMENT RACKS INSIDE A NEW POUR-IN-PLACE CONCRETE EQUIPMENT BUILDING ON A CONCRETE PAD
- INSTALLATION OF THREE (3) VERIZON WIRELESS ANTENNA SECTORS. OF FOUR (4) ANTENNAS EACH (TOTAL OF 12 ANTENNAS) INSIDE A NEW 54'-1" HIGH POUR-IN-PLACE CONCRETE MONUMENT TOWER BEHIND RF TRANSPARENT SCREENS
- INSTALLATION OF TWO (2) NEW GPS ANTENNAS
- INSTALLATION OF A NEW 200 AMP ELECTRICAL SERVICE FROM EXISTING SDG&E ELECTRICAL TRANSFORMER
- INSTALLATION OF A NEW TELCO SERVICE CONNECTION FROM
- EXISTING TELCO ROOM AT GRADE LEVEL • MINOR LANDSCAPE AND IRRIGATION IS PLANNED FOR THIS PROJECT

PROJECT ADDRESS:

2117 PARK BOULEVARD SAN DIEGO, CA 92101

52,515 SF

TYPE VB

ASSESSORS PARCEL NUMBER: 534-450-11 **EXISTING ZONING:** UNZONED

TOTAL SITE AREA: 1,504,286 SF 34.53 ACRES

EXISTING & PROPOSED BUILDING AREA:

EXISTING BUILDING "A" AREAS 37,969 SF EXISTING BUILDING "B" AREA: 7,725 SF EXISTING BUILDING "C" AREA: 6,480 SF PROPOSED VERIZON BUILDING AREA: 247 SF PROPOSED MECH. ENCLOSURE AREA: 94 SF

PROPOSED PROJECT AREA: 341 SF

TOTAL BUILDING AREA:

PROPOSED OCCUPANCY:

NOTE: THERE ARE NO EXISTING TELECOMMUNICATIONS FACILITIES

REQUIRED INFORMATION FOR **AIRPORT AUTHORITY CONSISTENCY DETERMINATION**

1. HEIGHT OF BUILDING(S) ABOVE GRADE:

2. MAXIMUM FEET ABOVE MEAN SEA LEVEL: 306.27 FT. 3. LOT COVERAGE: 3.4%

4. TOTAL BUILDING SPACE AREA: 52,421 SF 5. AREA OF PROPERTY: 1,504,286 SF

6. FLOOR AREA RATIO (FAR):

A. PROPERTY DEED OR TITLE REPORT LISTING CURRENT OWNER

B. ASSESSOR'S PARCEL MAP PAGE SHOWING PROPERTY

C. FAA PART 77 DETERMINATION OF NO HAZARD

SHEET SCHEDULE

TITLE SHEET & PROJECT DATA

SITE PLAN

WATER POLLUTION CONTROL PLANS

ENLARGED SITE PLAN

EQUIPMENT FLOOR PLAN

EQUIPMENT ROOF PLAN & ANTENNA PLAN

EXTERIOR ELEVATIONS

TOWER ELEVATIONS

LANDSCAPE DEVELOPMENT PLAN

PLANTING LEGEND

SITE SURVEY

SITE SURVEY

SITE SURVEY

LEGAL DESCRIPTION:

THAT PORTION OF THE PUEBLO LANDS OF SAN DIEGO, IN THE CITY OF SAN DIEGO, COUNTY OF SAN DIEGO, STATE OF CALIFORNIA, ACCORDING TO MISCELLANEOUS MAPS THEREOF NO. 36 BY JAMES PASCOE, FILED IN THE OFFICE OF THE COUNTY RECORDER OF SAID COUNTY, BEING A PORTION OF PUEBLO LOT 1136 AND PUEBLO LOT 1143 OF SAID PUEBLO LAND ACCORDING TO MISCELLANEOUS MAPS THEREOF NO. 35, BY CHARLES B. POOLE, FILED IN THE OFFICE OF THE COUNTY RECORDER OF SAID COUNTY.

APPLICABLE CODES

ALL WORK SHALL COMPLY WITH THE FOLLOWING APPLICABLE CODES:

CALIFORNIA STATE BUILDING CODE, TITLE 24, 2010 EDITION CALIFORNIA PLUMBING CODE, 2010 EDITION CALIFORNIA MECHANICAL CODE, 2010 EDITION CALIFORNIA ELECTRICAL CODE, 2010 EDITION CALIFORNIA ENERGY CODE, 2010 EDITION


IN THE EVENT OF CONFLICT, THE MOST RESTRICTIVE CODE

SHALL PREVAIL

ACCESSIBILITY DISCLAIMER

THIS PROJECT IS AN UNOCCUPIED WIRELESS PCS TELECOMMUNICATIONS FACILITY AND, ACCORDING TO WRITTEN INTERPRETATION FROM THE CALIFORNIA DEPARTMENT OF THE STATE ARCHITECT, IS EXEMPT FROM DISABLED ACCESS REQUIREMENTS.

(760) 434-8474

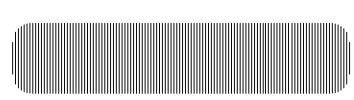

PREPARED FOR



P.O. BOX 19707 IRVINE, CA 92623-9707 (949) 222-7000

APPROVALS

DATE

DATE

DATE DATE

DATE EE/IN

DATE

PROJECT NAME

BALBOA PARK **ACTIVITY CENTER** (NAVAL HOSPITAL)

2117 PARK BOULEVARD SAN DIEGO, CA 92101 SAN DIEGO COUNTY


DRAWING DATES

100% ZD (se)

1A-CERT. 100% ZD (rd) 06/27/11 PLANNING REV. 100% ZD (rd) PLANNING REV. 100% ZD (rd) 10/28/11 PLANNING REV. 100% ZD (ral)

SHEET TITLE

TITLE SHEET PROJECT DATA

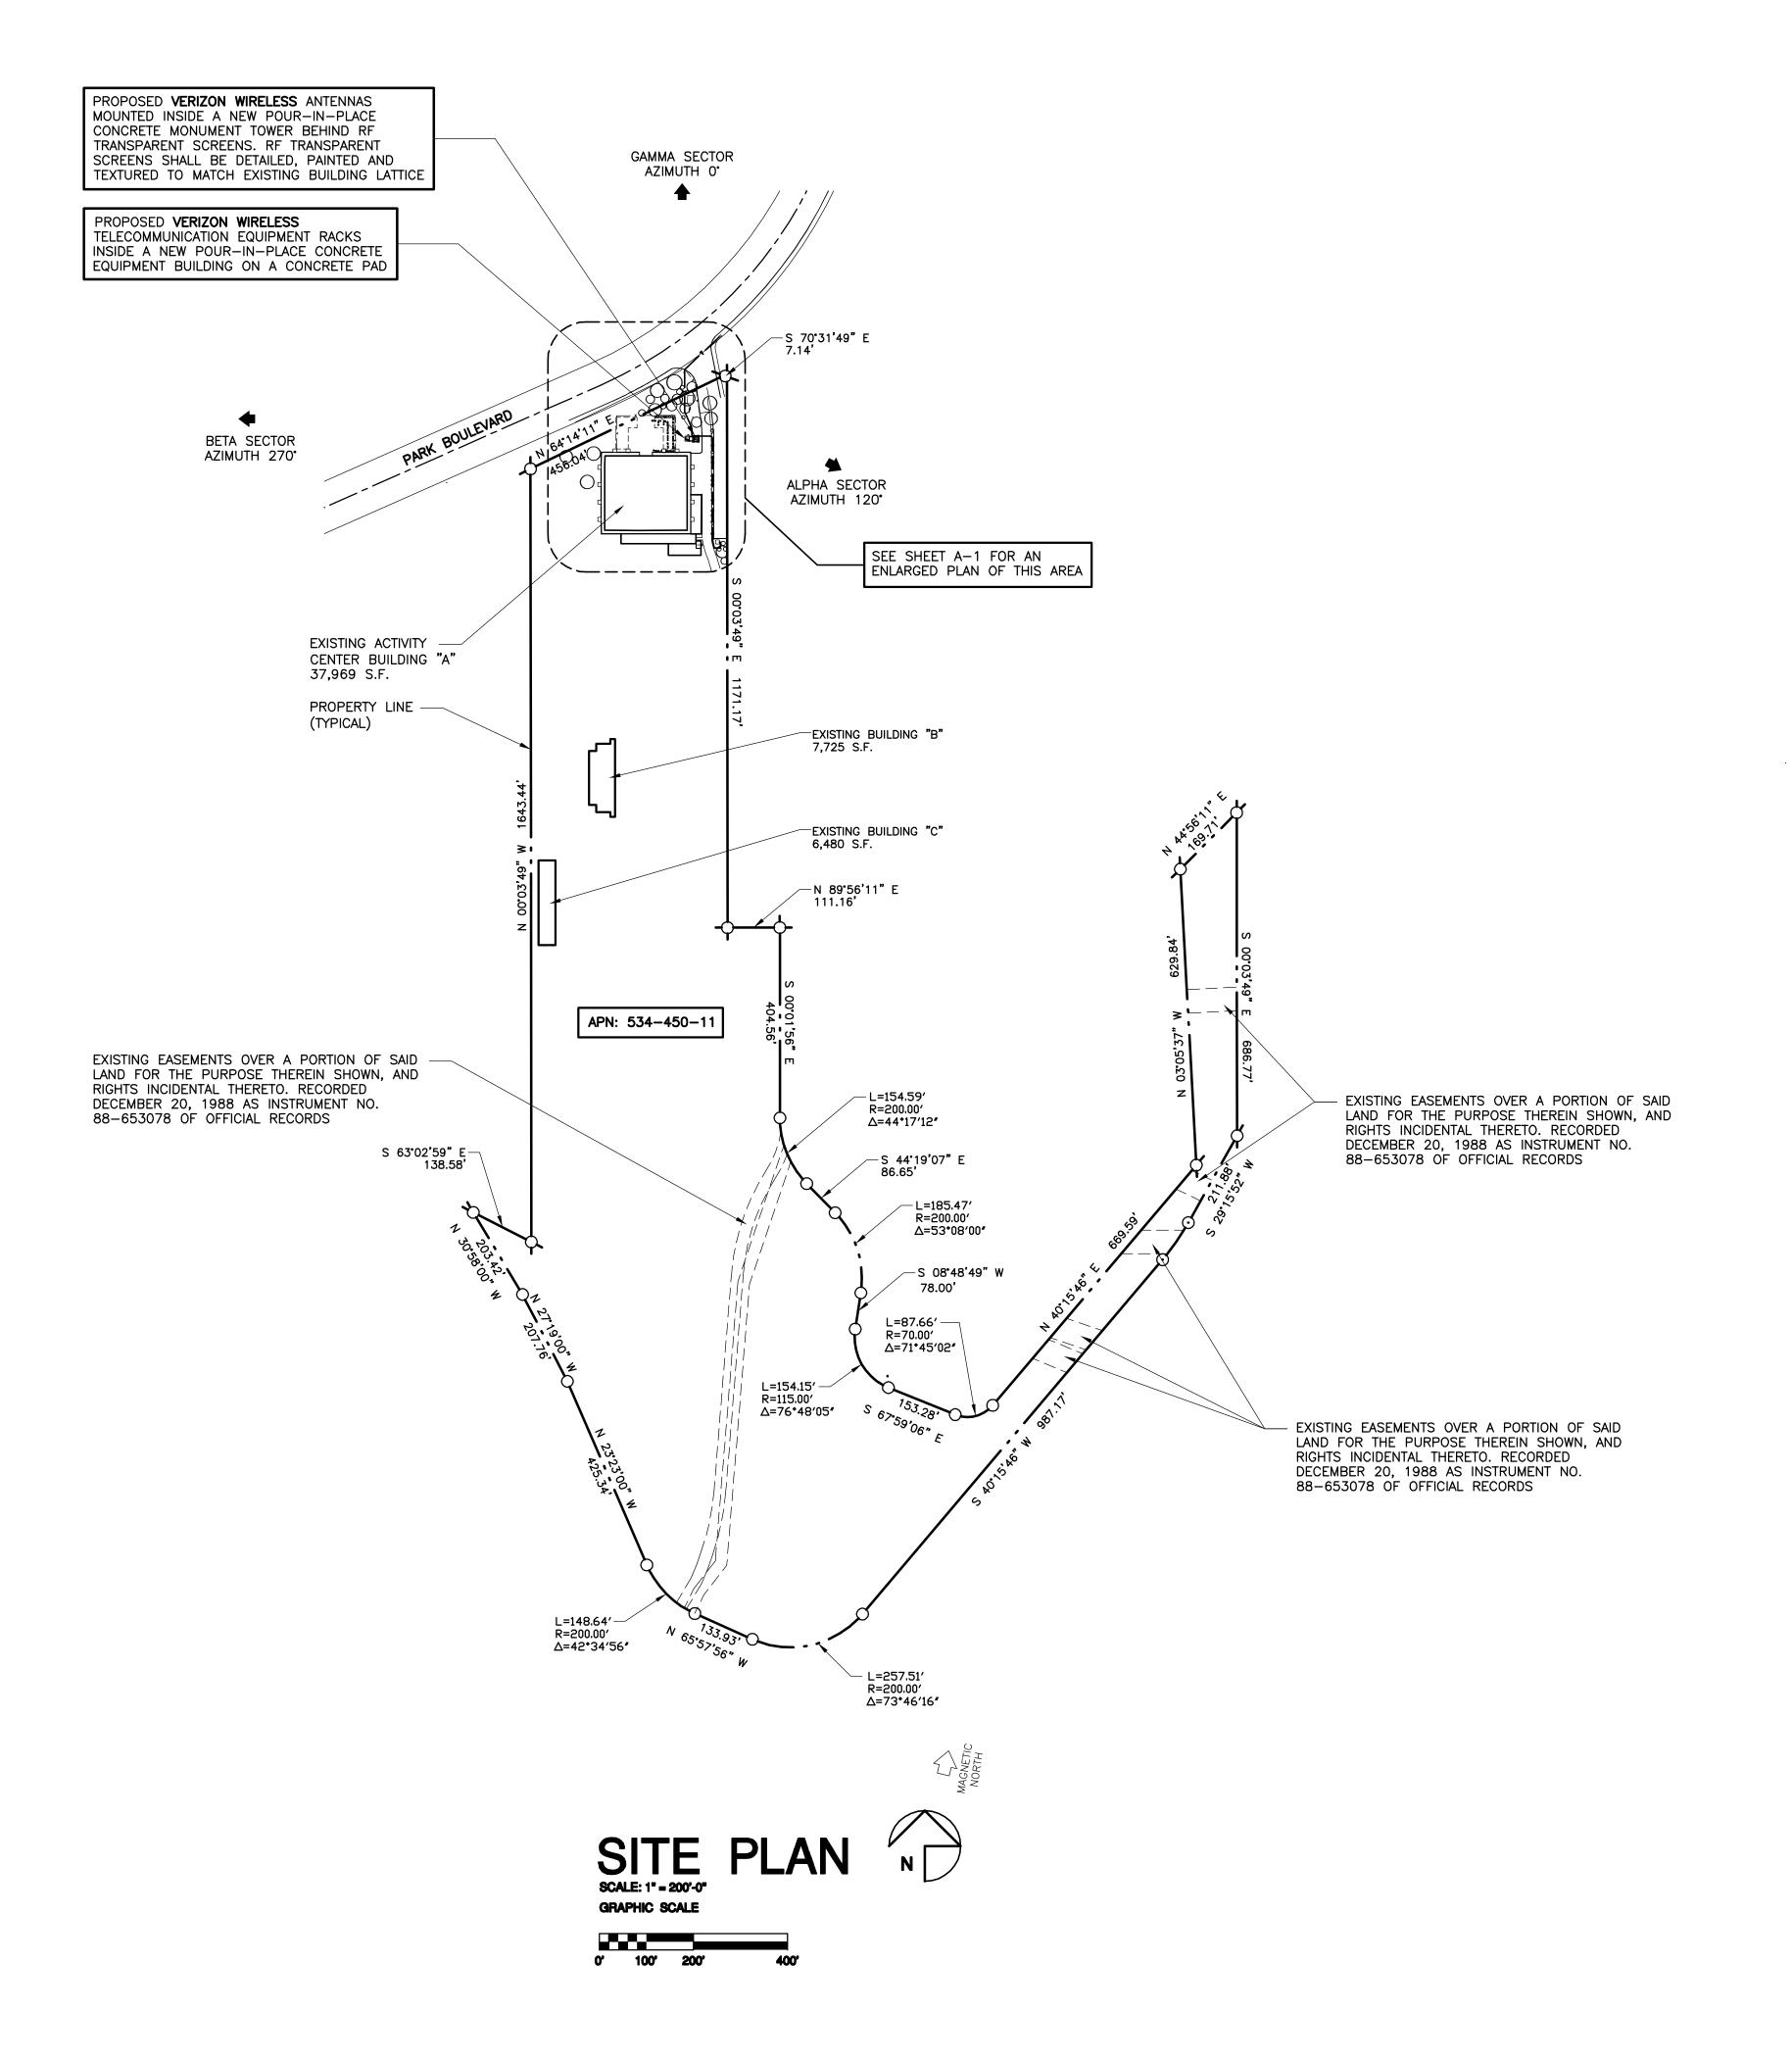

Lessee's Certificate Standard Wireless Facility Project for Post-construction BMP's

1/ we the undersigned, as lessee of a portion of the property described as

(Address or legal description)

understand that, in accordance with the San Diego Municipal Code, Land Development Manual - Storm Water Standards, this project is required to "Identify Pollutants from the Project Area" and incorporate "Site Design" and "Source Control" BMPs.

I certify to the best of my knowledge, that the pollutants anticipated by the proposed land use are as follows:

Sediments Nutrients Trash & debris Oxygen Demanding Substance Oil & Grease Becteria & Viruses

I/We will incorporate the following into the site design:

Maintain pre-development runoff characteristics Minimize impervious foot print by constructing walkways, paties and driveways with permeable surfaces.

Conserve natural areas Use natural drainage systems as opposed to lined swales or underground drainage

systems

Drain roof tops, walkways, patios and driveways into adjacent landscaping prior to discharging to the public drainage system.

Preserve existing native trees and shrubs

Protect all slopes from crosion

Additionally, I/we will: Minimize the use of posticides

Use efficient irrigation systems and landscape design, incorporating rain shutoff devices and flow reducers as needed.

I/we will maintain the above Standard Permanent BMP's for the duration of the lease.

1. PRIOR TO THE ISSUANCE OF ANY CONSTRUCTION PERMIT, THE OWNER/PERMITTEE SHALL ENTER INTO A MAINTENANCE AGREEMENT FOR THE ONGOING PERMANENT BMP MAINTENANCE.

- 2. PRIOR TO THE ISSUANCE OF ANY CONSTRUCTION PERMIT, THE OWNER/PERMITTEE SHALL INCORPORATE ANY CONSTRUCTION BEST MANAGEMENT PRACTICES NECESSARY TO COMPLY WITH CHAPTER 14, ARTICLE 2, DIVISION 1 (GRADING REGULATIONS) OF THE SAN DIEGO MUNICIPAL CODE, INTO THE CONSTRUCTION PLANS OR SPECIFICATIONS.
- 3. PRIOR TO THE ISSUANCE OF ANY CONSTRUCTION PERMIT, THE OWNER/PERMITTEE SHALL SUBMIT A WATER POLLUTION CONTROL PLAN (WPCP). THE WPCP SHALL BE PREPARED IN ACCORDANCE WITH THE GUIDELINES IN APPENDIX E OF THE CITY'S STORM WATER STANDARDS.

VERIZON WIRELESS TELECOMMUNICATIONS TRANSMITTER FREQUENCIES AND POWER LEVELS:

CDMA EQUIPMENT:

TX FREQUENCY: 1965-1970 MHz RX FREQUENCY: 1885-1890 MHz TX POWER: 600W

PCS EQUIPMENT:

TX FREQUENCY: 880-894 MHz RX FREQUENCY: 835-848 MHz TX POWER: 6150W

EASEMENTS:

EASEMENTS SHOWN REFLECT PRELIMINARY RECORDS RESEARCH OF RECORDED PARCEL MAPS & PRELIMINARY TITLE REPORT. EASEMENTS ARE SUBJECT TO REVIEW OF FINAL TITLE REPORT. SEE SHEET LS-1 FOR ADDITIONAL INFORMATION ON EASEMENTS

BOUNDARY NOTE:

THE PROPERTY BOUNDARY LINES SHOWN ON THIS DRAWING ARE FOR REFERENCE ONLY. A TITLE REPORT WAS NOT PROVIDED AND A BOUNDARY SURVEY WAS NOT PERFORMED

*A*RCHITECTURE 325 CARLSBAD VILLAGE DRIVE.



PREPARED FOR



P.O. BOX 19707 IRVINE, CA 92623-9707 (949) 222-7000

APPROVALS

DATE DATE

DATE

DATE

DATE EE/IN

> DATE OPS

EE/OUT DATE

PROJECT NAME

BALBOA PARK **ACTIVITY CENTER** (NAVAL HOSPITAL)

2117 PARK BOULEVARD SAN DIEGO, CA 92101 SAN DIEGO COUNTY

DRAWING DATES

100% ZD (se) 1A-CERT. 100% ZD (rd) 06/20/11 06/27/11 PLANNING REV. 100% ZD (rd) 08/17/11 PLANNING REV. 100% ZD (rd) PLANNING REV. 100% ZD (rai) 10/28/11

SHEET TITLE

SITE PLAN

A. Site Management Requirements

Construction is a dynamic operation where changes are expected. Storm water BMPs for construction sites are usually temporary measures that require frequent maintenance to maintain their effectiveness and may require relocation, revision and reinstallation, particularly as project grading progresses. Therefore, owner/contractor self-inspections are required. They shall be performed by the owner's/contractor's Qualified Contact Person specifically trained in storm water pollution prevention site management and storm water BMPs, including the installation and maintenance of sediment and erosion control measures. Additional qualified persons may assist with the inspection activities under the direction of the Qualified Contact Person. A Qualified Contact Person is required for all sites during both wet and dry weather conditions.

There are four primary purposes of the self-inspections conducted by owners and

- To ensure that the owners/contractors take full responsibility for managing storm water pollution caused by their activities.
- water pollution caused by their activities.
 To ensure that storm water BMPs are properly documented and implemented and are functioning effectively.
- To identify maintenance (e.g., sediment removal) and repair needs.
- To ensure that the project proponents implement their storm water management plans.

A self-inspection checklist, noting date, time, conditions and inspection date, must be kept on-site and made available for inspection, if requested (note: the State General Construction Permit has additional inspection requirements that must be met to comply with the permit). Self-inspections must be performed by a Qualified Contact Person according to the following schedule:

- Daily forecasting at all times
- At 24-hour intervals during extended rainfall events
- Daily evaluations as earth moving/grading is being conducted during the wet season
 Weekly (every 7 days) in the dry season as earth moving/grading is progressing

Storm water pollution prevention site management requirements include:

- A qualified person who is trained and competent in the use of BMPs shall be on site
 daily, although not necessarily full time, to evaluate the conditions of the site with
 respect to storm water pollution prevention. This qualified contact person shall
 represent the contractor/ owner on storm water issues.
- The qualified person shall implement the conditions of the Storm Water Pollution Prevention Plan, contract documents and/or local ordinances with respect to erosion
- and sediment control and other waste management regulations.
 The qualified person is responsible for monitoring the weather and implementation of any emergency plans as needed. The weather shall be monitored on a 5-day

forecast plan and a full BMP protection plan shall be activated when there is a 40%

or greater chance of rain.
The qualified person is responsible for overseeing any site grading and operations and evaluating the effectiveness of the BMPs. This person shall modify the BMPs as necessary to keep the dynamics of the site in compliance. This person or other qualified persons are responsible for checking the BMPs routinely for maintenance and documenting the BMPs being implemented.

STORM WATER QUALITY NOTES CONSTRUCTION BMPS

NOTES 1-7 BELOW REPRESENT KEY MINIMUM REQUIREMENTS FOR CONSTRUCTION BMPS.

- THIS PROJECT SHALL COMPLY WITH ALL REQUIREMENTS OF THE STATE PERMIT; CALIFORNIA REGIONAL WATER QUALITY CONTROL BOARD AND THE CITY OF SAN DIEGO LAND DEVELOPMENT CODE.
- 2. SUFFICIENT BMPS MUST BE INSTALLED TO PREVENT SILT, MUD OR OTHER CONSTRUCTION DEBRIS FROM BEING TRACKED INTO THE ADJACENT STREET(S) OR STORM WATER CONVEYANCE SYSTEMS DUE TO CONSTRUCTION VEHICLES OR ANY OTHER CONSTRUCTION ACTIVITY. THE CONTRACTOR SHALL BE RESPONSIBLE FOR CLEARING ANY SUCH DEBRIS THAT MAY BE IN THE STREET AT THE END OF EACH WORK DAY OR AFTER A STORM EVENT THAT CAUSES A BREECH IN THE INSTALLED CONSTRUCTION BMPS.
- 3. ALL STOCK PILES OF UNCOMPACTED SOIL AND/OR
 BUILDING MATERIALS THAT ARE INTENDED TO BE LEFT
 UNPROTECTED FOR A PERIOD GREATER THAN SEVEN
 CALENDAR DAYS ARE TO BE PROVIDED WITH EROSION AND
 SEDIMENT CONTROLS. SUCH SOIL MUST BE PROTECTED
 EACH DAY WHEN THE PROBABILITY OF RAIN IS 40% OR
- 4. A CONCRETE WASHOUT SHALL BE PROVIDED ON ALL PROJECTS WHICH PROPOSE THE CONSTRUCTION OF ANY CONCRETE.
- 5. ALL EROSION/SEDIMENT CONTROL DEVICES SHALL BE MAINTAINED IN WORKING ORDER AT ALL TIMES.
- 6. ALL SLOPES THAT ARE CREATED OR DISTURBED BY CONSTRUCTION ACTIVITY MUST BE PROTECTED AGAINST EROSION AND SEDIMENT TRANSPORT AT ALL TIMES.
- 7. THE STORAGE OF ALL CONSTRUCTION MATERIALS AND EQUIPMENT MUST BE PROTECTED AGAINST ANY POTENTIAL RELEASE OF POLLUTANTS INTO THE ENVIRONMENT.

PRIORITY: LOW

IDENTIFY POLLUTANTS FROM THE PROJECT AREA

COMMERCIAL DEVELOPMENT: SEDIMENT — POTENTIAL NUTRIENTS — POTENTIAL

NUTRIENTS - POTENTIAL

ORGANIC COMPOUNDS - N/A

TRASH & DEBRIS - ANTICIPATED

OXYGEN DEMANDING SUBSTANCES - ANTICIPATED

BACTERIA & VIRUSES - N/A

PESTICIDES - POTENTIAL

STANDARD LID BMPs:

1 MINIMIZE IMPERVIOUS FOOTPRINT

2 MINIMIZE SOIL COMPACTION IN LANDSCAPE AREA

3 SOIL AMENDMENT

SOURCE CONTROL BMPs:

A USE EFFICIENT IRRIGATION SYSTEM

CONSTRUCTION STORMWATER BMPs:

DIRECTION OF LOT DRAINAGE \longrightarrow

SS-7 EROSION CONTROL BLANKET

SS-6 MULCH, STRAW, WOOD CHIPS

SC-5 FIBER ROLLS —FR—FR—


TC-1 STABILIZED CONSTRUCTION ENTRANCE

WM-1 MATERIAL DELIVERY & STORAGE
WM-8 CONCRETE WASTE MANAGEMENT


WM-5 SOLID WASTE MANAGEMENT


WM-9 SANITARY WASTE MANAGEMENT

WM-6 HAZARDOUS WASTE MANAGEMENT

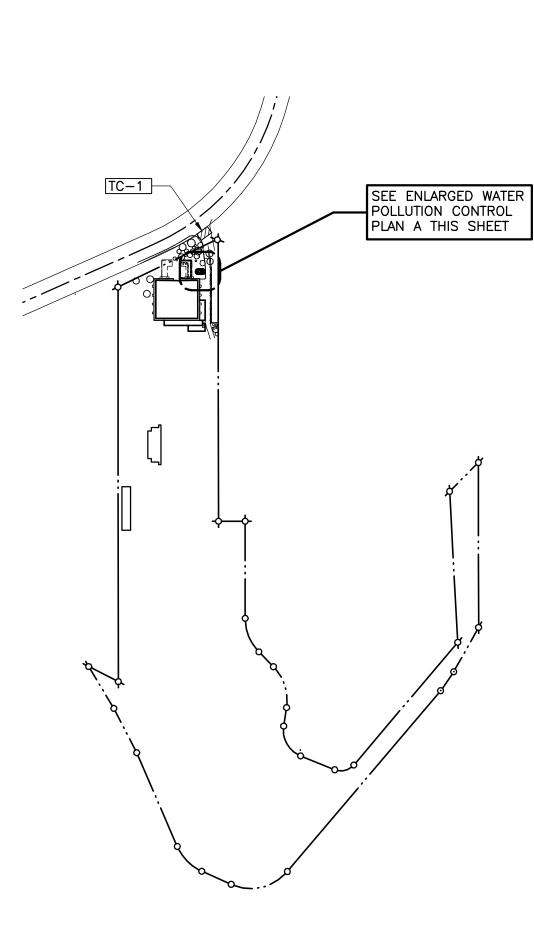

WATER POLLUTION NORTH NO

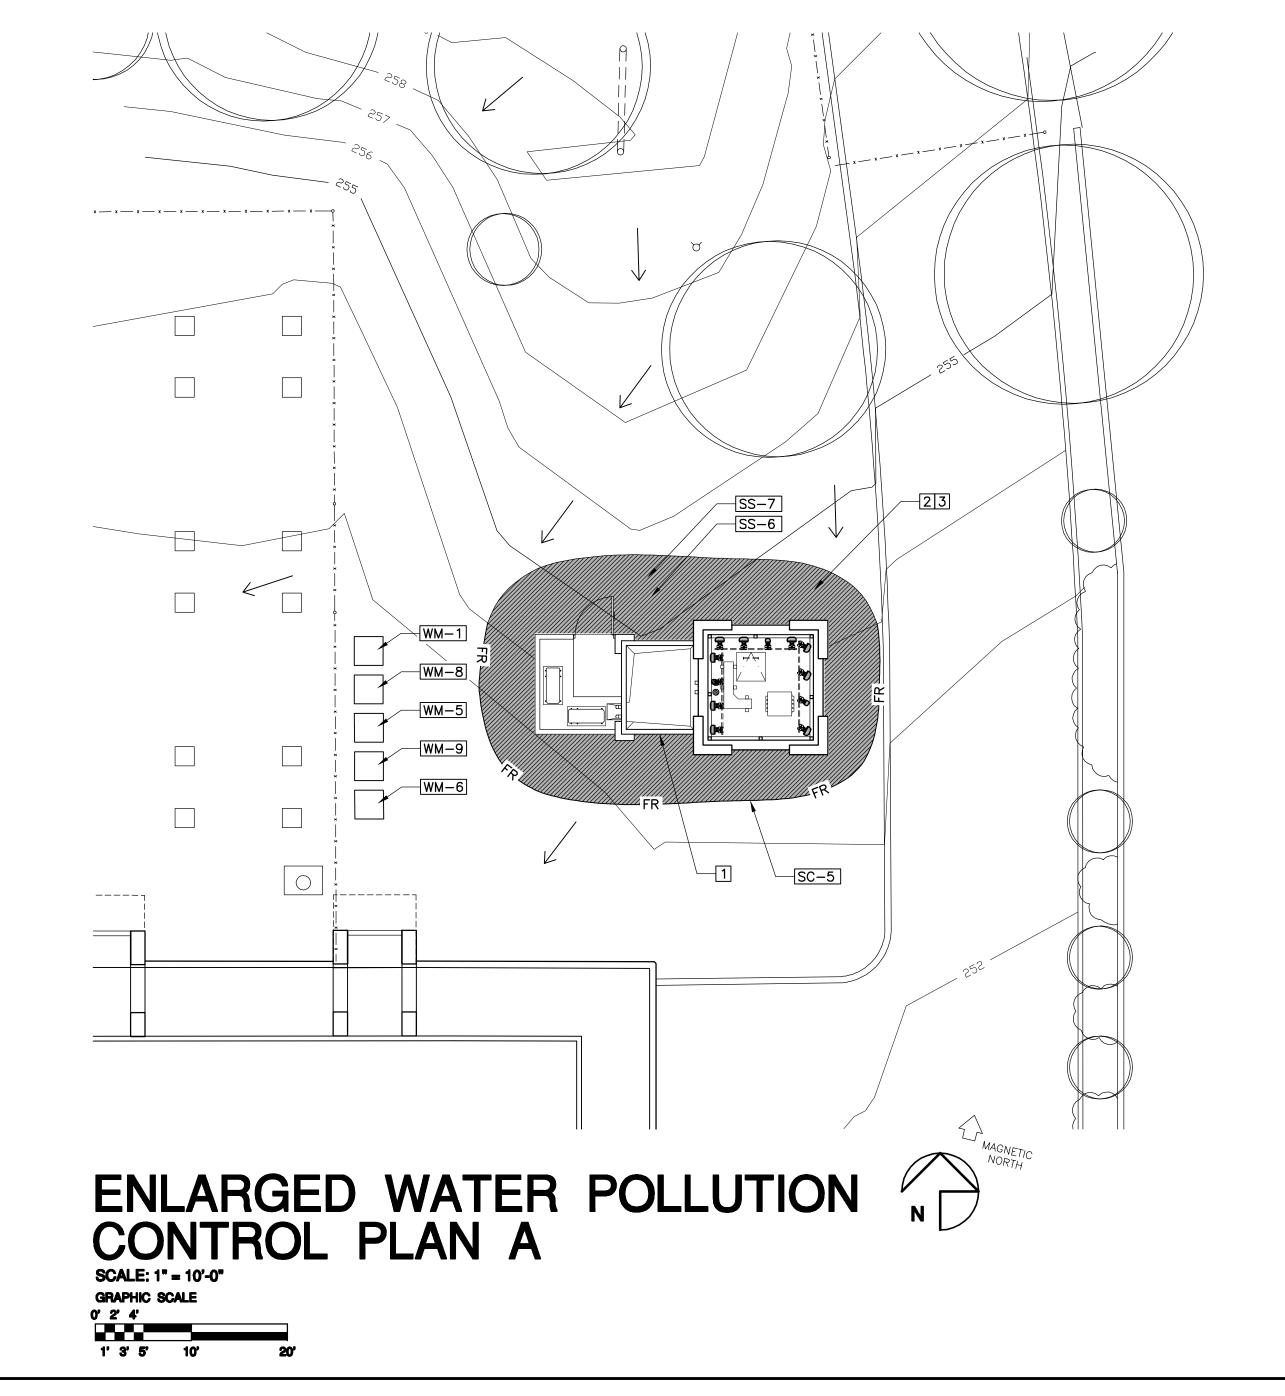


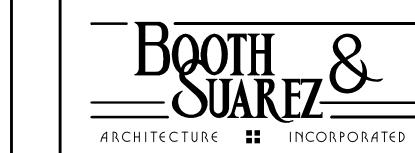

ARCHITECTURE INCORPORATED

325 CARLSBAD VILLAGE DRIVE. SUITE D2

CARLSBAD, CA 92008 (760) 434-8474

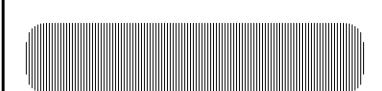

PREPARED FOR



P.O. BOX 19707 IRVINE, CA 92623-9707 (949) 222-7000

APPROVALS

A&C DATE

RE DATE

RF DATE

INT DATE

EE/IN

EE/OUT

DATE

DATE

OPS DATE

PROJECT NAME

BALBOA PARK ACTIVITY CENTER (NAVAL HOSPITAL)

2117 PARK BOULEVARD SAN DIEGO, CA 92101 SAN DIEGO COUNTY

____ !! ___

DRAWING DATES

15/11 100% ZD (se)
20/11 1A-CERT. 100% ZD (rd)
27/11 PLANNING REV. 100% ZD (rd)
17/11 PLANNING REV. 100% ZD (rd)
28/11 PLANNING REV. 100% ZD (ral)

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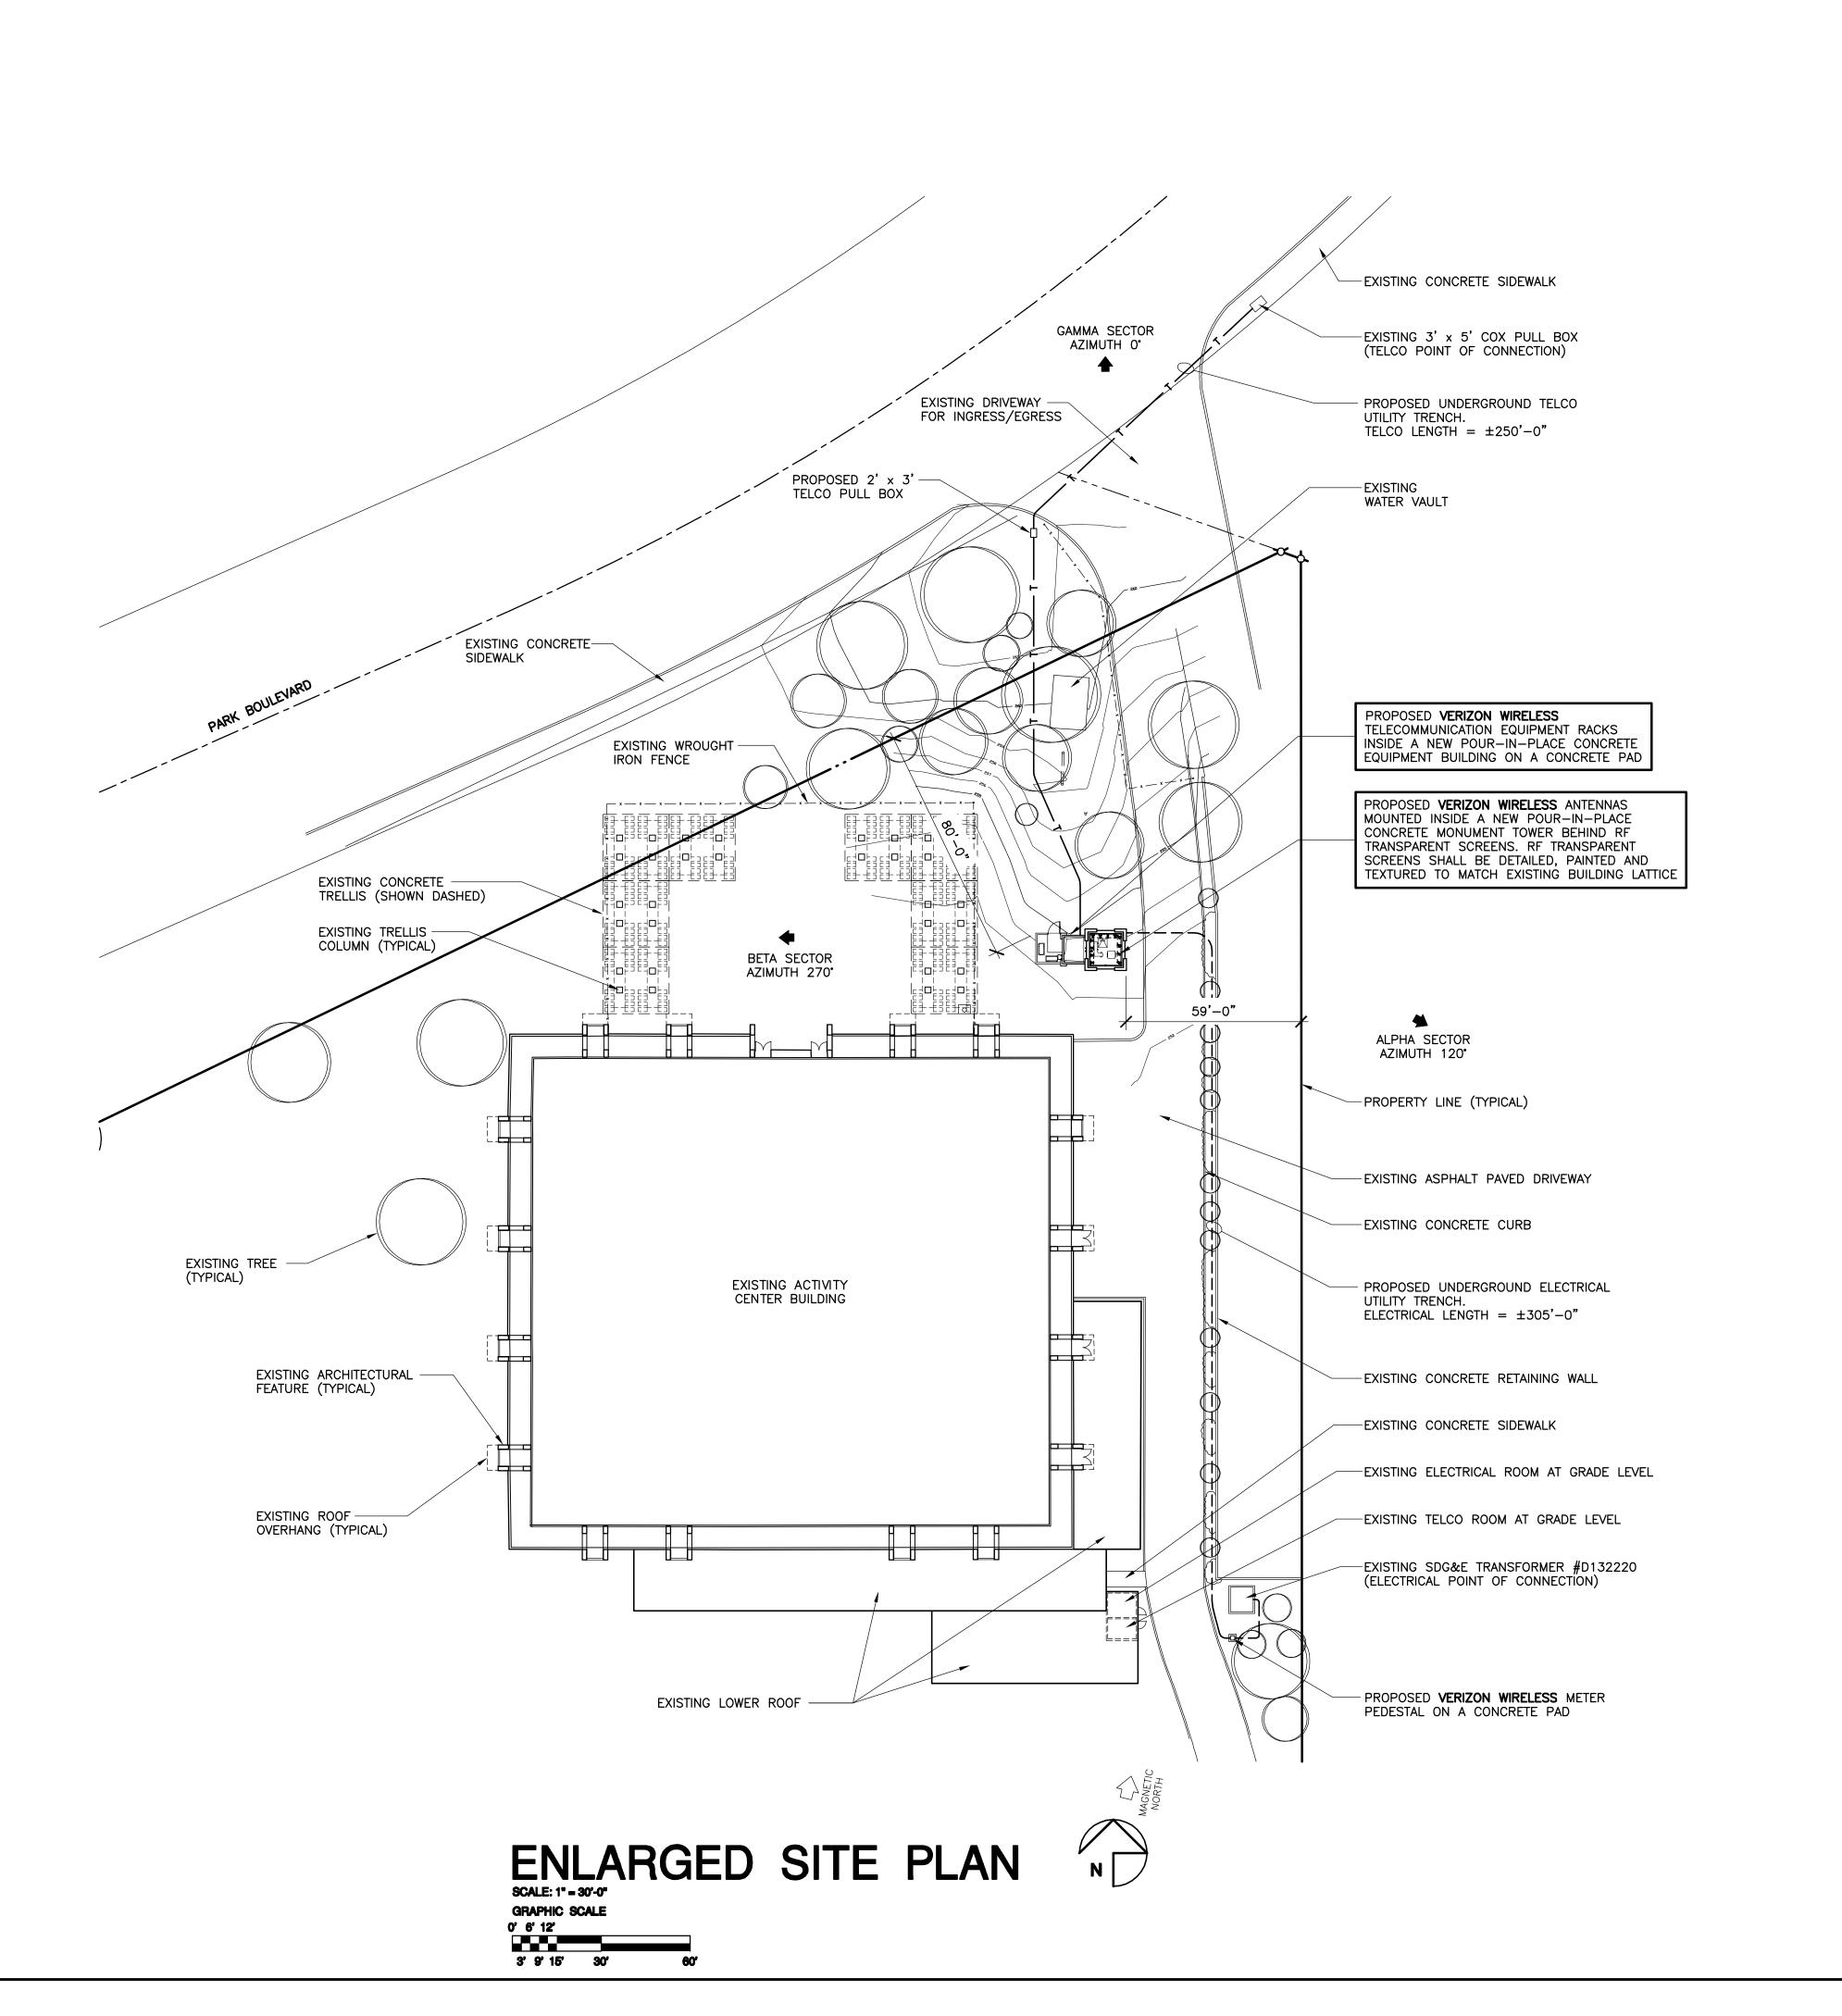
WATER POLLUTION CONTROL PLANS

SHEET TITLE

PROJECTS\Verizon\11054zd

__

A-0.1



VOLUME OF CUT/FILL:

VOLUME OF CUT = 20 CUYD.

MAX CUT SLOPE RATIO: 0

MAX HEIGHT: 0 FT.

VOLUME OF FILL = 0 CUYD.

MAX FILL SLOPE RATIO: 0


MAX HEIGHT: 0 FT.

BOTH 8

ARCHITECTURE INCORPORATED

325 CARLSBAD VILLAGE DRIVE, SUITE D2

CARLSBAD, CA 92008 (760) 434-8474

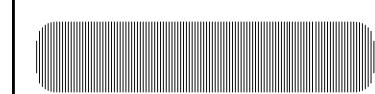

= :: =

PREPARED FOR



P.O. BOX 19707 IRVINE, CA 92623-9707 (949) 222-7000

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DATE

EE/IN DATE

OPS DATE

EE/OUT

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2117 PARK BOULEVARD SAN DIEGO, CA 92101 SAN DIEGO COUNTY

DRAWING DATES


04/15/11 100% ZD (se)
06/20/11 1A-CERT. 100% ZD (rd)
06/27/11 PLANNING REV. 100% ZD (rd)
08/17/11 PLANNING REV. 100% ZD (rd)
10/28/11 PLANNING REV. 100% ZD (ral)

SHEET TITLE

ENLARGED SITE PLAN

PROJECTS\Verizon\11054zd

A-1

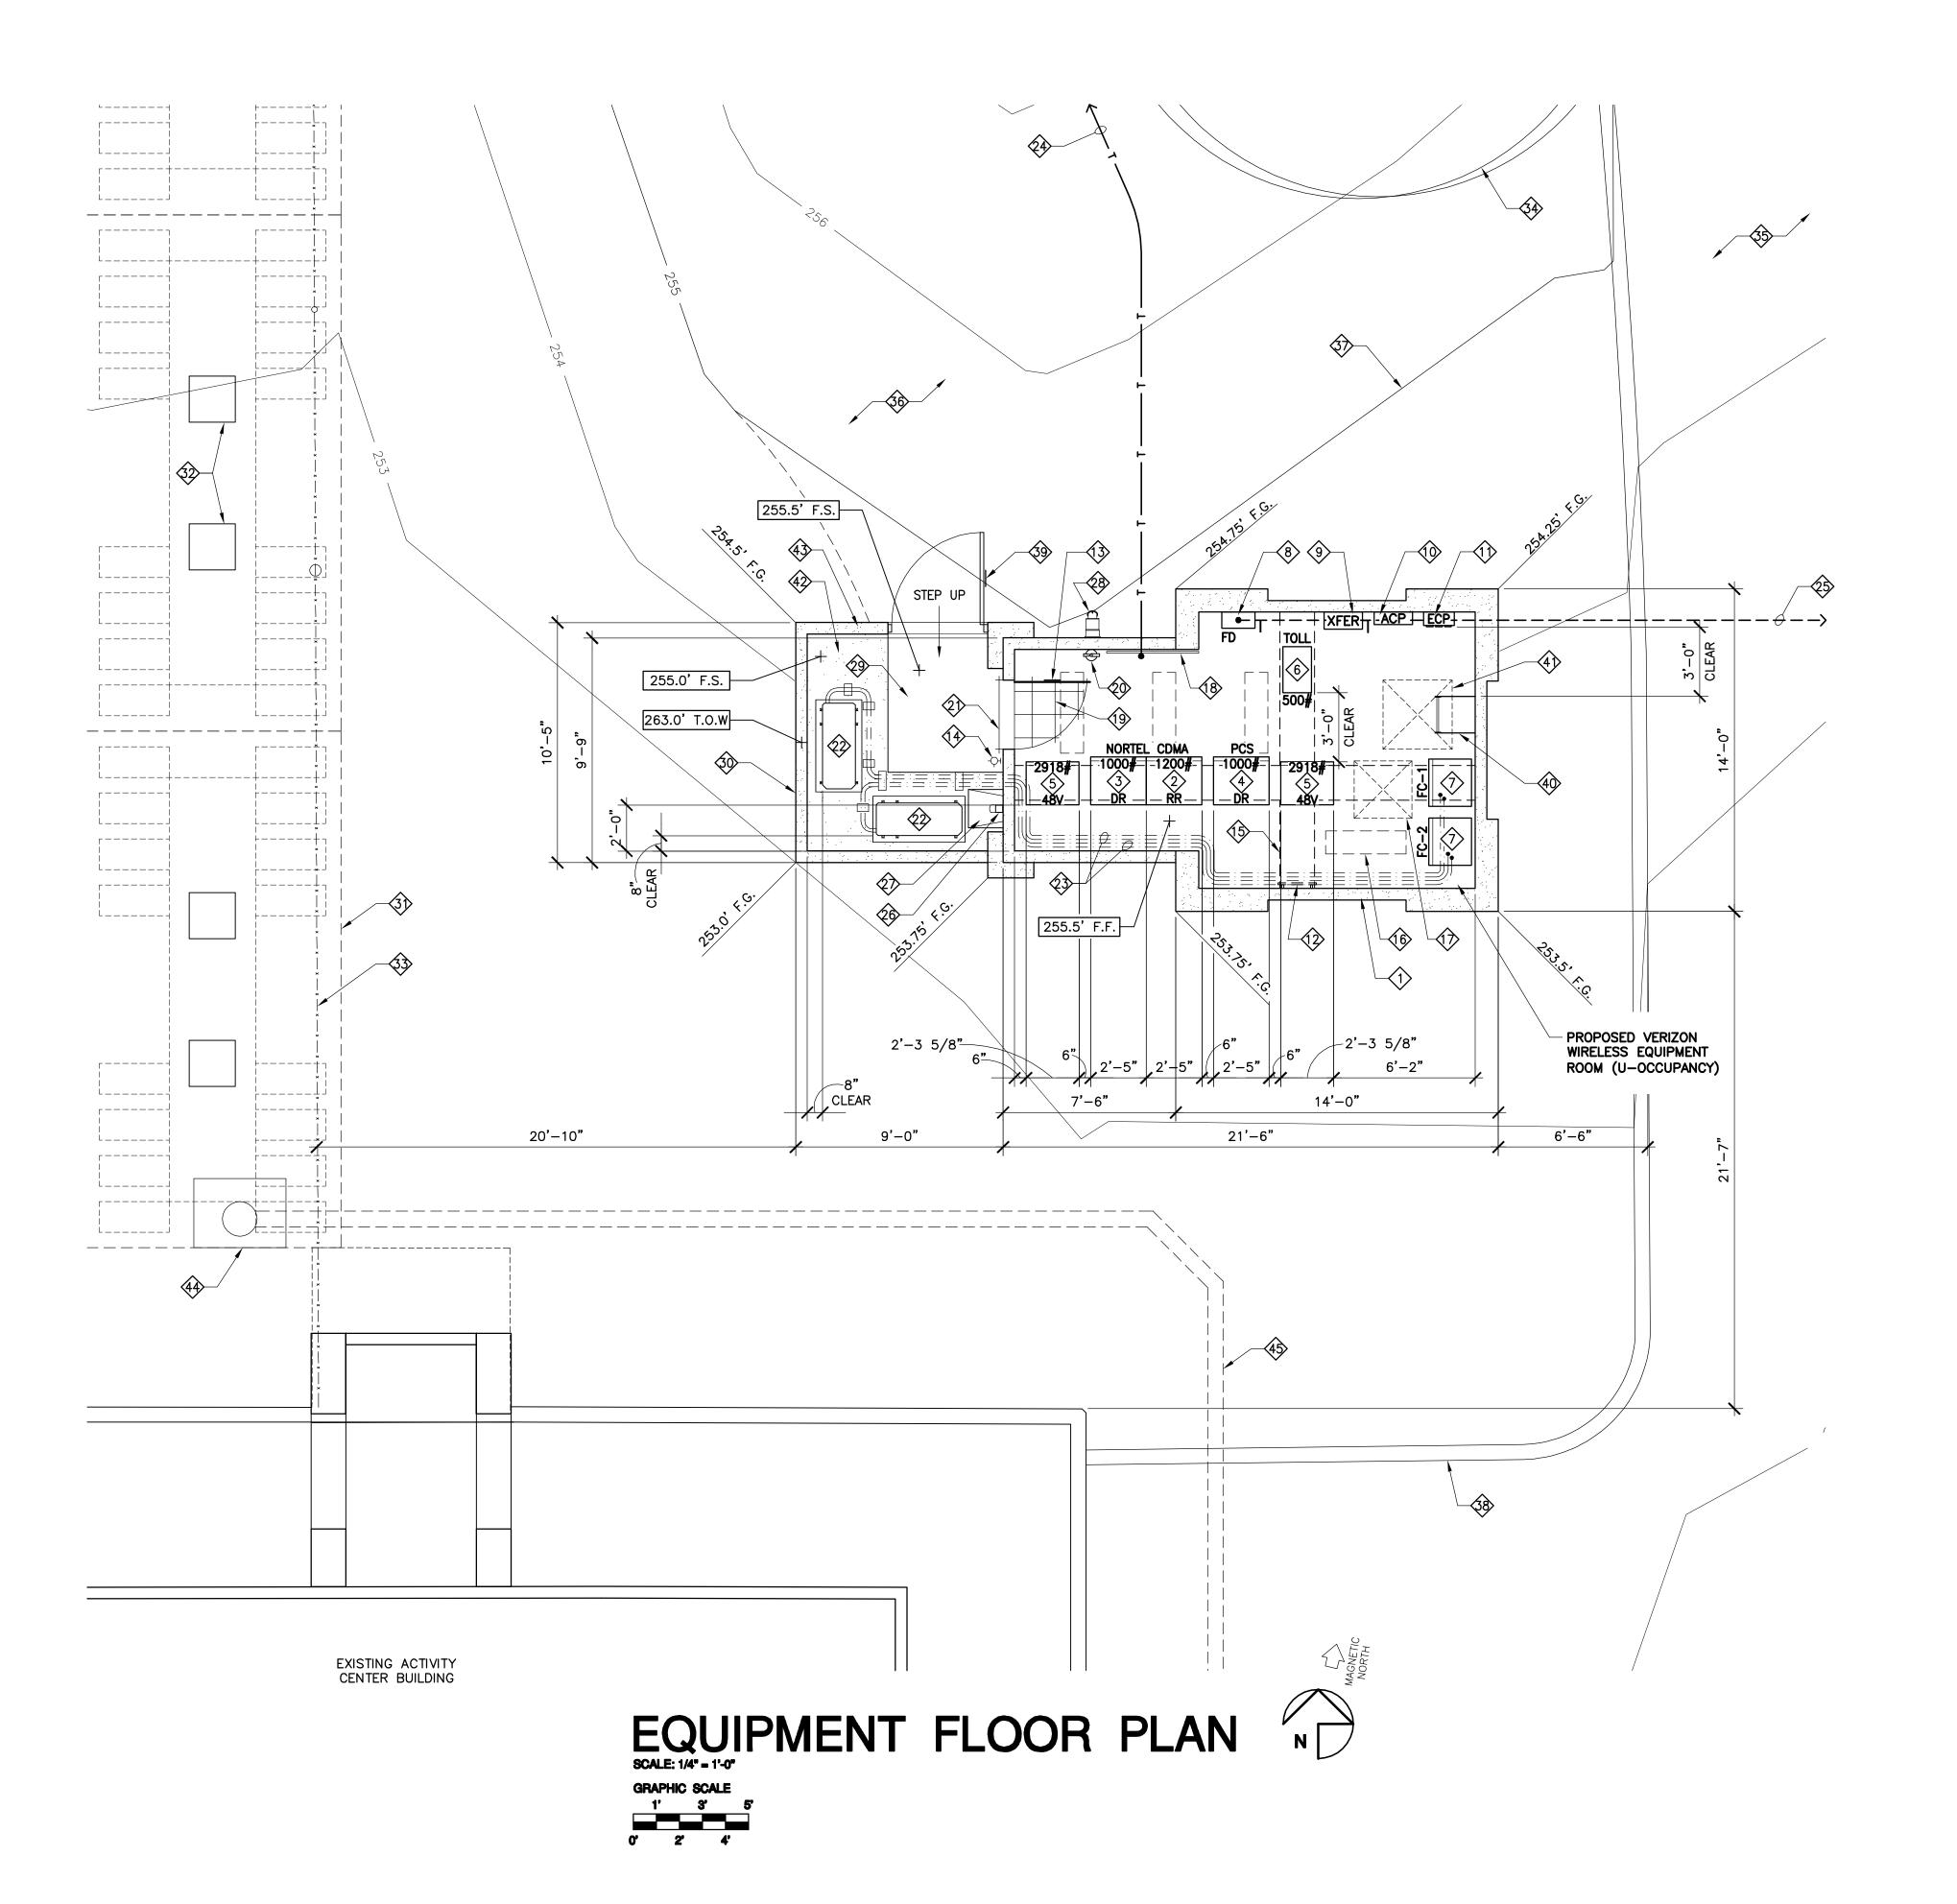


EQUIPMENT FLOOR PLAN NOTES:

- PROPOSED VERIZON WIRELESS TELECOMMUNICATIONS EQUIPMENT INSIDE A NEW POUR-IN-PLACE CONCRETE EQUIPMENT BUILDING ON A CONCRETE PAD
- PROPOSED **VERIZON WIRELESS** NORTEL CDMA EQUIPMENT RADIO RACK **(RR)** 29" WIDE x 84" HIGH x 25" DEEP. WEIGHT: 1200 LBS.
- PROPOSED **VERIZON WIRELESS** NORTEL CDMA EQUIPMENT RACK **(DR)** 29" WIDE x 84" HIGH x 25" DEEP. WEIGHT: 1000 LBS.
- PROPOSED **VERIZON WIRELESS** PCS EQUIPMENT RACK **(DR)** 29" WIDE x 84" HIGH x 25" DEEP. WEIGHT: 1000 LBS.
- PROPOSED **VERIZON WIRELESS** BATTERY RACK. 27-5/8" WIDE x 57" HIGH x 22-1/2" DEEP. WEIGHT: 2918 LBS.
- PROPOSED **VERIZON WIRELESS** TOLL RACK. 24" WIDE x 57" HIGH x 15" DEEP. WEIGHT: 500 LBS.
- 7> PROPOSED AIR HANDLERS
- PROPOSED FUSED DISCONNECT SWITCH MOUNTED TO WALL
- PROPOSED MANUAL TRANSFER SWITCH MOUNTED TO WALL
- PROPOSED 200 AMP ELECTRICAL PANEL MOUNTED TO WALL
- PROPOSED ENVIROMENTAL CONTROL PANEL MOUNTED TO WALL
- PROPOSED MAIN GROUND BUS BAR TO BE MOUNTED TO WALL
- PROPOSED 3'-0" WIDE STEEL DOOR AND FRAME & VERIZON WIRELESS SIGNAGE
- PROVIDE WALL MOUNTED EXTERIOR LIGHT FIXTURE MOUNTED TO BUILDING
- PROPOSED OVERHEAD 18" CABLE LADDER @ +7'-6" (SHOWN DASHED)
- PROPOSED SURFACE MOUNTED FLORESCENT LIGHT FIXTURES (TYPICAL OF 4)
- PROPOSED COAX CABLE PENETRATION TO CABLE CHASE ABOVE (SHOWN DASHED)
- (18) PROPOSED WALL MOUNTED TELCO BOARD
- PROPOSED 12" x 12" x 1/8" VINYL FLOOR TILES. EXCELON #51973 MONO WHITE WITH 4" COVER BASE
- PROVIDE AND INSTALL (1) WALL MOUNTED CLASS "ABC" FIRE EXTINGUISHER
- PROPOSED ALUMINUM THRESHOLD
- PROPOSED MECHANICAL UNITS ON A CONCRETE PAD (TYPICAL OF 2) (SHOWN DASHED)
- 23 PROPOSED CONDENSATE DRAIN LINE ROUTING
- PROPOSED TELCO CONDUIT IN AN UNDERGROUND UTILITY TRENCH
- PROPOSED ELECTRICAL CONDUIT IN AN UNDERGROUND UTILITY TRENCH
- PROPOSED DOWNSPOUT
- PROPOSED SPLASH BLOCK
- PROPOSED VERIZON WIRELESS REVERSE GENERATOR RECEPTACLE FOR
- EMERGENCY GENERATOR CONNECTION MOUNTED TO WALL
- 29 PROPOSED CONCRETE LANDING
- PROPOSED CONCRETE MECHANICAL EQUIPMENT ENCLOSURE WALL
- (3) EXISTING CONCRETE TRELLIS (SHOWN DASHED)
- (32) EXISTING CONCRETE COLUMNS (TYPICAL)
- ⟨З⟩ EXISTING WROUGHT IRON FENCE
- (4) EXISTING TREE TO REMAIN (TYPICAL) \$\sqrt{3}\$ EXISTING ASPHALT PAVED DRIVEWAY
- (36) EXISTING LANDSCAPE AREA
- (37) EXISTING TOPO LINES AT 1'-0" INTERVALS
- ⟨38⟩ EXISTING CONCRETE CURB
- PROPOSED SOLID STEEL GATE & FRAME WITH VERIZON WIRELESS SIGNAGE
- 40 PROPOSED ACCESS LADDER TO ANTENNA ROOM ABOVE
- 4 PROPOSED TOWER ACCESS HATCH (SHOWN DASHED)
- 4 install 3" layer of 3/4" crushed gravel over fiber GROWTH BARRIER WITHIN ENTIRE EQUIPMENT COMPOUND
- 43 PROPOSED CONCRETE CURB
- 44 EXISTING STORM DRAIN
- 45 EXISTING STORM DRAIN ROUTE (SHOWN DASHED)

NOTE: PROPOSED LANDSCAPE SHRUBS NOT SHOWN FOR CLARITY. SEE LANDSCAPE DEVELOPMENT PLAN SHEET L-1



ARCHITECTURE ## INCORPORATED 325 CARLSBAD VILLAGE DRIVE, SUIT€ D2 CARLSBAD, CA 92008 (760) 434-8474

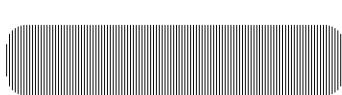

PREPARED FOR



P.O. BOX 19707 IRVINE, CA 92623-9707 (949) 222-7000

APPROVALS

DATE

DATE

DATE

DATE

DATE EE/IN

OPS DATE EE/OUT DATE

PROJECT NAME

BALBOA PARK **ACTIVITY CENTER** (NAVAL HOSPITAL)

2117 PARK BOULEVARD SAN DIEGO, CA 92101 SAN DIEGO COUNTY

DRAWING DATES

06/20/11

06/27/11

10/28/11


100% ZD (se) 1A-CERT. 100% ZD (rd) PLANNING REV. 100% ZD (rd)

PLANNING REV. 100% ZD (rd) PLANNING REV. 100% ZD (ral)

SHEET TITLE

EQUIPMENT FLOOR PLAN


			ANTENI	NA AND	COAX	IAL CABLE SCHEDULE				
SECTOR ANTENNA		AZIMUTH	ANTENNA MODEL NUMBER	DOWNTILT	SKEW ANGLE	SERIAL NUMBER	NUMBER OF CABLES PER SECTOR	COAX. CABLE LENGTH (+ / – 5')	JUMPER LENGTH (+ / - 3')	COAX SIZE
ALPHA1			AMPHENOL ANTEL: BXA-70063/4CF_5							
ALPHA2		[AMPHENOL ANTEL: BXA-80063/4CF_5	o	N/A		┐ ੵ	70'-0"	6'-0"	7/8"
ALPHA3	SOUTHEAST	T 120°	AMPHENOL ANTEL: BXA-171063/8CF_2				8			
ALPHA4]		AMPHENOL ANTEL: BXA-70063/4CF_5							
BETA1			AMPHENOL ANTEL: BXA-70063/4CF_5							
BETA2	WEST	070*	AMPHENOL ANTEL: BXA-80063/4CF_5] ,	NI /A			70' 0"	c' o"	7 /0"
BETA3	WEST	Γ 270°	AMPHENOL ANTEL: BXA-171063/8CF_2	-l I	N/A		8	70'-0"	6'-0"	7/8"
BETA4			AMPHENOL ANTEL: BXA-70063/4CF_5							
GAMMA1			AMPHENOL ANTEL: BXA-70063/4CF_5	0*	N/A			70'-0"	6'-0"	7/8"
GAMMA2	NORTH		AMPHENOL ANTEL: BXA-80063/4CF_5							
GAMMA3		0,	AMPHENOL ANTEL: BXA-171063/8CF_2				8			
GAMMA4			AMPHENOL ANTEL: BXA-70063/4CF_5				7			

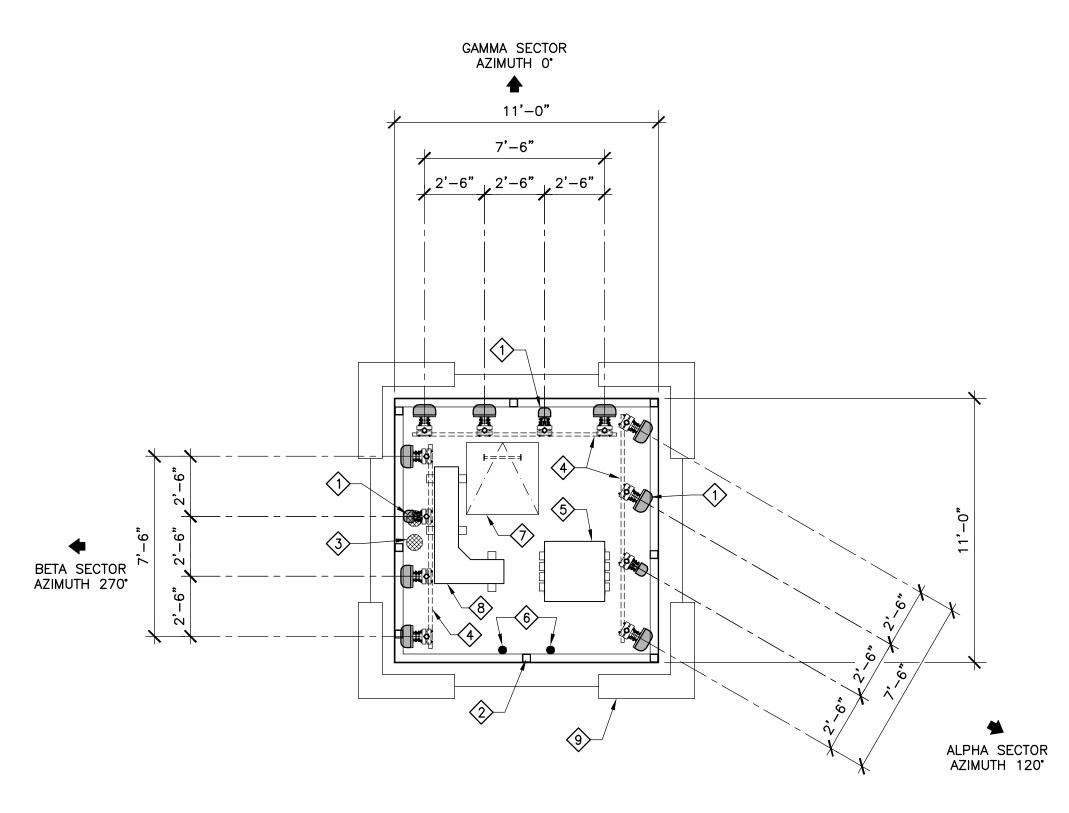



ANTENNA PLAN NOTES:

- PROPOSED **VERIZON WIRELESS** ANTENNAS MOUNTED INSIDE PROPOSED MONUMENT TOWER BEHIND RF TRANSPARENT SCREENS.
- 2 PROPOSED RF TRANSPARENT SCREEN & FRAMING
- 3 PROPOSED FLOOR DRAIN
- 4> PROPOSED UNISTRUT
- 5 PROPOSED COAX CABLE HATCH
- 6 PROPOSED (2) E/911 GPS ANTENNAS TO BE MOUNTED TO RF TRANSPARENT SCREEN FRAMING
- PROPOSED TOWER ACCESS HATCH
- 8 PROPOSED COAX CABLE TRAY ON PVC SLEEPERS
- 9 PROPOSED TOWER WALL BELOW

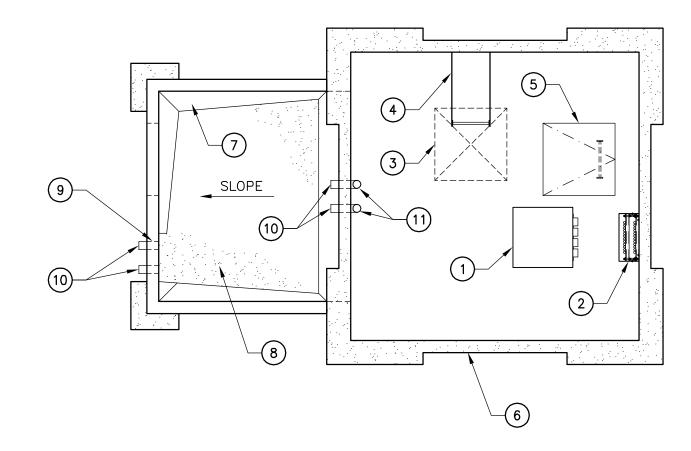


EQUIPMENT ROOF PLAN NO SCALE: 1/4" - 1'-0" GRAPHIC SCALE 1' 3' 5' 0' 2' 4'



ROOF PLAN NOTES:

- (1) PROPOSED COAX CABLE HATCH
- (2) PROPOSED COAX CABLE CHASE
- (3) PROPOSED TOWER ACCESS OPENING ABOVE (SHOWN DASHED)
- 4) PROPOSED ACCESS LADDER
- (5) PROPOSED TOWER ACCESS HATCH
- 6) PROPOSED TOWER WALL
- PROPOSED ROOF CRICKET
- (8) PROPOSED BUILT-UP ROOFING
- 9) PROPOSED SCUPPER
- (10) PROPOSED DOWNSPOUTS
- (11) PROPOSED DRAINS FROM ABOVE

ARCHITECTURE ## 325 CARLSBAD VILLAGE DRIVE. CARLSBAD, CA 92008 (760) 434-8474

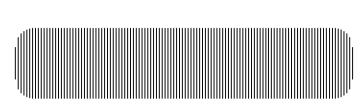

PREPARED FOR



P.O. BOX 19707 IRVINE, CA 92623-9707 (949) 222-7000

APPROVALS

DATE DATE

DATE

DATE

DATE

DATE

EE/IN

EE/OUT

DATE OPS

PROJECT NAME

BALBOA PARK **ACTIVITY CENTER** (NAVAL HOSPITAL)


2117 PARK BOULEVARD SAN DIEGO, CA 92101 SAN DIEGO COUNTY

DRAWING DATES

100% ZD (se)
1A-CERT. 100% ZD (rd)
PLANNING REV. 100% ZD (rd)
PLANNING REV. 100% ZD (rd)
PLANNING REV. 100% ZD (ral) 06/27/11 08/17/11 10/28/11

SHEET TITLE

EQUIPMENT ROOF PLAN ANTENNA PLAN

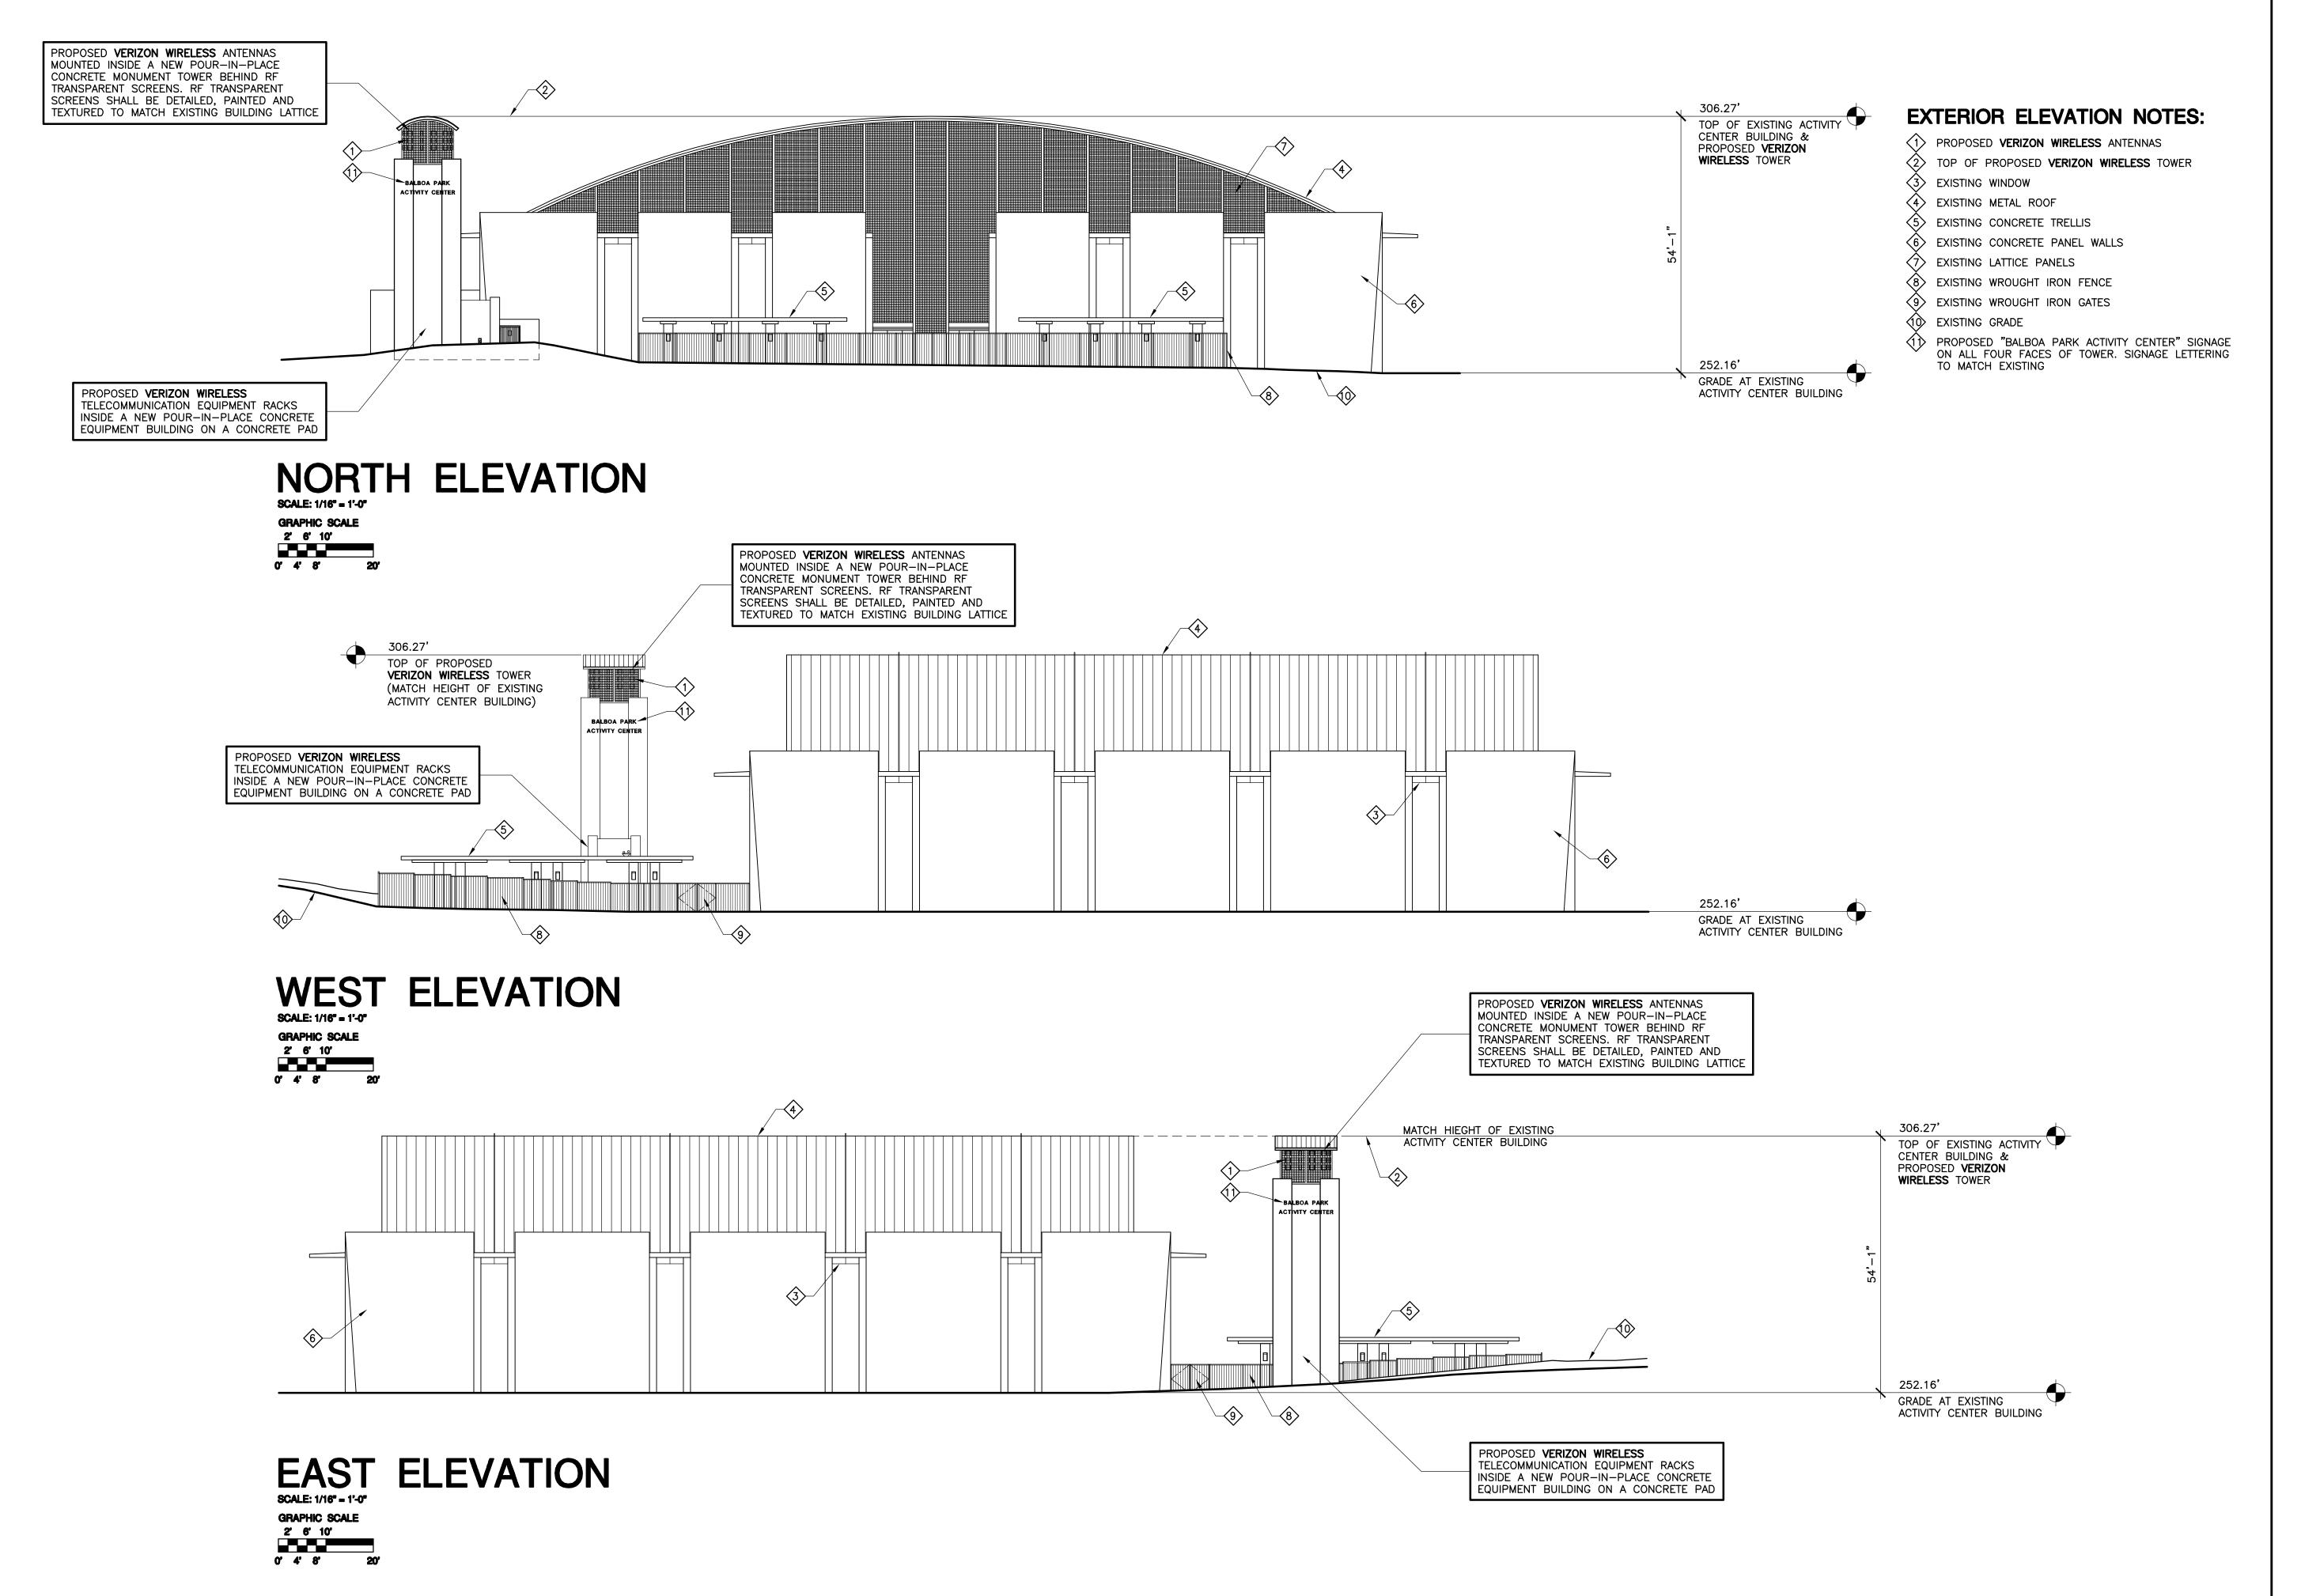




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CARLSBAD. CA 92008 (760) 434-8474



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APPROVALS
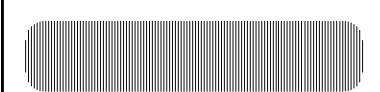
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PROJECT NAME

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BALBOA PARK ACTIVITY CENTER (NAVAL HOSPITAL)

2117 PARK BOULEVARD SAN DIEGO, CA 92101 SAN DIEGO COUNTY

_____ == ___

DRAWING DATES


04/15/11 100% ZD (se)
06/20/11 1A-CERT. 100% ZD (rd)
06/27/11 PLANNING REV. 100% ZD (rd)
08/17/11 PLANNING REV. 100% ZD (rd)
10/28/11 PLANNING REV. 100% ZD (ral)

SHEET TITLE


EXTERIOR ELEVATIONS

PROJECTS\Verizon\11054zd

Λ_1

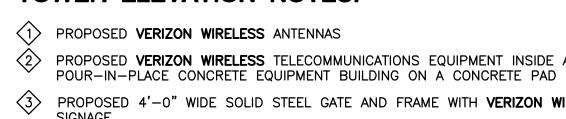

- 9 PROPOSED CONCRETE CURB
- EXISTING GRADE
- PROPOSED CONCRETE MECHANICAL EQUIPMENT ENCLOSURE WALL
- PROPOSED METAL ROOF
- FACES OF TOWER. SIGNAGE LETTERING TO MATCH EXISTING

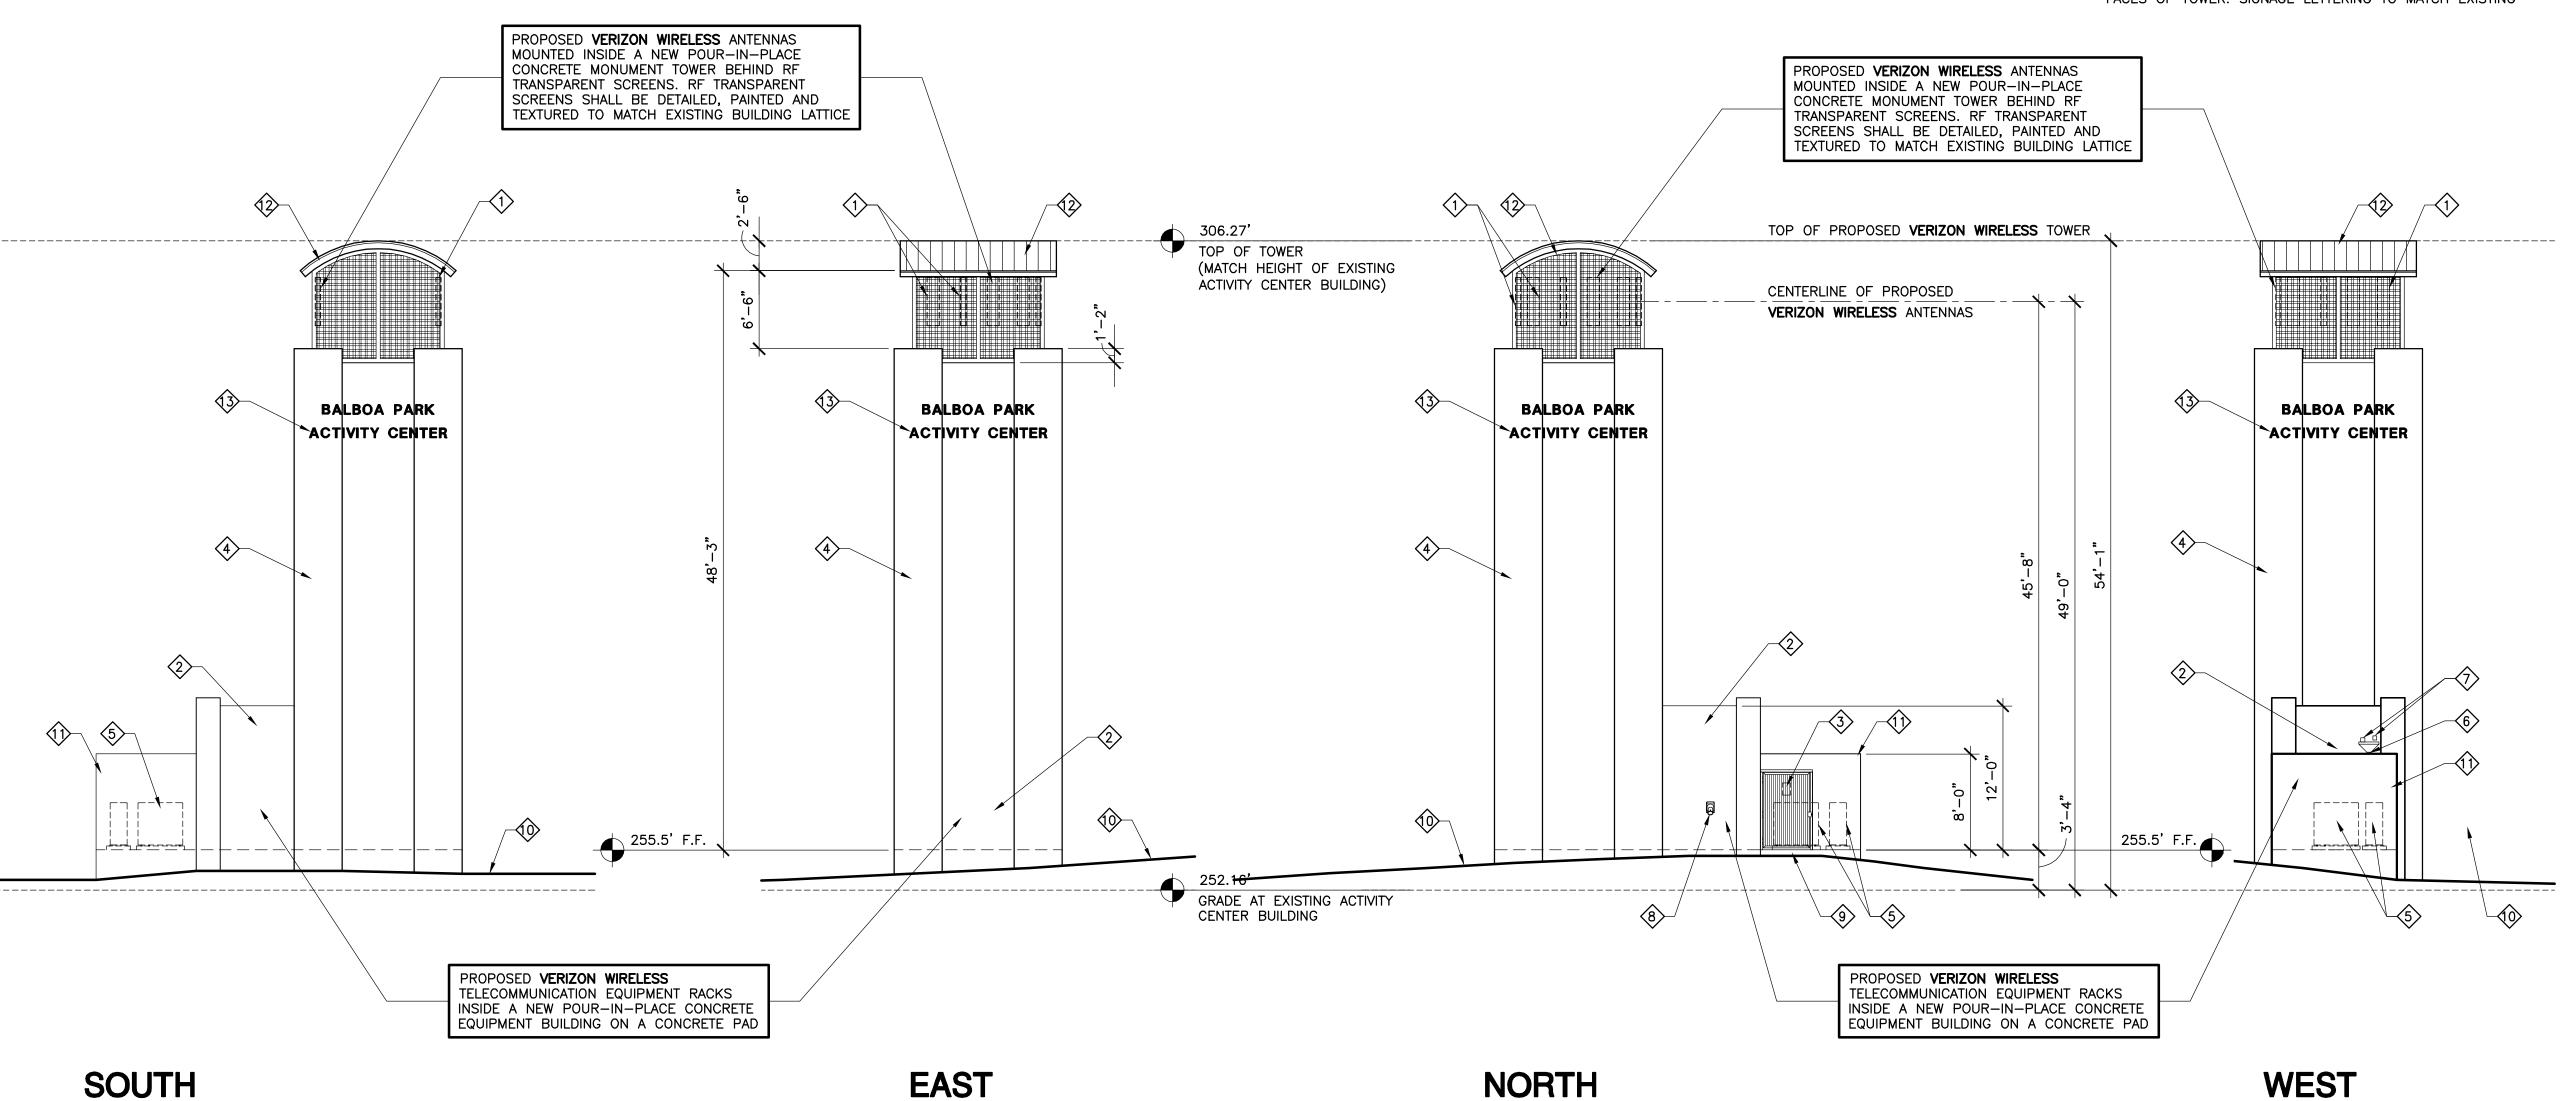

TOWER ELEVATIONS

SCALE: 1/8" = 1'-0" GRAPHIC SCALE 1' 3' 5'

TOWER ELEVATION NOTES:

PROPOSED VERIZON WIRELESS TELECOMMUNICATIONS EQUIPMENT INSIDE A NEW

PROPOSED 4'-0" WIDE SOLID STEEL GATE AND FRAME WITH VERIZON WIRELESS SIGNAGE

PROPOSED CAST-IN-PLACE CONCRETE. PAINTED TO MATCH EXISTING ACTIVITY CENTER BUILDING


5 PROPOSED MECHANICAL UNITS ON A CONCRETE PAD (TYPICAL OF 2) (SHOWN DASHED)

6 PROPOSED DOWNSPOUT

PROPOSED ROOF DRAIN AND OVERFLOW SCUPPER

PROPOSED **VERIZON WIRELESS** REVERSE GENERATOR RECEPTACLE FOR EMERGENCY GENERATOR CONNECTION MOUNTED TO WALL

PROPOSED "BALBOA PARK ACTIVITY CENTER" SIGNAGE ON ALL FOUR

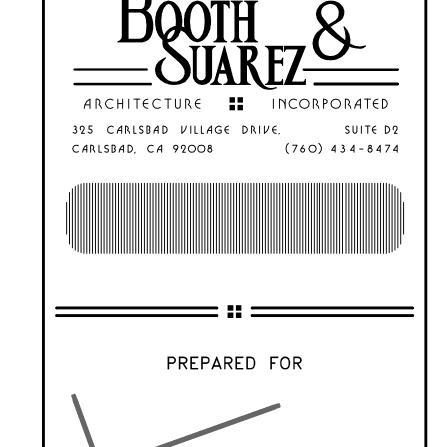

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Verizon wireless

APPROVALS DATE DATE DATE DATE EE/IN DATE

OPS

EE/OUT

PROJECT NAME

DATE

DATE

BALBOA PARK **ACTIVITY CENTER** (NAVAL HOSPITAL)

2117 PARK BOULEVARD SAN DIEGO, CA 92101 SAN DIEGO COUNTY

DRAWING DATES


100% ZD (se)
1A-CERT. 100% ZD (rd)
PLANNING REV. 100% ZD (rd)
PLANNING REV. 100% ZD (rd)
PLANNING REV. 100% ZD (ral) 06/20/11 06/27/11 08/17/11 10/28/11

SHEET TITLE

TOWER ELEVATIONS

PROJECTS\Verizon\11054zd

A-5

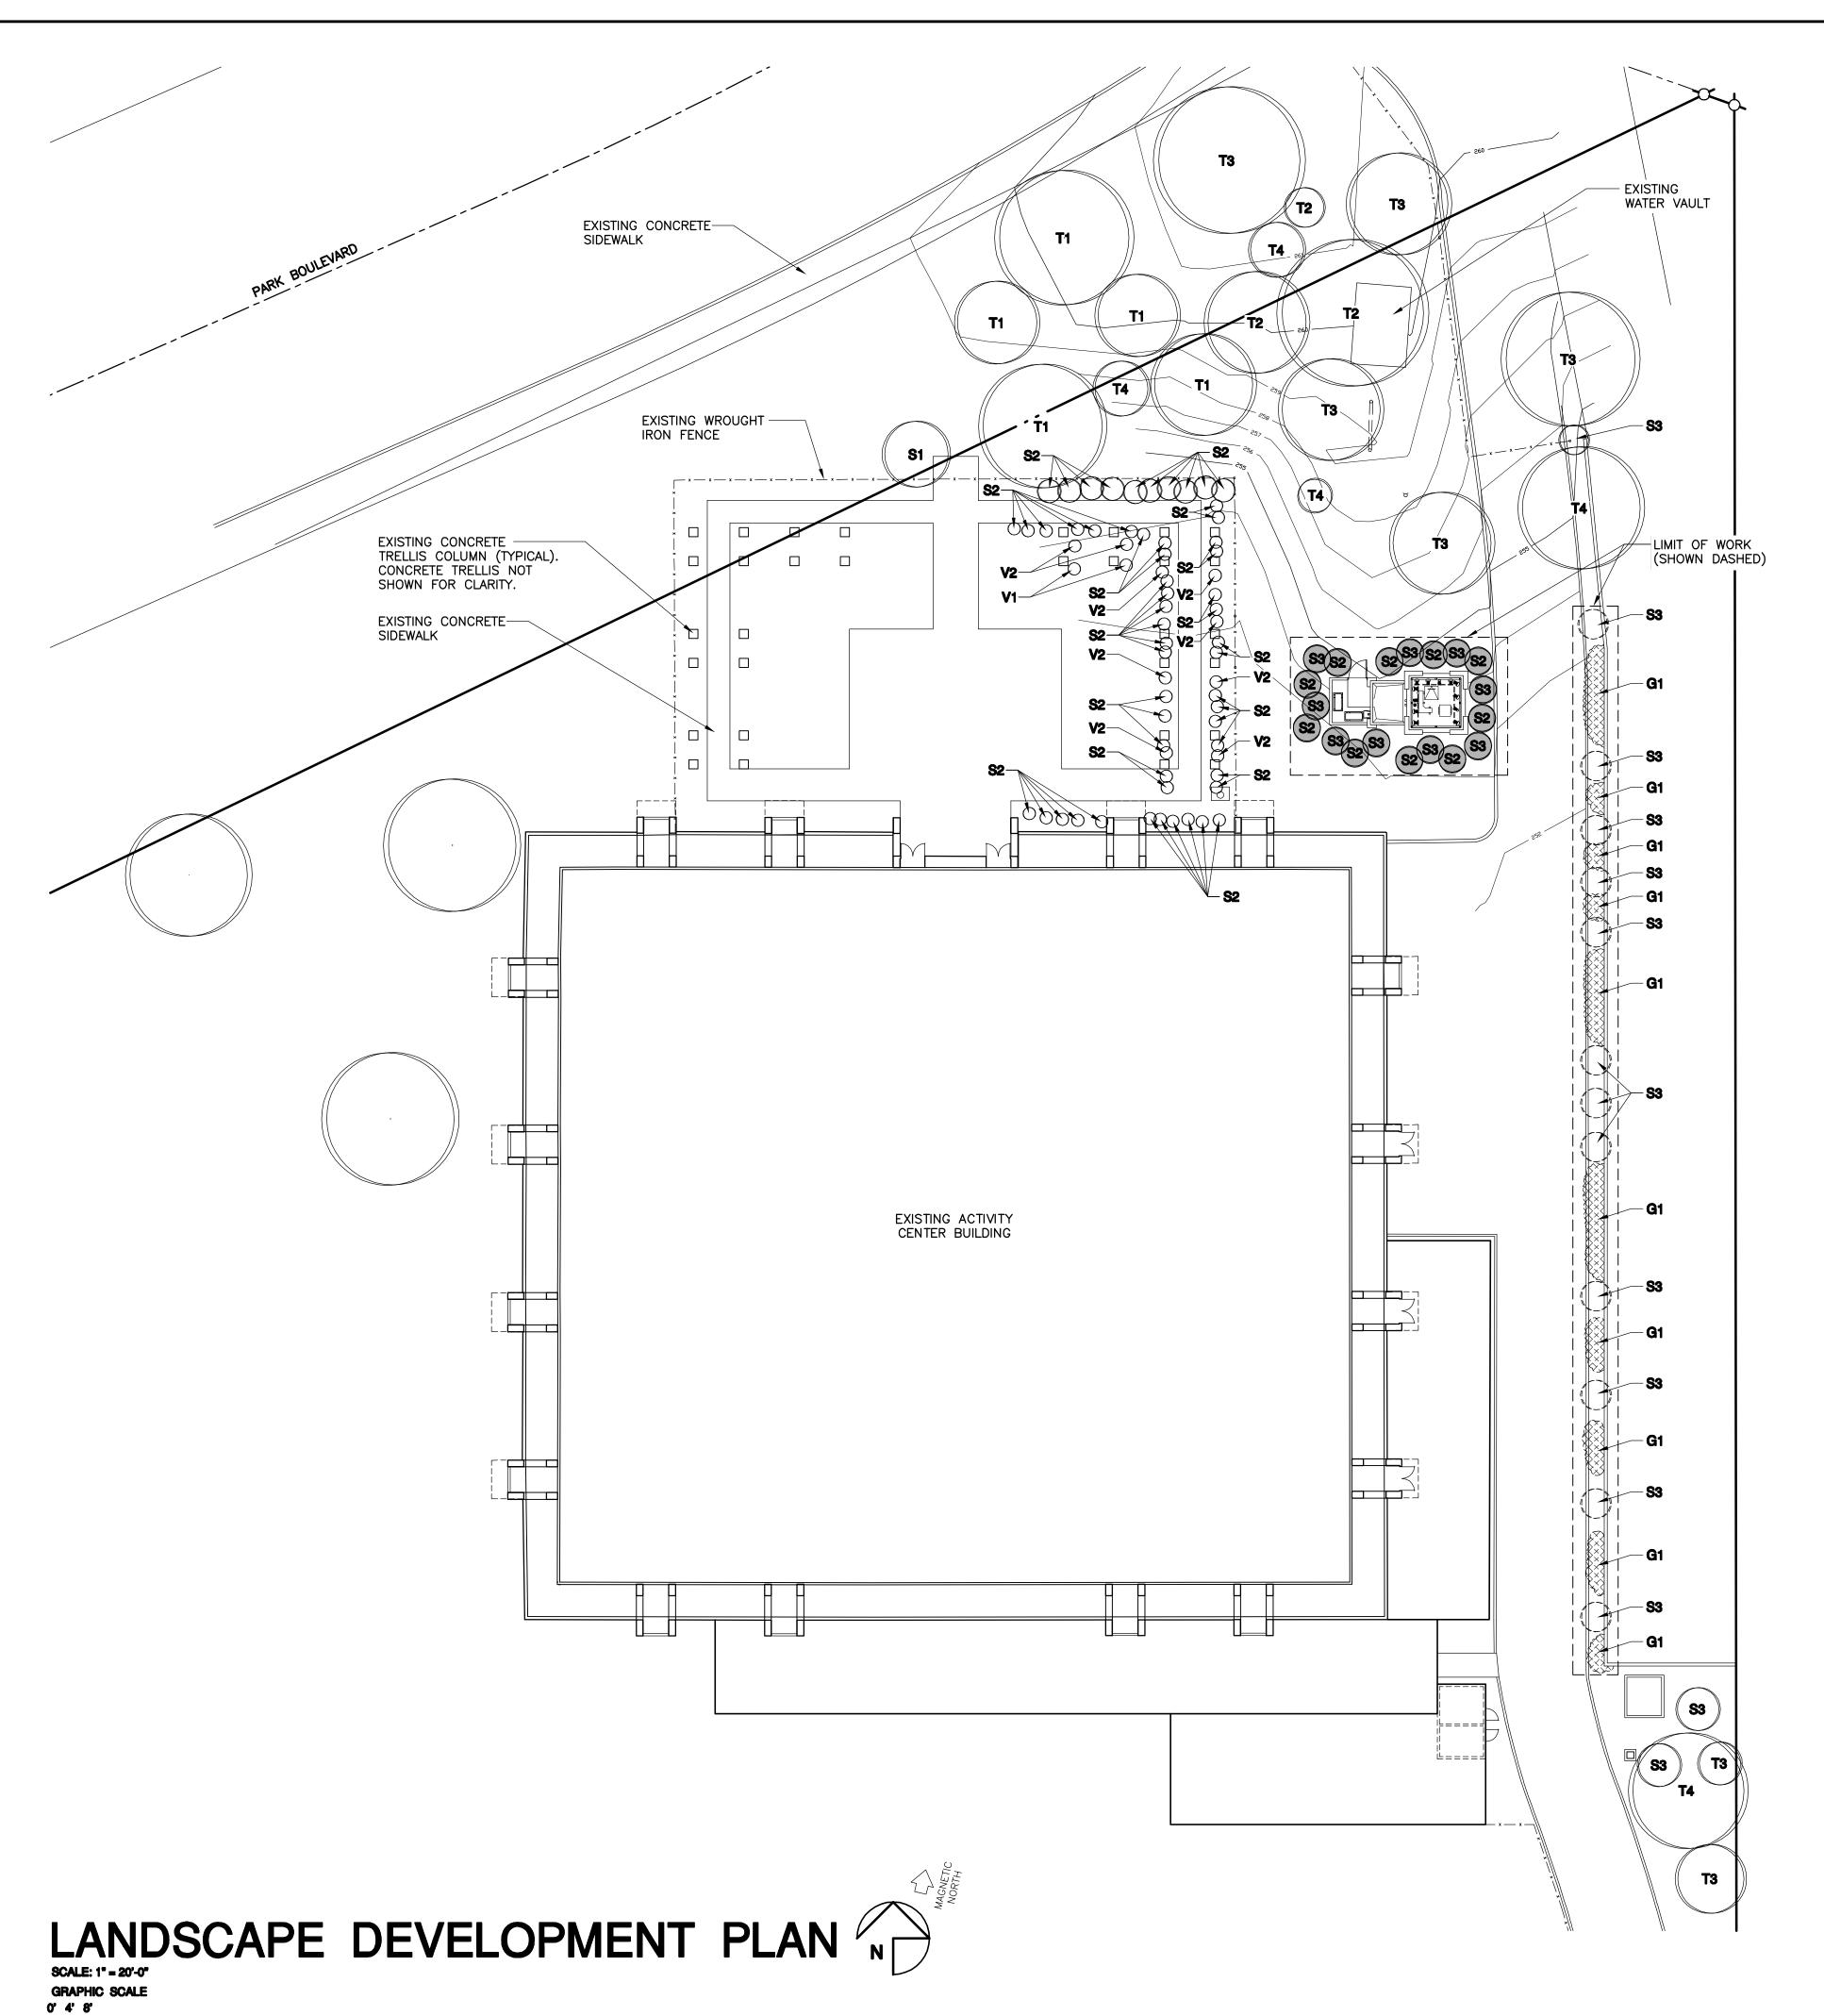

2' 6' 10' 20'

PLANTING NOTES

- DETERMINE THE LOCATION OF ALL UNDERGROUND UTILITIES PRIOR TO THE INITIATION
 OF ANY WORK. ALL WORK SHALL BE PERFORMED IN AN MANNER WHICH WILL AVOID
 POSSIBLE DAMAGE TO UTILITIES. HAND EXCAVATE AS REQUIRED.
- 2. TREES SHALL BE LOCATED A MINIMUM OF FIVE FEET FROM ANY DRAINAGE FLOW LINE, SEWER LINE, WATER LINE, GAS LINE, OR ELECTRICAL CONDUIT.
- 3. ROOT BARRIERS SHALL BE INSTALLED ADJACENT TO ALL PAVING SURFACES, WHERE A PAVING SURFACE IS LOCATED WITHIN 5' OF A TREES TRUNK. ROOT BARRIERS SHALL EXTEND FOUR FEET IN EACH DIRECTION, FROM THE CENTER LINE OF THE TRUNK, FOR A TOTAL DISTANCE OF 8 FEET. INSTALLING ROOT BARRIERS AROUND THE ROOT BALL IS UNACCEPTABLE.
- 4. TREES WILL BE LOCATED A MINIMUM DISTANCE OF 3 FEET FROM ANY PAVING SURFACE, CURB, WALL, OR CONCRETE MOW STRIP.
- 5. ALL PLANTING AREAS, SHALL RECEIVE A 3" LAYER OF MULCH.
- 6. PLANTING INSTALLATION CRITERIA:
 ALL PROPOSED TREES SHALL BE SELF—SUPPORTING, WOODY PLANTS WITH AT LEAST ONE WELL
 DEFINED TRUNK AND SHALL NORMALLY ATTAIN A MATURE HEIGHT AND SPREAD OF AT LEAST 15 FEET.
- 7. PLANTING MAINTENANCE CRITERIA: ALL LANDSCAPE INSTALLATION SHALL BE MAINTAINED IN ACCORDANCE WITH THE CITY OF SAN DIEGO LANDSCAPE STANDARDS.
- 8. MINIMUM TREE SEPARATION DISTANCE
 IMPROVEMENT/MINIMUM DISTANCE TO STREET TREE:
 TRAFFIC SIGNALS (STOP SIGN) 20 FEET ABOVE GROUND UTILITY STRUCTURES 10 FEET
 UNDERGROUND UTILITY LINES 5 FEET DRIVEWAY (ENTRIES) 10 FEET
 INTERSECTIONS (INTERSECTING CURB LINES OF TWO STREETS) 25 FEET
- 9. IRRIGATION: AN IRRIGATION SYSTEM SHALL BE PROVIDED AS REQUIRED FOR PROPER IRRIGATION, DEVELOPMENT AND MAINTENANCE OF THE VEGETATION. THE DESIGN OF THE SYSTEM SHALL PROVIDE ADEQUATE SUPPORT FOR THE VEGETATION SELECTED.
- 10. OWNER IS RESPONSIBLE FOR THE LONG TERM MAINTENANCE OF THE PROJECT AREA.

 A LANDSCAPE MAINTENANCE AGREEMENT MAY BE REQUIRED FOR THE AREAS WITHIN THE RIGHT-OF-WAY AND ANY LARGE REVEGETATED AREAS VISIBLE TO THE PUBLIC UNTIL SUCH TIME AS AN APPROVED ENTITY CAN ASSUME MAINTENANCE RESPONSIBILITIES.
- 11. MAINTENANCE: ALL REQUIRED LANDSCAPE AREAS SHALL BE MAINTAINED BY OWNER. THE LANDSCAPE AREAS SHALL BE MAINTAINED IN A FREE OF DEBRIS AND ALL PLANT MATERIAL SHALL BE MAINTAINED IN A HEALTHY GROWING CONDITION. DISEASED OR DEAD PLANT MATERIAL SHALL BE SATISFACTORY TREATED OR REPLACED PER THE CONDITIONS OF THE PERMIT.

WATER CONSERVATION NOTES

- ALL LANDSCAPE AND IRRIGATION DESIGN, INSTALLATION AND MAINTENANCE, SHALL
 CONFORM TO CITY OF SAN DIEGO LANDSCAPE REGULATIONS AND STANDARDS AND
 ALL OTHER APPLICABLE REGIONAL STANDARDS FOR LANDSCAPE INSTALLATION AND MAINTENANCE
- 2. PLANT MATERIAL SELECTED FOR THIS PROJECT WILL BE OF A TYPE KNOWN TO BE SUCCESSFUL IN THE AREA OR IN SIMILAR CLIMATIC AND SOIL CONDITIONS
- 3. LANDSCAPE FINISH GRADING OBJECTIVES WILL INCLUDE POSITIVE SURFACE DRAINAGE OF PLANTED AREAS THROUGHOUT THE PROJECT AREA
- 4. ALL PERMANENTLY LANDSCAPED AREAS WILL BE SERVED BY PERMANENT, AUTOMATIC, UNDERGROUND, IRRIGATION SYSTEMS USING LOW PRECIPITATION FIXED AND POP UP SPRAY HEADS
- 5. ALL SOILS WILL BE FERTILIZED, AMENDED, AND TILLED TO CONFORM TO RECOMMENDATIONS MADE BY A SOIL TESTING LABORATORY AND/OR LANDSCAPE ARCHITECT IN ORDER TO PROMOTE HEALTHY AND VIGOROUS PLANT GROWTH
- 6. ALL PLANTING AREAS WILL BE MAINTAINED IN A WEED AND DEBRIS FREE CONDITION
- 7. ALL ON—SITE IRRIGATION IMPROVEMENTS SHALL BE PART OF THE EXISTING POTABLE WATER DISTRIBUTION SYSTEM FOR THE EXISTING SITE
- 8. SPRINKLER HEADS SHALL BE ADJUSTED FOR OPTIMUM PERFORMANCE. THIS SHALL INCLUDE THROTTLING THE FLOW CONTROL AT EACH VALVE TO OBTAIN THE OPTIMUM OPERATING PRESSURE FOR EACH SYSTEM. CONDITIONS THAT CAUSE OVER—SPRAY, PONDING, OR RUN—OFF SHALL BE ELIMINATED. ADJUST SYSTEM TO AVOID THESE CONDITIONS
- 9. BEST IRRIGATION MANAGEMENT PRACTICES SHALL BE USED TO ELIMINATE OR CONTROL TO THE BEST EXTENT POSSIBLE PONDING, RUN-OFF, OVER-SPRAY AND MISTING
- 10. IRRIGATION HEADS SHALL BE LOCATED OR ADJUSTED TO MINIMIZE OR ELIMINATE OVER-SPRAYING ON SIDEWALKS, STREETS AND NON-DESIGNATED USE AREAS
- 11. PROVIDE MINOR MODIFICATIONS TO EXISTING IRRIGATION SYSTEM AS REQUIRED.

NOTE:

1. SEE SHEET L-2 FOR PLANTING LEGEND



ARCHITECTURE INCORPORATED

325 CARLSBAD VILLAGE DRIVE. SUITE D2

CARLSBAD, CA 92008



(760) 434-8474

PREPARED FOR



P.O. BOX 19707 IRVINE, CA 92623-9707 (949) 222-7000

APPROVALS

DATE

DATE

DATE

DATE

EE/IN DATE

OPS DATE

EE/OUT

PROJECT NAME

DATE

BALBOA PARK ACTIVITY CENTER (NAVAL HOSPITAL)

2117 PARK BOULEVARD SAN DIEGO, CA 92101 SAN DIEGO COUNTY

_____ == ___

DRAWING DATES

10/28/11

04/15/11 100% ZD (se) 06/20/11 1A-CERT. 100% ZD (rd) 06/27/11 PLANNING REV. 100% ZD (rd) 08/17/11 PLANNING REV. 100% ZD (rd)

PLANNING REV. 100% ZD (ral)

=#**=**

SHEET TITLE

LANDSCAPE DEVELOPMENT PLAN

PROJECTS\Verizon\11054zd


L-1

PLANTING LEGEND

SYMBOL	BOTANICAL NAME	COMMON NAME	FORM / FUNCTION	PLANTING SIZE	QUANTITY	MATURE HEIGHT & SPREAD	EXISTING HEIGHT & SPREAD
T1	SCHINUS MOLLE	CALIFORNIA PEPPER TREE	EXISTING	EXISTING	5	40' HT 40' W.	32' HT 30' W.
T2	EUCALYPTUS CITRIODORA	LEMON SCENTED EUCALYPTUS	EXISTING	EXISTING	3	60' HT 40' W.	64' HT 32' W.
T3	EUCALYPTUS POLYANTHEMOS	SILVER DOLLAR EUCALYPTUS	EXISTING	EXISTING	7	75' HT 45' W.	50' HT 30' W.
T4	ARBUTUS MENZIESII	PACIFIC MANDRONE	EXISTING	EXISTING	4	80' HT 60' W.	45' HT 30' W.
S1	SALVIA FARINACEA	BLUE SALVIA	EXISTING	EXISTING	1	2' HT 2' W.	_
S2	BRUXUS MICROPHYLLA	JAPANESE BOXWOOD	EXISTING	EXISTING	55	6' HT 4' W.	_
S2	BRUXUS MICROPHYLLA	JAPANESE BOXWOOD	SCREENING SHRUB	15 GAL.	10	6' HT 4' W.	_
(S3)	ACACIA REDOLENS	PROSTRATE ACACIA	EXISTING	REMOVE & REPLACE W/SAME SIZE & SPECIES	15	2' HT 15' W.	_
S3	ACACIA REDOLENS	PROSTRATE ACACIA	SCREENING SHRUB	15 GAL.	9	2' HT 15' W.	_
V1	BOUGAINVILLEA SPECTABILIS	BOUGAINVILLEA	CLIMBING VINE	EXISTING	2	30' HT 30' W.	_
V2	WISTERIA SINENSIS	WISTERIA	CLIMBING VINE	EXISTING	9	15' HT 25' W.	-
G1	LANTANA MONTEVIDENSIS	TRAILING LANTANA	GROUND COVER	REMOVE & REPLACE W/SAME SIZE & SPECIES	-	15" HT 6' W.	-
G2 	_	MULCH	GROUND COVER	EXISTING	-	-	_



325 CARLSBAD VILLAGE DRIVE. CARLSBAD, CA 92008 (760) 434-8474

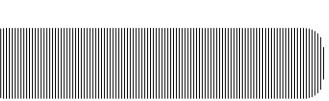

PREPARED FOR



P.O. BOX 19707 IRVINE, CA 92623-9707 (949) 222-7000

APPROVALS

A&C	DATE
RE	DATE
RF	DATE
INT	DATE

DATE EE/IN DATE OPS

DATE EE/OUT

PROJECT NAME

BALBOA PARK **ACTIVITY CENTER** (NAVAL HOSPITAL)

2117 PARK BOULEVARD SAN DIEGO, CA 92101 SAN DIEGO COUNTY

DRAWING DATES

04/15/11 100% ZD (se)
06/20/11 1A-CERT. 100% ZD (rd)
06/27/11 PLANNING REV. 100% ZD (rd)
08/17/11 PLANNING REV. 100% ZD (rd)
10/28/11 PLANNING REV. 100% ZD (ral)

SHEET TITLE

PLANTING LEGEND

OWNER'S NAME: CITY OF SAN DIEGO

ASSESSOR'S PARCEL NUMBER(S) 534-450-11-00

BASIS OF BEARINGS: (NAD 83; Epoch 2002) THE BEARINGS SHOWN HEREON ARE BASED ON TRUE NORTH AS DETERMINED BY G.P.S. OBSERVATIONS, USING TRIMBLE 5700/5800 RECEIVERS AND TRIMBLE GEODETIC OFFICE 1.60 SOFTWARE.

BASIS OF ELEVATIONS: NGVD 1929 ELEVATIONS ARE BASED ON THE CITY OF SAN DIEGO DATUM (NGVD1929). BENCHMARK USED IS LISTED AS SEBP MAIN ENTRANCE TO NAVAL HOSPITAL. ELEVATION=250.54'.

SITE DATA

FEMA FLOOD ZONE DESIGNATION

County: SAN DIEGO Effective Date: 6/19/1997 Panel: 1882F Community—Panel Number: 06073C The Flood Zone Designation for this site is: **ZONE**: X

FEMA FLOOD ZONE INFORMATION

THAT PORTION OF THE PUEBLO LANDS OF SAN DIEGO, IN THE CITY OF SAN DIEGO, COUNTY OF SAN DIEGO, STATE OF CALIFORNIA, ACCORDING TO MISCELLANEOUS MAPS THEREOF NO. 36, BY JAMES PASCOE, FILED IN THE OFFICE OF THE COUNTY RECORDER OF SAID COUNTY, BEING A PORTION OF PUEBLO LOT 1136 AND PUEBLO LOT 1143 OF SAID PUEBLO LAND ACCORDING TO MISCELLANEOUS MAPS THEREOF NO. 35, BY CHARLES B. POOLE, FILED IN THE OFFICE OF THE COUNTY RECORDER OF SAID COUNTY AND BEING MORE PARTICULARLY DESCRIBED AS FOLLOWS:

BEGINNING AT THE MOST NORTHERLY CORNER OF THAT CERTAIN TRACT OF LAND CONVEYED TO THE UNITED STATES OF AMERICA BY THE CITY OF SAN DIEGO BY DEED DATED SEPTEMBER 3, 1919, AND RECORDED IN BOOK 867 OF DEEDS, AT PAGE 302, RECORDS OF SAID COUNTY RECORDER; THENCE SOUTH 70°31'49" EAST ALONG THE NORTHERLY LINE OF SAID LAND TO THE UNITED STATES OF AMERICA A DISTANCE OF 7.14 FEET; THENCE SOUTH 0°03'49" EAST 1171.17 FEET; THENCE NORTH 89°56'11" EAST 111.16 FEET; THENCE SOUTH 0°01'56" EAST 404.56 FEET TO A POINT ON A CURVE CONCAVED NORTHEASTERLY HAVING A RADIUS OF 200.00 FEET; THENCE SOUTHERLY ALONG SAID CURVE THROUGH A CENTRAL ANGLE OF 44°17'11" A DISTANCE OF 154.59 FEET; THENCE SOUTH 44°19'07" EAST 86.65 FEET TO A POINT ON A CURVE CONCAVED SOUTHWESTERLY HAVING A RADIUS OF 200.00 FEET; THENCE SOUTHERLY ALONG SAID CURVE THROUGH A CENTRAL ANGLE OF 53°07'56 A DISTANCE OF 185.47 FEET; THENCE SOUTH 8°48'49" WEST 78.00 FEET TO A POINT ON A CURVE CONCAVED NORTHEASTERLY HAVING A RADIUS OF 115.00 FEET; THENCE SOUTHEASTERLY ALONG SAID CURVE THROUGH A CENTRAL ANGLE OF 76'47'55" A DISTANCE OF 154.15 FEET; THENCE SOUTH 67'59'06" RENT 153.28 FOOT TO A POINT ON A CURVE CONCAVED NORTHERLY HAVING A RADIUS OF 70.00 FOOT; THENCE EASTERLY AND NORTHEASTERLY ALONG SAID CURVE THROUGH A CENTRAL ANGLE OF 71°45'08" A DISTANCE OF 87.66 FEET; THENCE NORTH 40°15'46" EAST 669.59 FEET; THENCE NORTH 3°05'37" WEST 629.84 FEET; THENCE NORTH 44°56'11" EAST 169.71 FOOT; THENCE SOUTH 0°03'49" EAST 686.77 FEET TO A POINT ON THE SOUTHEASTERLY LINE OF THE LAND DESCRIBED IN A DEED TO THE UNITED STATES OF AMERICA DATED JULY 17, 1940, AND RECORDED IN BOOK 1384, PAGE 397 OF OFFICIAL RECORDS OF SAID SAN DIEGO COUNTY; THENCE ALONG SAID SOUTHEASTERLY LINE SOUTH 29"15'52" WEST 211.88 FOOT TO THE BEGINNING OF A CURVE CONCAVED NORTHWESTERLY HAVING A RADIUS OF 500.00 FEET; THENCE SOUTHWESTERLY ALONG SAID CURVE THROUGH A CENTRAL ANGLE OF 10°59'54" A DISTANCE OF 95.98 FEET; THENCE SOUTH 40°15'46" WEST 987.17 FEET TO THE BEGINNING OF A CURVE CONCAVED NORTHERLY HAVING A RADIUS OF 200.00 FEET; THENCE SOUTHERLY AND WESTERLY ALONG SAID CURVE THROUGH A CENTRAL ANGLE OF 73°46'18" A DISTANCE OF 257.51 FEET; THENCE NORTH 65°57'56" WEST 133.93 FEET TO THE BEGINNING OF A CURVE CONCAVED NORTHEASTERLY HAVING A RADIUS OF 200.00 FEET; THENCE DEPARTING FROM SAID SOUTHEASTERLY LINE AND ALONG SAID CURVE THROUGH A CENTRAL ANGLE OF 42°34'56 A DISTANCE OF 148.64 FEET; THENCE NORTH 23°23'00" WEST 425.34 FEET; THENCE NORTH 27°19'00" WEST 207.76 FEET; THENCE NORTH 30°58'00" WEST 203.42 FEET; THENCE SOUTH 63°02'59" EAST 138.58 FEET; THENCE NORTH 0°03'49" WEST 1643.44 FEET TO A POINT ON THE NORTHERLY LINE OF SAID LAND TO THE UNITED STATES OF AMERICA DATED SEPTEMBER 3, 1919; THENCE NORTH 64°14'11" EAST ALONG SAID NORTHERLY LINE 456.04 FEET TO THE POINT OF BEGINNING.

PROPERTY LEGAL DESCRIPTION

TITLE REPORT NOTES:

THE FOLLOWING EASEMENTS EFFECT SAID PARCEL AND ARE SHOWN HEREON. SEE PRELIMINARY TITLE REPORT NO.12530970 PREPARED BY LAWYERS TITLE COMPANY AND DATED FEBRUARY 28, 2011 FOR OTHER DOCUMENTS (NON-EASEMENTS) EFFECTING SAID PROPERTY.


ITEM #7 — Covenants, conditions and restrictions as set forth in the


Recorded: December 20, 1988 as Instrument No. 88-653078 of Official

Among other things, said document provides for: Easements over a portion of said land for the purpose therein shown, and rights incidental thereto. (AS SHOWN HEREON)


END OF EASEMENTS

**ALL PLOTTABLE EASEMENTS AS DESCRIBED IN SAID TITLE REPORT ARE SHOWN HEREON AND DO NOT EFFECT THE PROPOSED VERIZON'S LEASE

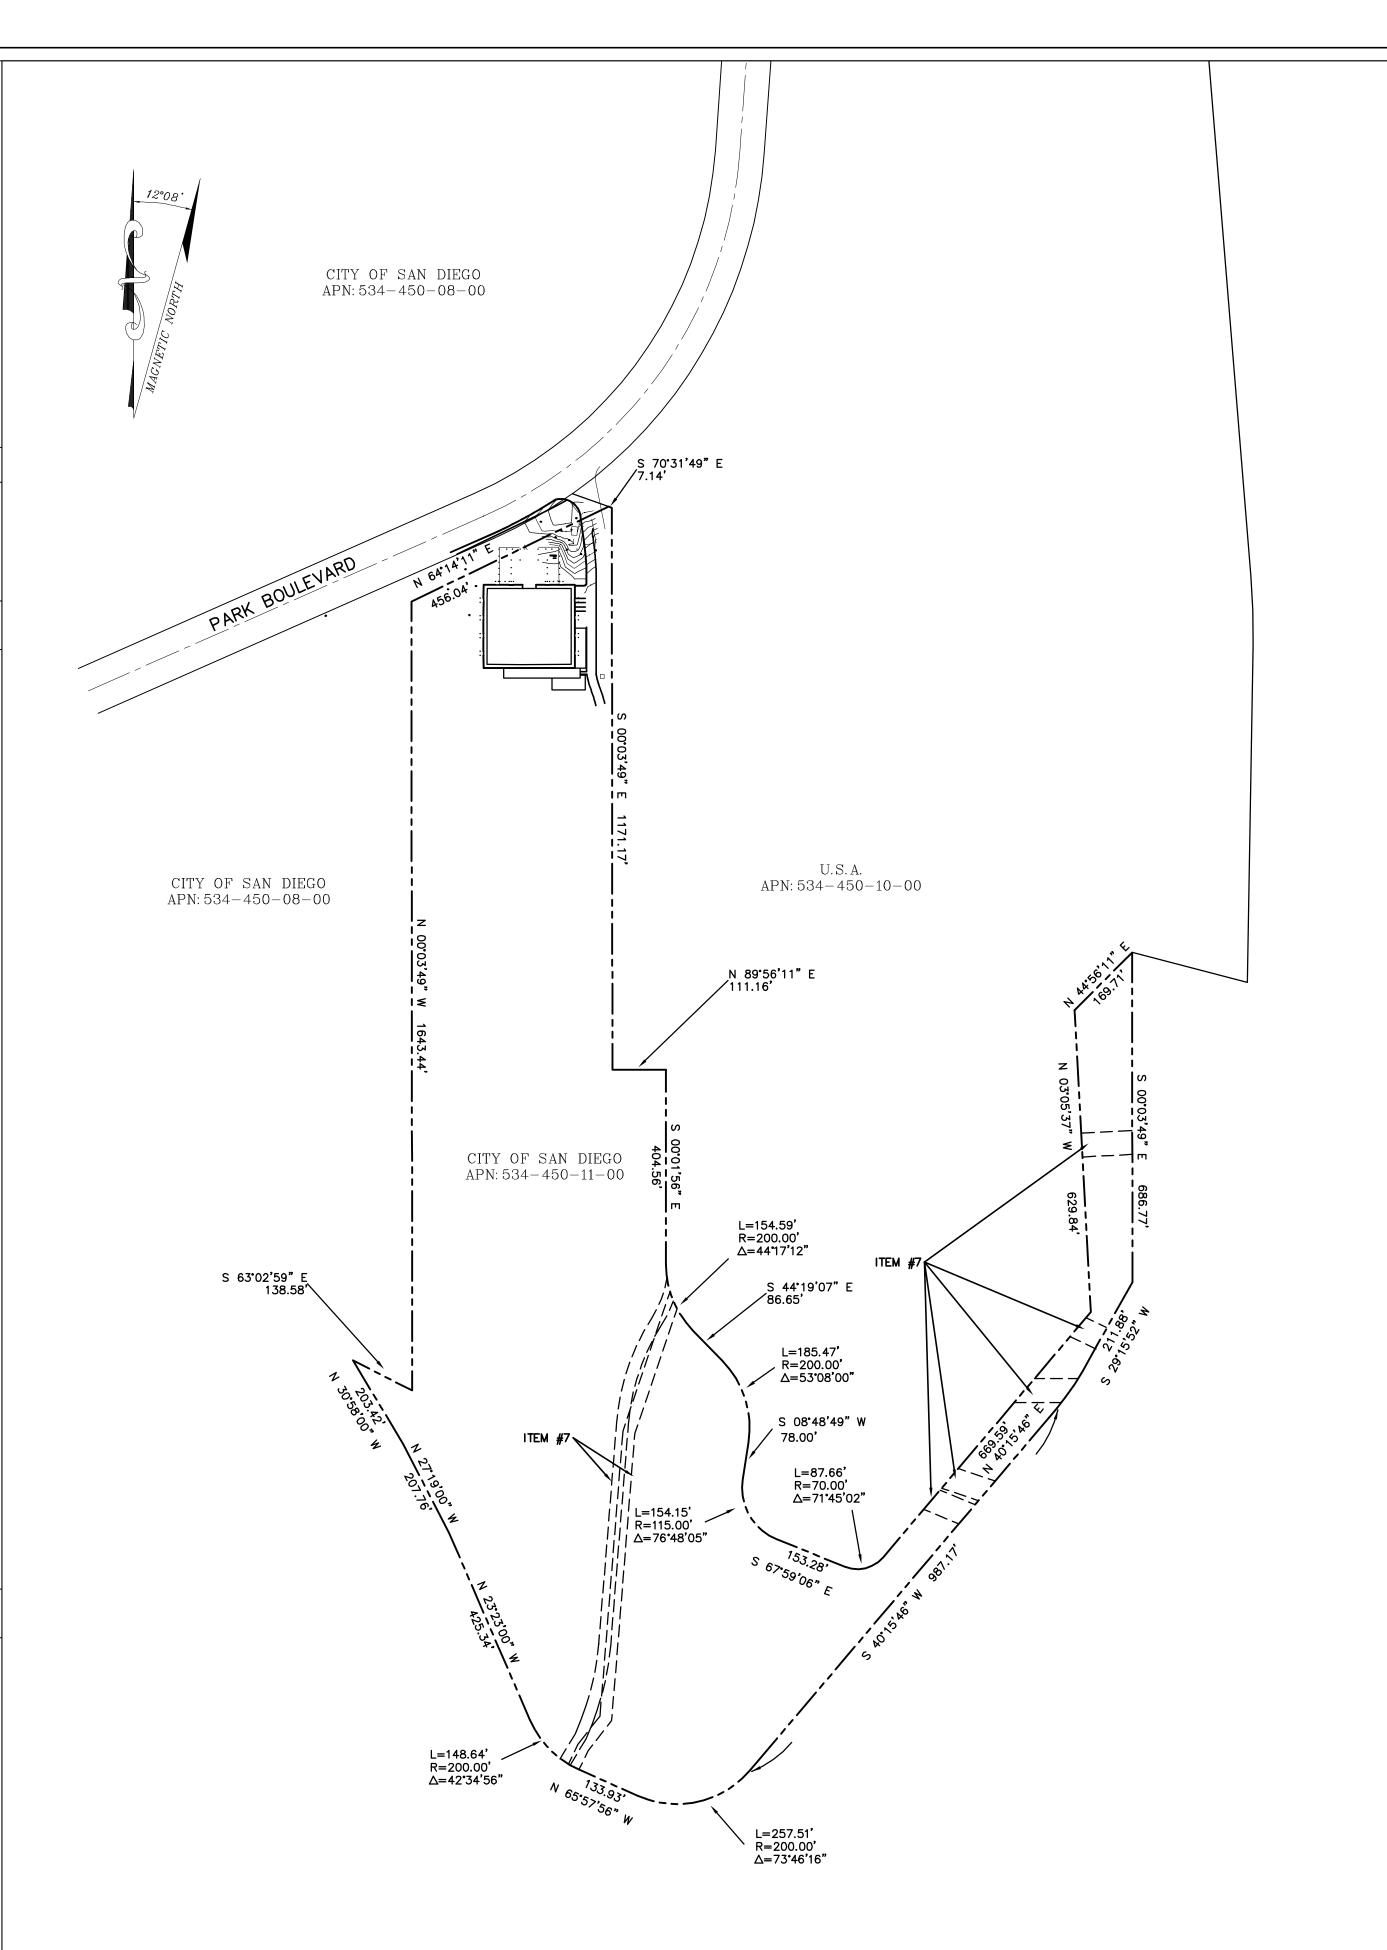

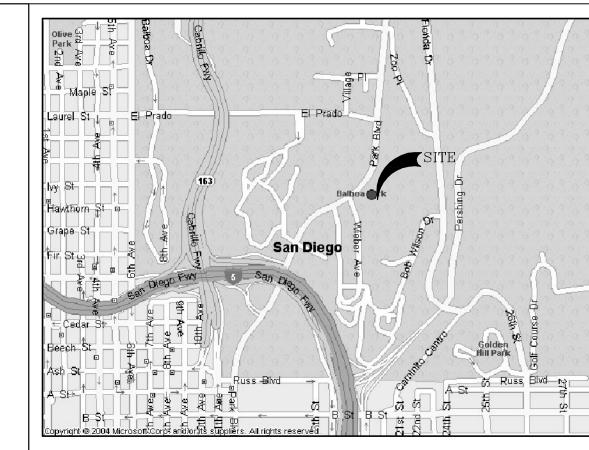

VICINITY MAP

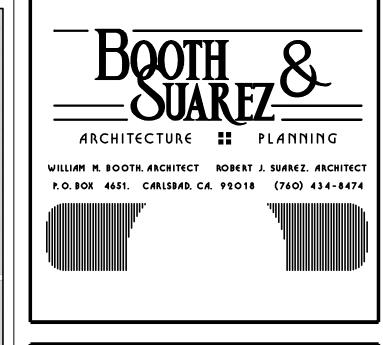



PRE	EPARED BY: DAF
CHE	ECKED BY: DAF
APF	PROVED BY: DAF

_			
	#	DATE	REVISIONS
	1.	3/22/11	SITE SURVEY
	2.	6/20/11	PROPOSED SECTORS

FLOYD SURVEYING



11576 NORGATE CIRCLE

CORONA, CA 92880

OFFICE/FAX (951) 739-7949

EMAIL: fsi@floydsurveying.com

SITE NAME NAVAL HOPITAL

SITE NUMBER

SITE ADDRESS 2145 PARK BLVD SAN DIEGO, CA 92101

SHEET TITLE

SITE SURVEY GENERAL INFORMATION

SHEET NUMBER

- BENCHMARK **V** FIRE HYDRANT FOUND MONUMENT
- TREE STORM DRAIN MANHOLE
- BOTTOM OF CURB BENCHMARK EDGE OF CONCRETE FINISH FLOOR FLOWLINE CURB & GUTTER **FNCP** FENCE TOP NG GROUND SPOT ELEVATION PS PAINT STRIPING RFOH **ROOF OVERHANG** ROOF PARAPET RFPA
- ROOF TOP RTOP SW SIDEWALK TOP OF CURB TRTP TREE TOP DECIDUOUS WTPI WATER PIPES
- ————— BOUNDARY LINE ------ CENTERLINE MISC. PROPERTY LINE ----- MISC. TIE LINE
- RIGHT-OF-WAY LINE ---- EASEMENT LINE — × — × — FENCE LINE


LEGEND

NOTES

- 1) This is not a boundary survey. This is a specialized topographic map. The property lines and easements shown hereon are from record information as noted hereon. Floyd Surveying, Inc. translated the topographic survey to record information using the two found monuments shown hereon. No title research was performed by Floyd Surveying, Inc.
- 2) Any changes made to the information on this plan, without the written consent of Floyd Surveying, Inc. relieves Floyd Surveying, Inc. of any and all liability.
- 3) These drawings & specifications are the property & copyright of Floyd Surveying, Inc. & shall not be used on any other work except by agreement with the Surveyor. Written dimensions shall take preference over scaled & shall be verified on the job site. Any discrepancy shall be brought to the notice of the Surveyor prior to commencement of any work.
- 4) Field survey completed on MARCH 16, 2011.

TITLE REPORT NOTES

OVERALL SITE PLAN 1"=200'

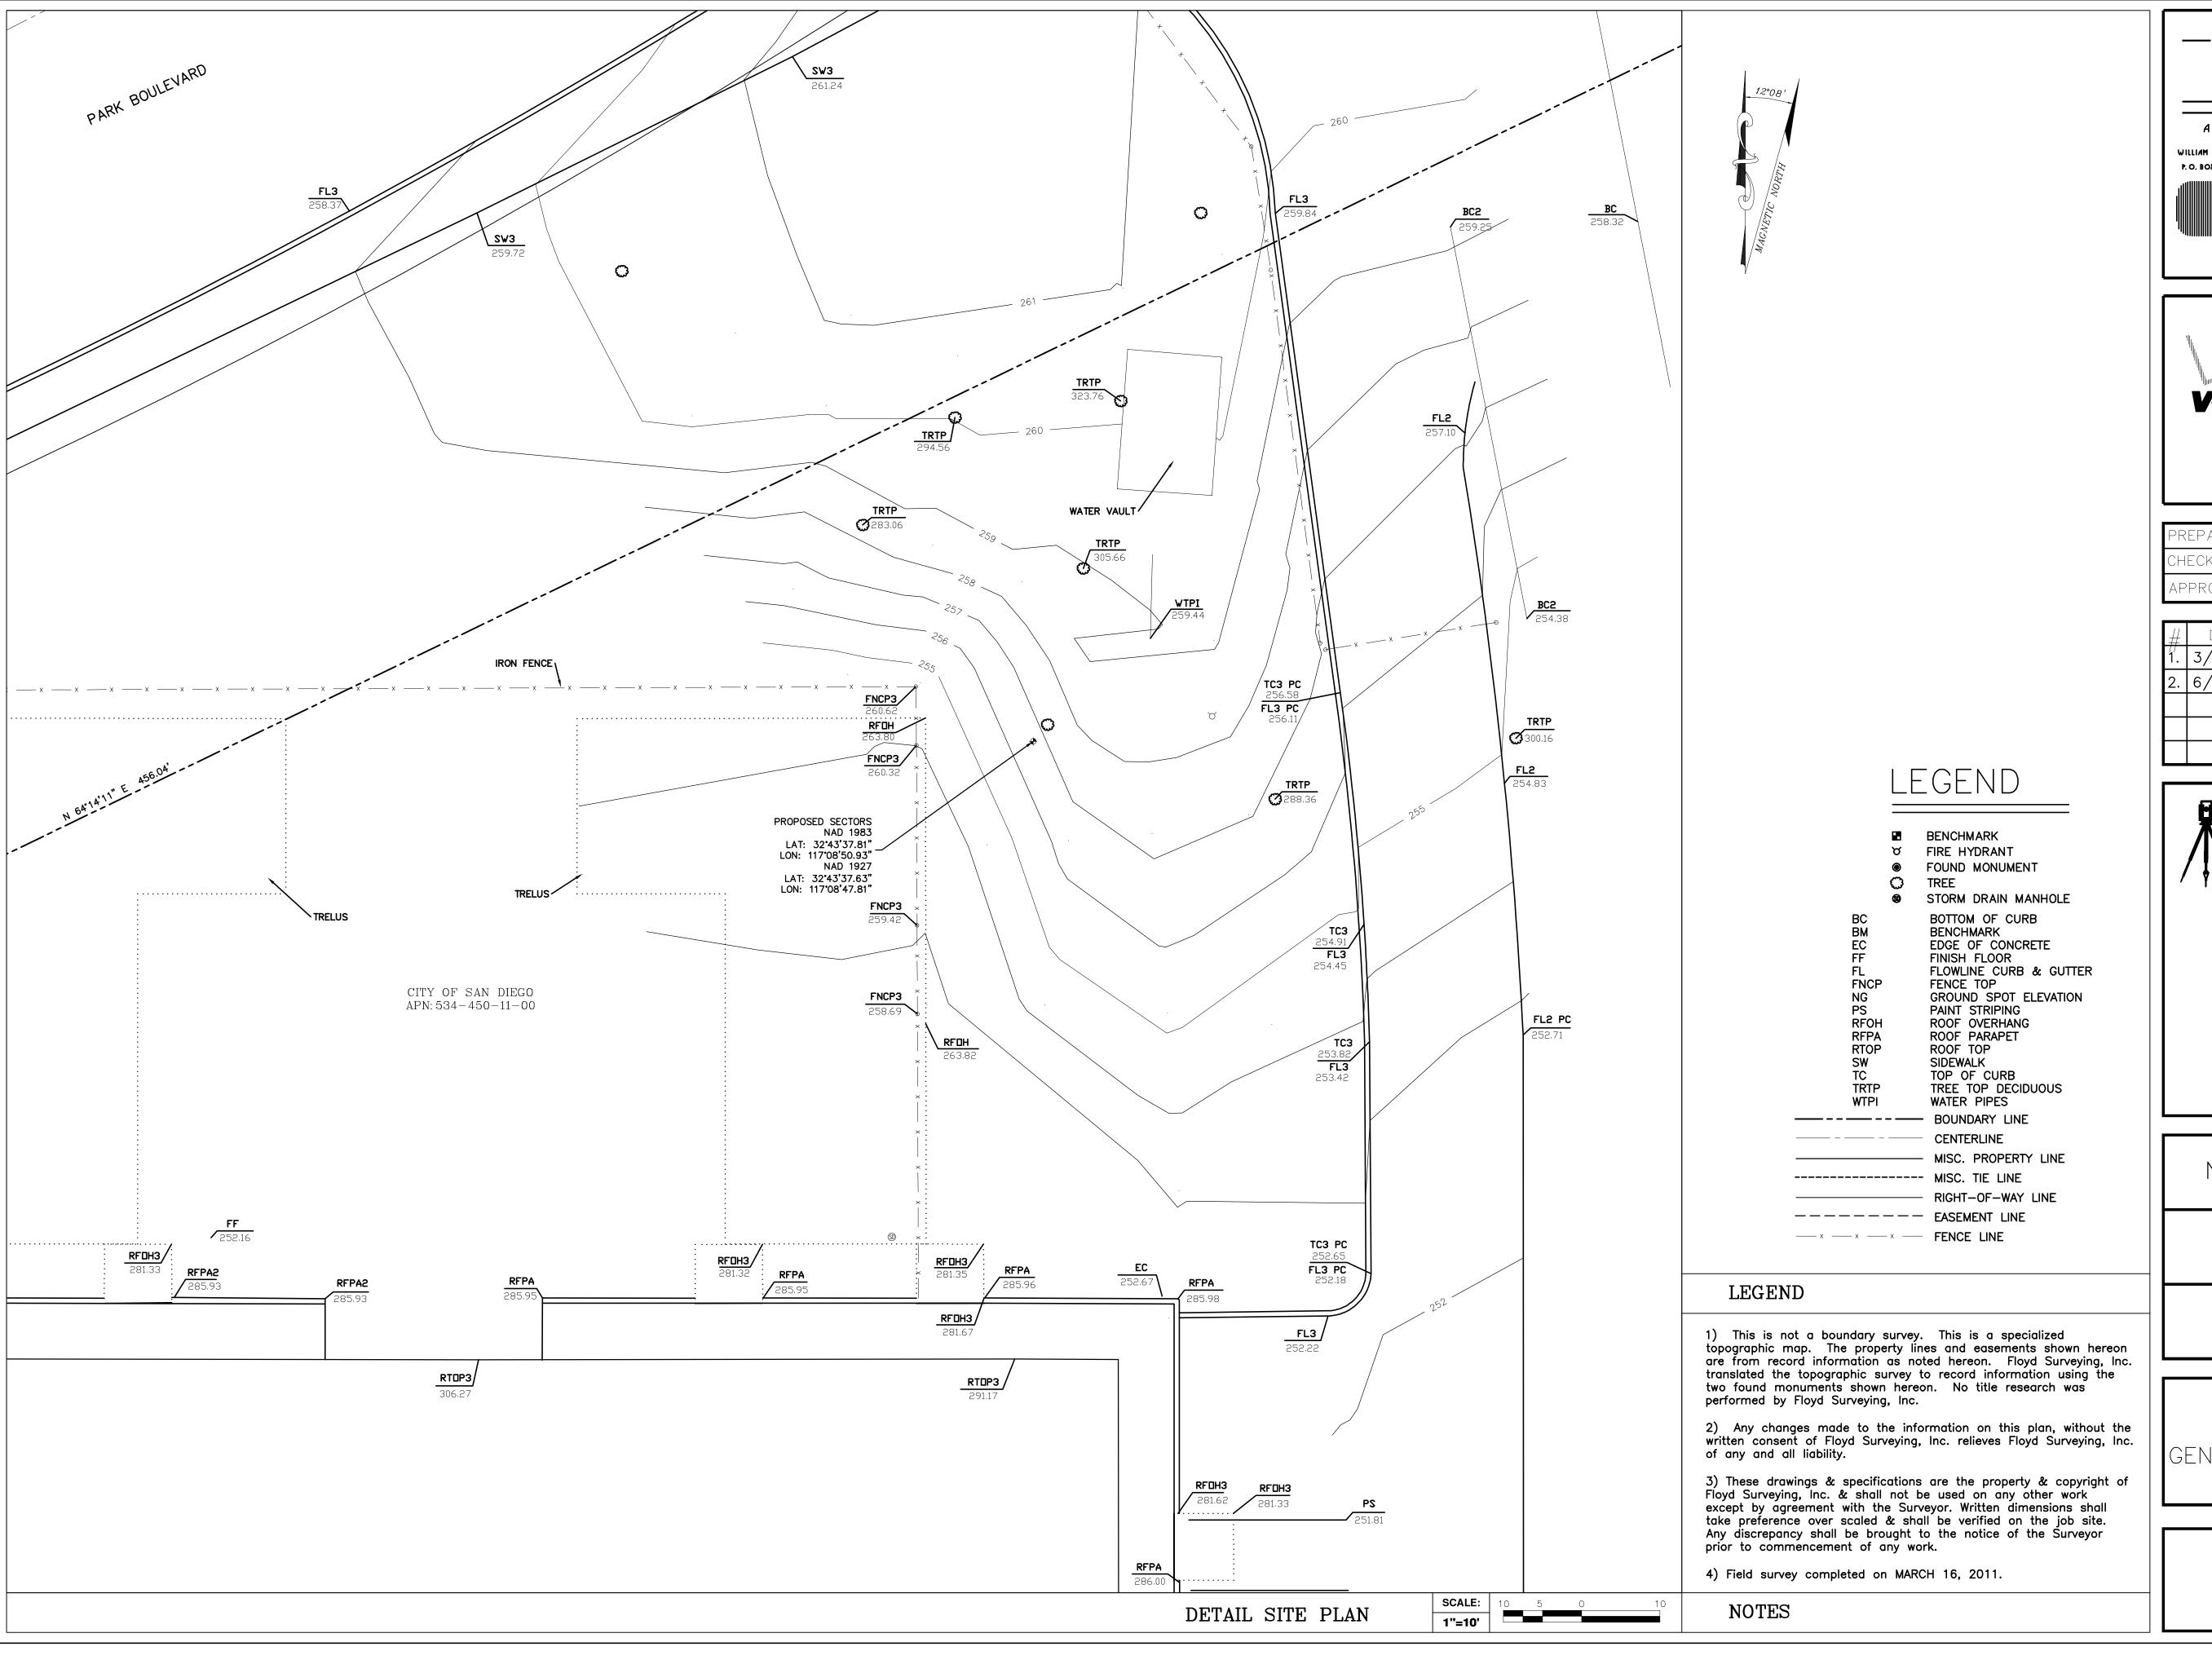



ARCHITECTURE ## PLANNING

WILLIAM M. BOOTH. ARCHITECT ROBERT J. SUAREZ. ARCHITECT P.O. BOX 4651. CARLSBAD, CA. 92018 (760) 434-8474








PREPARED BY: DAF
CHECKED BY: DAF
APPROVED BY: DAF

	#	DATE	REVISIONS
	1.	3/22/11	SITE SURVEY
	2.	6/20/11	PROPOSED SECTORS

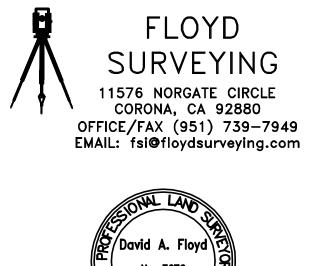

SITE NAME NAVAL HOPITAL

SITE NUMBER

SITE ADDRESS

2145 PARK BLVD
SAN DIEGO, CA 92101

SHEET TITLE

SITE SURVEY GENERAL INFORMATION

SHEET NUMBER

