

THE CITY OF SAN DIEGO

REPORT TO THE HEARING OFFICER

HEARING DATE: Janua

January 22, 2014

REPORT NO. HO 14-001

ATTENTION:

Hearing Officer

SUBJECT:

MORSE RESIDENCE PROJECT NO. 323667

LOCATION:

5550 Calumet Avenue

APPLICANT:

Samantha Tosti, Martin Architecture

SUMMARY

<u>Issue</u>: Should the Hearing Officer approve a Site Development Permit and Coastal Development Permit to allow an addition to the first floor and a new second-story floor for a total gross floor area of approximately 2,935 square feet at 5550 Calumet Avenue?

<u>Staff Recommendation</u> – **Approve** Site Development Permit No. 1130780 and Coastal Development Permit No. 1131955.

<u>Community Planning Group Recommendation</u> – The La Jolla Community Planning Association voted 12:1:1 on November 7, 2013, to recommend approval of the project.

Environmental Review: The project was determined to be exempt pursuant to California Environmental Quality Act (CEQA) Guidelines Section 15301. Section 15301 allows additions to existing structures that would not result in more than a fifty percent increase of the floor area of the structure before the addition. None of the exceptions listed in CEQA Guidelines Section 15003.2 apply, therefore this exemption is applicable to the proposed project. This project is not pending an appeal of the environmental determination. The environmental exemption determination for this project was made on December 16, 2013 and the opportunity to appeal that determination ended January 7, 2014.

BACKGROUND

The La Jolla Community Plan Land Use map designates the site for Low Density Residential use at a density range of 5-9 dwelling units per acre (Attachment 1). The site is located at 5550 Calumet Avenue in the urbanized Bird Rock neighborhood in the La Jolla community (Attachment 2). The site is zoned RS-1-7 for single family residential development. The site is currently developed with a single family structure constructed in 1952 (Attachment 3).

The owners submitted an application to the Development Services Department for a Preliminary Review, PTS# 266243, to determine early on if the existing structure has the potential to be historically significant. As part of the preliminary review undertaken in PTS#266243, the applicant submitted a Historic Resource Research Report prepared by Scott A Moomjian, dated January 2012. The report concluded the house located at 5550 Calumet Avenue is not eligible for designation under any Historic Resources Board Criteria due to a lack of integrity resulting from substantial prior alteration of the house, including: construction of a dining room addition and integral fence along the front elevation that resulted in modification of the roof pitch, installation of a masonry wall at the front with windows, door grilles and chimney; and expansion of the eave across the garage. These alterations significantly altered the original appearance of the home. Therefore, staff concurred with the conclusion of the report that the building is not eligible for designation under any Historic Resources Board Criteria.

DISCUSSION

The Morse Residence project proposes an addition to the first floor and a new second-story for a total gross floor area of approximately 2,935 square feet (Attachment 4). The project site was previously developed as a result of construction of the existing home and associated improvements on the property. All proposed development will occur on the previously developed portions of the site. New structural foundations would observe a forty-foot bluff edge setback from the coastal bluff edge. No natural slopes, sensitive coastal or marine resources or other environmentally sensitive areas would be adversely affected by the proposed project (Attachment 5).

Conclusion

Staff has reviewed the proposed project and all issues identified through the review process have been resolved in conformance with adopted City Council policies and regulations of the Land Development Code. Staff has provided draft findings to support approval of the proposed Site Development Permit and Coastal Development Permit (Attachment 5). The draft Site Development Permit No. 1130780 and Coastal Development Permit No. 1131955 is provided as Attachment 6. Staff recommends the Hearing Officer approve the project as proposed.

ALTERNATIVES

- 1. **Approve** Site Development Permit No. 1130780 and Coastal Development Permit No. 1131955, **with modifications**.
- 2. **Deny** Site Development Permit No. 1130780 and Coastal Development Permit No. 1131955, **if the findings required to approve the project cannot be affirmed**.


Respectfully submitted,

John S. Fisher

Development Project Manager Development Services Department

Attachments:

- 1. Community Plan Land Use Map
- 2. Project Location Map
- 3. Aerial Photograph & Street view
- 4. Project Plans
- 5. Draft Permit Resolution with Findings
- 6. Draft Permit with Conditions
- 7. Environmental Exemption
- 8. Project Data Sheet
- 9. Community Planning Group Recommendation
- 10. Ownership Disclosure Statement

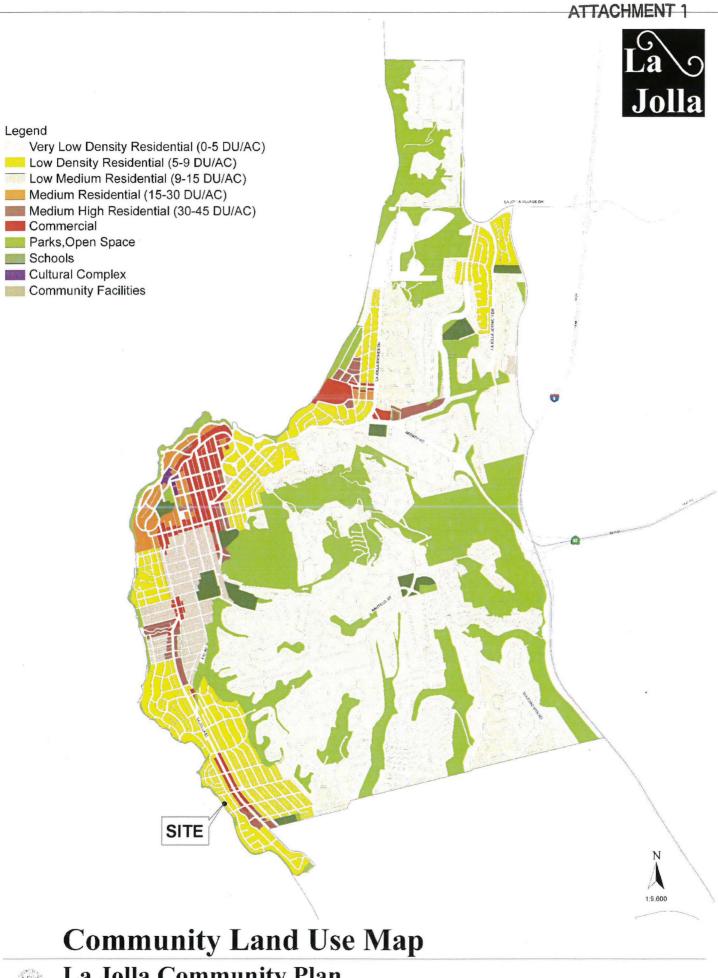



Google

To see all the details that are visible on the screen, use the "Print" link next to the map.





MARTIN ARCHITECTURE TIM MARTIN AIA

2333 STATE STREET STE 100 CARLSBAD, CA 92008

CIVIL ENGINEER/

SURVEYOR:

CHRISTENSEN ENGINEERING & SURVEYING

7888 SILVERTON AVE. SUITE J SAN DIEGO CA 92126

GEO-TECHNICAL ENGINEER:

GEOTECHNICAL EXPLORATION INC 7420 TRADE STREET

SAN DIEGO, CA 92121 858.549.7222

GEOSOILS, INC DAVID W. SKELLY MS CARLSBAD, CA 92008

760 438 3155

LANDSCAPE ARCHITECT:

COASTAL ENGINEER:

TODD FRY LANDSCAPE ARCHITECT ASIA 7920 PRINCESS STREET LA JOLLA, CA 92037

APPLICABLE CODES

2010 CALIFORNIA RESIDENTIAL CODE (CRC) 2010 CALIFORNIA MECHANICAL CODE (CMC) 2010 CALIFORNIA PLUMBING CODE (CPC) 2010 CALIFORNIA ELECTRICAL CODE (CEC) 2010 CALIFORNIA FIRE CODE (CFC) 2008 BUILDING ENERGY EFFICIENCY STANDARDS CITY OF SAN DIEGO LAND DEVELOPMENT CODE (LDC) CALIFORNIA ENVIRONMENTAL QUALITY ACT (CEQA)

PERMIT HISTORY

ORIGINAL HOUSE CONSTRUCTED WOOD DECK PATIO & FENCING RIP RAP & CLIFF PROTECTION ADDITION @ COURTYARD PRELIMINARY REVIEW #266243

(HISTORIC-NOT ELIGIBLE) PLANNING - CONFIRM SETBACKS & EXIST GFA

GROSS FLOOR AREA SUMMARY

EXISTING MAIN LEVEL HABITABLE EXISTING MAIN LEVEL GARAGE 340 SF

EXISTING COVERED LOGGIA EXISTING MAIN LEVEL GROSS 345 SF 2,010 SF (CONFIRMED BY PRELIM, REVIEW #308330)

LOT AREA MAY ALLOWARIE GEA

5.019 x .59 = 2.961 SF

ANALYSIS OF 50% MAX ADD'N CRITERIA (PER LJ COMMUNITY PLAN) MAX ADDITION = 2,010 SF x 50% = 1,005 SF 2 010 SF + 1 005 SF = 3 015 SF > 2 961 SF

PROPOSED BUILDING AREAS

MAIN LEVEL HABITABLE UPPER LEVEL HABITABLE 1,015 SF TOTAL HABITABLE 2,475 SF COVERED LANAI (UNDER HAB.) 25 SF

MAX ALLOWABLE GFA = 2,961 SF (TABLE 131-04) GOVERN

TOTAL PROPOSED GROSS FLOOR AREA 2,935 SF (2,961 SF ALLOWED)

PROPOSED F.A.R. = 2,935 / 5,019 = .58

SENSITIVE COASTAL BLUFFS

BLUFF FRONTING THIS PROPERTY IS PROTECTED BY AN EXISTING SEAWALL & BLUFF PROTECTION SYSTEM, PER SDMC SECTION 143,0143. THE 40' BLUFF SETBACK CANNOT BE REDUCED, PROPOSED NEW CONSTRUCTION IS ENTIRELY SUPPORTED BEHIND THIS 40' BLUFF SETBACK (SEE SHEET 13).

ALL EXISTING ACCESSORY STRUCTURES WITHIN 5' OF THE BLUFF EDGE & DEEMED TO BE NOT NECESSARY FOR THE STABILITY OF THE BLUFF ARE PROPOSED TO BE

A COVENENT OF EASEMENT FOR ESL REGULATIONS IS REQUIRED TO PRESERVE THE COASTAL BLUFF

PROJECT DATA

5550 CALUMET AVENUE SITE ADDRESS

357-521-06 5,017 SF (.12 ACRE) LOT AREA:

LEGAL DESC LOT 36 OF CLIFFSIDE, IN THE CITY OF SAN DIEGO, COUNTY OF SAN DIEGO STATE OF CALIFORNIA

OWNER: ROBERT & KAREN MORSE

BASE ZONE:

HEIGHT LIMIT

BCS STOPS:

FIRE DEPT. REQUMENTS

GEOLOGIC HAZARD CATEGORY

COASTAL; COASTAL HEIGHT LIMIT; FIRST PUBLIC ROADWAY; APPEALABLE AREA OVERLAY ZONES: PARKING IMPACT: RESIDENTIAL TANDEM PARKING; TRANSIT AREA
ESL- SENSITIVE COASTAL BLUFFS: SENSITIVE BIOLOGICAL: SENSITIVE COASTAL

RS-1-7

OCCUPANCY:

CONSTRUCTION TYPE

PARKING: NO. OF SPACES REQUIRED: 2 PROVIDED: 2

BUILDING HEIGHT 27'-6" (30' MAX)

EASEMENTS & ENCUMBERANCES NONE

VICINTY MAP:

SITE

SECOND FLOOR ADDITION

LEGEND

//// EXISTING 1-STORY

SECOND LEVEL DECK

EXIST SEAWALL-TO REMAIN

EXIST 6'H CHAINLINK-FENCE TO REMAIN

SITE IS LOCATED WEST OF 1-5. THE HIGHEST POINT OF THE ROOF, EQUIPMENT, ANY PIPE VENT, ANTENNA OR ANY OTHER PROJECTION SHALL NOT EXCEED 30' ABOVE GRADE, AS

MEASURED PER PROP D OF THE SDMCMA

THERE ARE NO EXISTING OR PROPOSED BUS/TRANSIT

PROVIDE BUILDING ADDRESS NUMBERS VISIBLE & LEGIBLE FROM STREET PER FHPS POLICY P-00-6 (UFC 901.4.4)

EXISTING BRICK— TERRACE TO REMAIN

45.9

LOW POINT DATUM 42.0' (BELOW DECK)

EXIST BRICK WALL & PLANTER TO REMAIN

EXIST. JUNIPER TO _____ TO REMAIN (UNIRRIGATED)

EXIST. BRICK PAVING TO REMAIN— AS A PART OF THE EXIST BLUFF PROTECTION SYSTEM, BUT ACCESS STAIR IS TO BE REMOVED

EXIST RETAINS WALL TO REMAIN

41 -8" EXIST

N56°38'54"E

EXIST MIDDLE DECK TO BE REMOVED

98.33

OCEAN

2

EXIST LOWER DECK TO REMAIN
AS PART OF THE EXISTING BLUFF
PROTECTION SYSTEM, BUT ACCESS

STAIRS TO BE REMOVED

EXIST GUNITED BLUFF PROTECTION SYSTEM TO REMAIN

SEE VICINITY MAP FOR HYDRANT LOCATIONS

12, 47 & 53

SCOPE OF WORK

ATTACHMENT 4

RENOVATIONS & SECOND STORY ADDITION TO EXISTING 1 STORY 2,010 SF SINGLE FAMILY RESIDENCE; EXPANDING EXISTING GARAGE TO PROVIDE 2 CAR PARKING

REMOVAL OF MIDDLE DECK: REMOVAL OF VERTICAL ACCESS STATES TO REACH

NEW STORM DRAINAGE SYSTEM W/ ALL SURFACE RUNOFF ABOVE BLUFF COLLECTED & CONVEYED TO STREET

RESIDENCE

MORSE

PREVIOUSLY CONFORMING CONDITIONS

EXISTING STRUCTURE EXTENDS BEYOND 40' BLUFF EDGE SETBACK

EXISTING SEAWALL & GUNITED BLUFF FACE

EXISTING WOOD FRAMED DECKS (3) W/IN 5' BLUFF EDGE SETBACK

EXISTING CHAIN LINK FENCE @ REAR PROPERTY LINE


SITE PLAN GRADING & DRAINAGE PLAN


STIF SECTIONS

REQUIRED DISCRETIONARY PERMIT APPROVAL

STTE DEVELOPMENT PLAN

SHEET INDEX

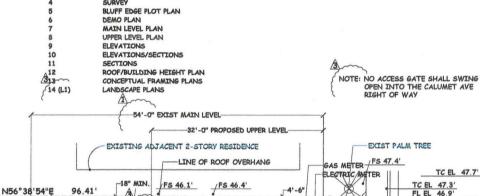

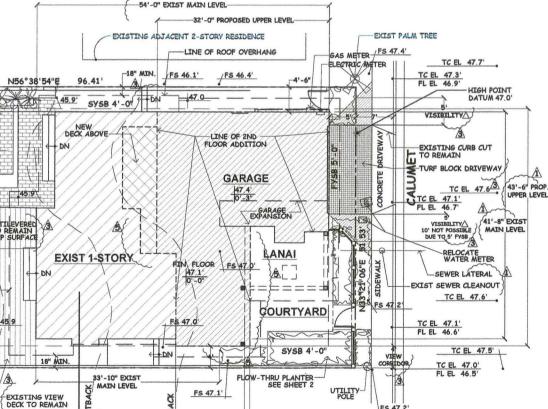

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> CDP 5.2.13 ₫ 5.20.13 A 6.04.13 \$ 9.10.13 A 11.25.13 A 01.03.14

SHEET NO.

OF 14

NORTH

NOTE: SEE SHEET 13 FOR STRUCTURAL SUPPORT OF 2ND

SITE PLAN

1/8"=1'-0"

ALL LOADBEARING SUPPORT FOR THE PROPOSED NEW DEVELOPMENT SHALL BE LOCATED AT LEAST 40' LANDWARD OF THE COASTAL BLUFF EDGE.

STORY ADDITION BEHIND 40' BLUFF EDGE SETBACK


'-8" PROPOSED

MAIN LEVEL

13'-8" PROPOSED

HITECTUR A9 A.I.A. Carlsbad, Martin /

ATTACHMENT

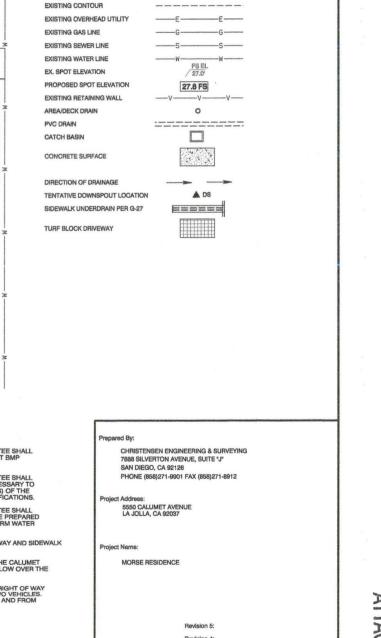

LEGAL DESCRIPTION

APN / ADDRESS

ADDRESS:

NOTES

LEGEND


PROPERTY LINE

LOT 36 OF CLIFFSIDE, IN THE CITY OF SAN DIEGO, COUNTY OF SAN DIEGO, STATE OF CALIFORNIA, ACCORDING TO MAR THEREOF NO. 2798, FILED IN THE OFFICE OF THE COUNTY RECORDER OF SAN DIEGO COUNTY JULY 11, 1981.

 THE SOURCE OF THE TOPOGRAPHIC INFORMATION SHOWN HEREON IS FROM SURVEY PERFORMED BY CHRISTENSEN ENGINEERING & SURVEYING DATED FEBRUARY 21, 2013, REVISED APRIL 4, 2013.

4. EXISTING LOT IS ENTIRELY DISTURBED. NO UNDISTURBED AREAS EXIST.

3. BENCHMARK: CITY OF SAN DIEGO BRASS PLUG LOCATED AT THE SOUTHWESTERLY CORNER OF CALLIMET AVENUE AND FORWARD STREET. ELEVATION = 40.81' MEAN SEA LEVEL (N.G.Y.D. 1929).

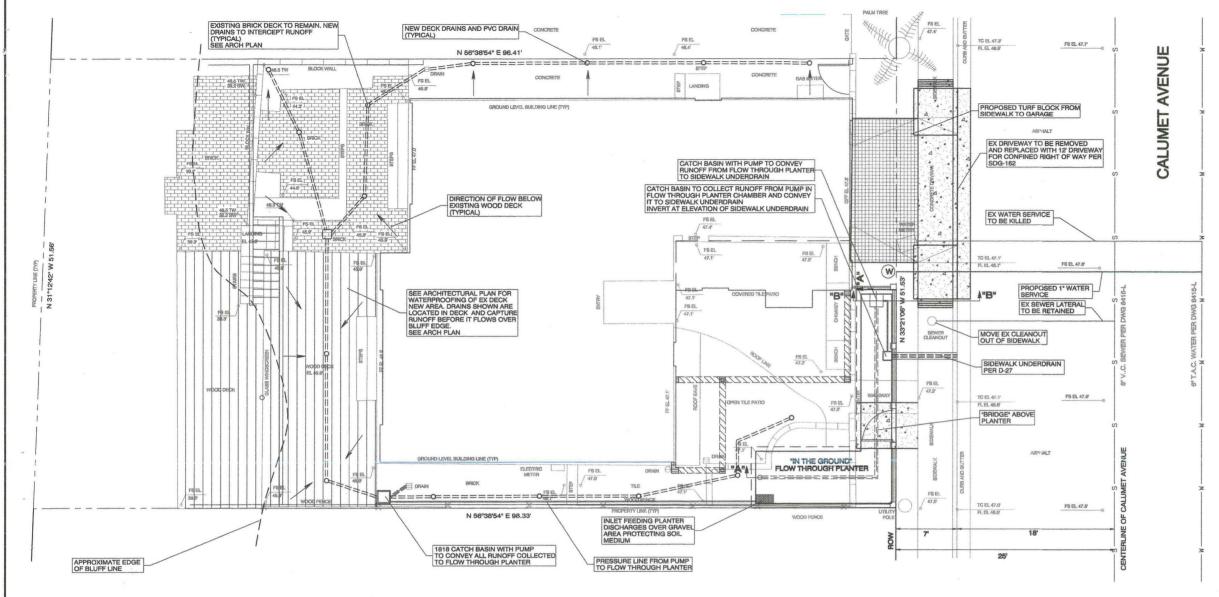

- SIDEWALK RAMP

PLANTER THAT CONVEYS RUNOFF TO SIDEWALK

GRADING DATA

AREA OF SITE - 5,017 S.F. AREA OF SITE TO BE GRADED - 0 SF PERCENT OF SITE TO BE GRADED - 0%

AMOUNT OF CUT - N/A C.Y.
AMOUNT OF FILL - N/A C.Y.
AMOUNT OF EXPORT - N/A C.Y.
MAXIMUM HEIGHT OF FILL - N/A
MAXIMUM FILL SLOPE RATIO 2:1
MAXIMUM FILL SLOPE HEIGHT: NONE

MAXIMUM HEIGHT OF CUT N/A MAXIMUM HEIGHT OF CUT SLOPE - NONE MAXIMUM CUT SLOPE RATIO - 2:1

LENGTH OF SITE RETAINING WALL - NONE MAX HEIGHT OF SITE RETAINING WALL - N/A NO GRADING IS PROPOSED FOR THIS PROJECT

PRIOR TO ISSUANCE OF ANY CONSTRUCTION PERMIT, THE OWNER/PERMITEE SHALL ENTER INTO A MAINTENANCE AGREEMENT FOR THE ONGOING PERMANENT BMP MAINTENANCE SATISFACTORY TO THE CITY ENGINEER.

PRIOR TO ISSUANCE OF ANY CONSTRUCTION PERMIT, THE OWNER/PERMITEE SHALL INCORPORATE ANY CONSTRUCTION BEST MANAGEMENT PRACTICES NECESSARY TO COMPLY WITH CHAPTER 14, ARTICLE 2, DIVISION 1 (GRADING REGULATIONS) OF THE SAN DIEGO MUNICIPAL CODE. INTO THE CONSTRUCTION PLANS OR SPECIFICATIONS.

PRIOR TO ISSUANCE OF ANY CONSTRUCTION PERMIT, THE OWNER/PERMITEE SHALL SUBMIT A WATER POLLUTION CONTROL PLAN (WPCP). THE WPCP SHALL BE PREPARED IN ACCORDANCE WITH THE GUIDELINES IN APPENDIX E OF THE CITY'S STORM WATER STANDARDS.

AN EMRA WILL BE REQUIRED FOR PRIVATE WALKWAY, TURF BLOCK DRIVEWAY AND SIDEWALK UNDERDRAIN WITHIN THE RIGHT OF WAY

RUNOFF WILL TREATED IN A FLOW THROUGH PLANTER AND PUMPED TO THE CALUMET AVENUE AND THE PUBLIC STORM DRAIN LOCATED THEREIN. IT WILL NOT FLOW OVER THE COASTAL BLUFF.

DUE TO THE LOCATION OF EXISTING GARAGE AND ITS PROXIMITY TO THE RIGHT OF WAY A 16 DRIVEWAY IS REQUIRED TO ALLOW FOR USE OF THE GARAGE FOR TWO VEHICLES. A 12 DRIVEWAY WOULD NOT PROVIDE SUFFICIENT WIDTH FOR ACCESS TO AND FROM THE GARAGE



SEPTEMBER 23, 2013

PROFESS (Other CAS) (Other CAS

SCALE: 1" = 10'

SECTION "A" - "A"

FLOW THROUGH PLANTER

NOT TO SCALE

CLEANOUT-

DRAIN ROCK-

PATIO SURFACE-

HERBACEOUS OR OTHER APPROPRIATE VEGETATION TO BE PLANTED IN PLANTING MEDIUM

- PLANTING MEDIUM (18" MIN)

- RUNOFF STORAGE AREA (6" MIN)

- CLOSE MESHED GRATE

OUTLET/OVERFLOW

CLOSE MESHED GRATE

- CLOSE MESHED GRATE

SECTION "B" - "B"

FLOW THROUGH PLANTER

AT UNDERDRAIN

NOT TO SCALE

CURB-

JN 2013-2

Revision 3: 09-23-13 REVISE DRIVEWAY

DRAINAGE PLAN

Revision 2: 09-10-13 ADDRESS CITY COMMENTS

Revision 1: 05-20-13 ADD EX WALL ELEVATIONS

Original Date: MAY 06, 2013

SHEET 2 OF 14 SHEETS








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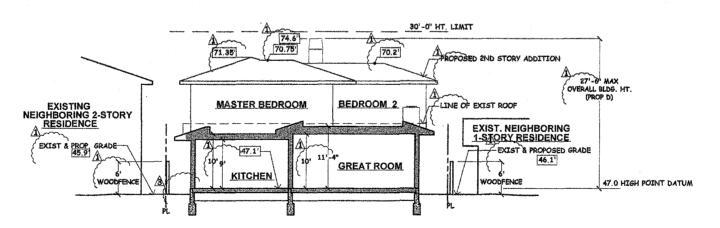
SHEET NO.

3 of 14


SITE SECTIONS


1/8" = 1'-0"



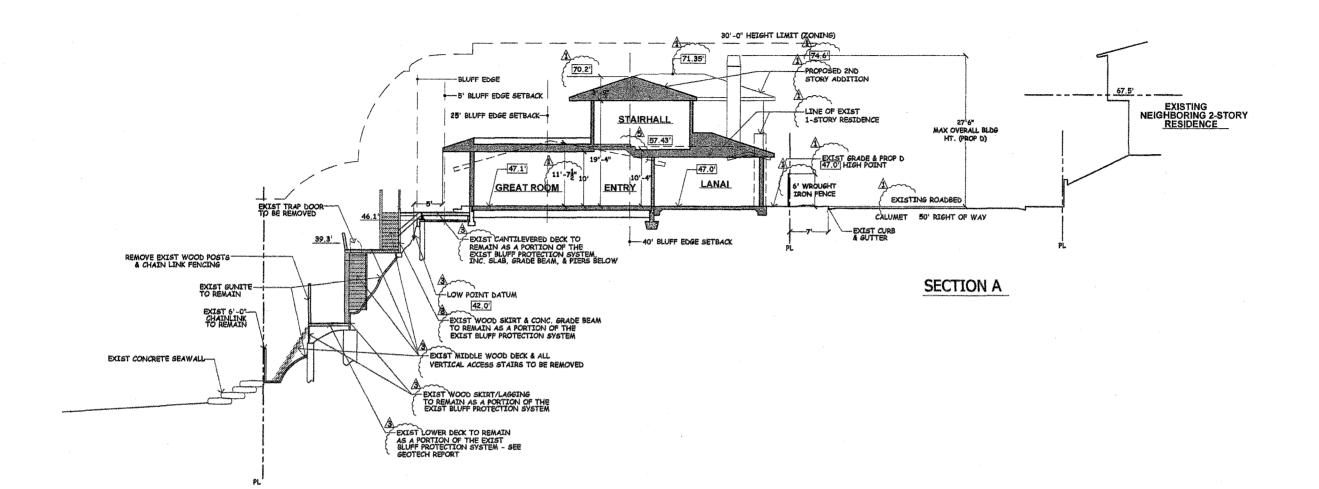

SECTION B (LOOKING EAST)

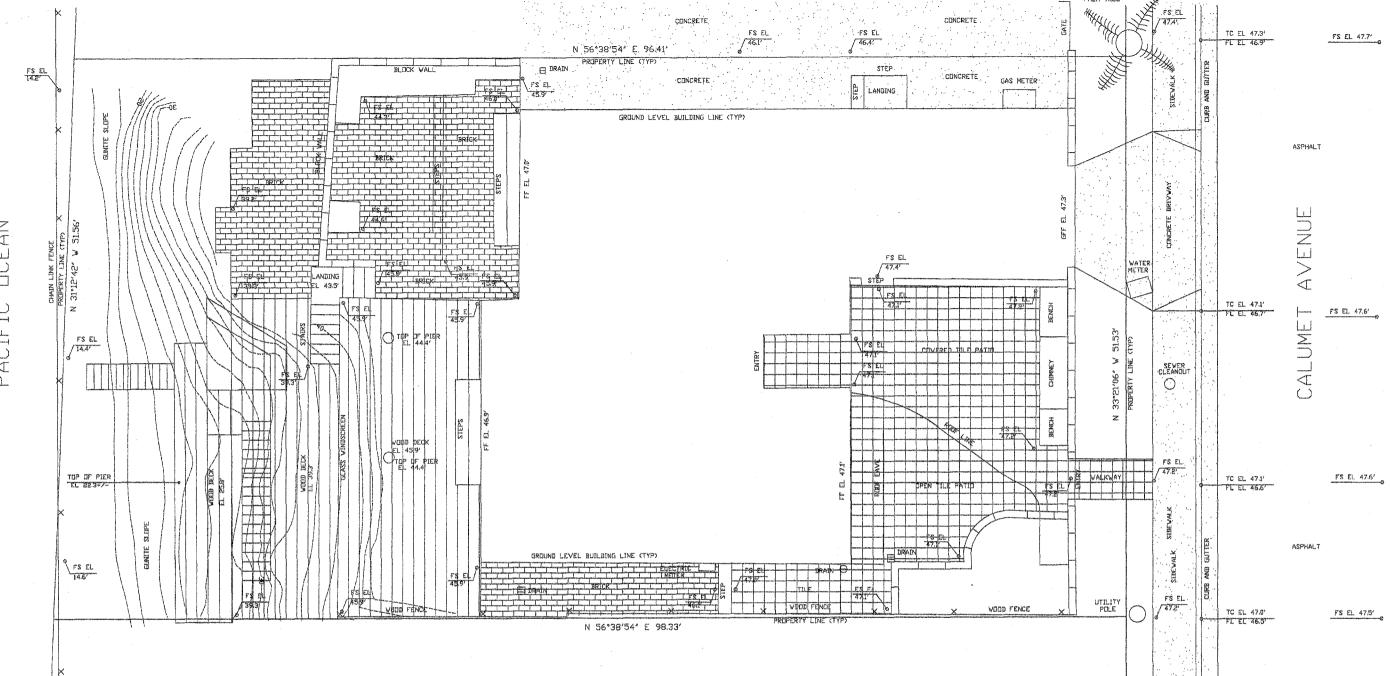

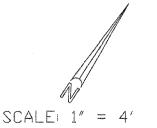

CONTOUR INTERVAL: 2'

CHRISTENSEN ENGINEERING & SURVEYING PLANNERS

CIVIL ENGINEERS 7888 SILVERTON AVENUE, TELEPHONE: (858)271-9901

LAND SURVEYORS SUITE 'J', SAN DIEGD, CALIFORNIA 92126

FAX: (858)271-8912

LEGAL DESCRIPTION

LOT 36 OF CLIFFSIDE, IN THE CITY OF SAN DIEGD, COUNTY OF SAN DIEGD, STATE OF CALIFORNIA, ACCORDING TO MAP THEREOF NO. 2799, FILED IN THE OFFICE OF THE COUNTY RECORDER OF SAN DIEGD COUNTY JULY 11, 1951.

BENCHMARK


CITY OF SAN DIEGO BENCHMARK BRASS PLUG LOCATED AT THE SOUTHWESTERLY CORNER OF CALUMET AVENUE AND FORWARD STREET, ELEVATION = 40.81' MEAN SEA LEVEL (N.G.V.D.

ABBREVIATIONS

ELEVATION
FINISH FLOOR
FLOW LINE
FINISH GRADE
FINISH SURFACE
GARAGE FINISH FLOOR
TOP OF CURB
TYPICAL

NOTES

- 1. EASEMENTS, AGREEMENTS, DOCUMENTS AND OTHER MATTERS WHICH AFFECT THIS PROPERTY MAY EXIST, BUT CANNOT BE PLOTTED. TITLE REPORT NOT PROVIDED.
- 2. THE PRECISE LOCATION OF UNDERGROUND UTILITIES COULD NOT BE DETERMINED IN THE FIELD, PRIDE TO ANY EXCAVATION UTILITY COMPANIES WILL NEED TO MARK-OUT THE UTILITY LOCATIONS.
- 3. THE ADDRESS FOR THE SUBJECT PROPERTY IS 5550 CALUMET AVENUE, LA JOLLA, CA 92037.
- 4. THE ASSESSOR PARCEL NUMBER FOR THE SUBJECT PROPERTY IS 357-521-06.
- 5. THE AREA OF THE SUBJECT PROPERTY IS 0.12 ACRES.

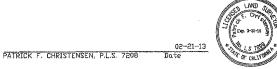

Prepared By

CHRISTENSEN ENGINEERING & SURVEYING 7888 SILVERTON AVENUE, SUITE *J* SAN DIEGO. CA 92126 PHONE (858)271-9901 FAX (858)271-8912

Project Address

5550 CALUMET AVENUE LA JOLLA, CA 92037

Revision 5:
Revision 4:
Revision 3:
Revision 2: 8-15-13 ADDED BLUFF TOPO
Revision 1: 4-4-13 CHANGED SCALE

Project Name:

MORSE RESIDENCE

Original Date: FEBRUARY 21, 2013

Sheet Title:

Sheet 4 Of 14

TOPOGRAPHIC MAP

JN 2013-05



BLUFF EDGE PLOT PLAN

"= 1'-0"


SHEET NO.

CDP 5.2.13 <u>A</u>9.10.13 ATTACHMENT 4

OF 14



5550 CALUMET, LA JOLLA CA

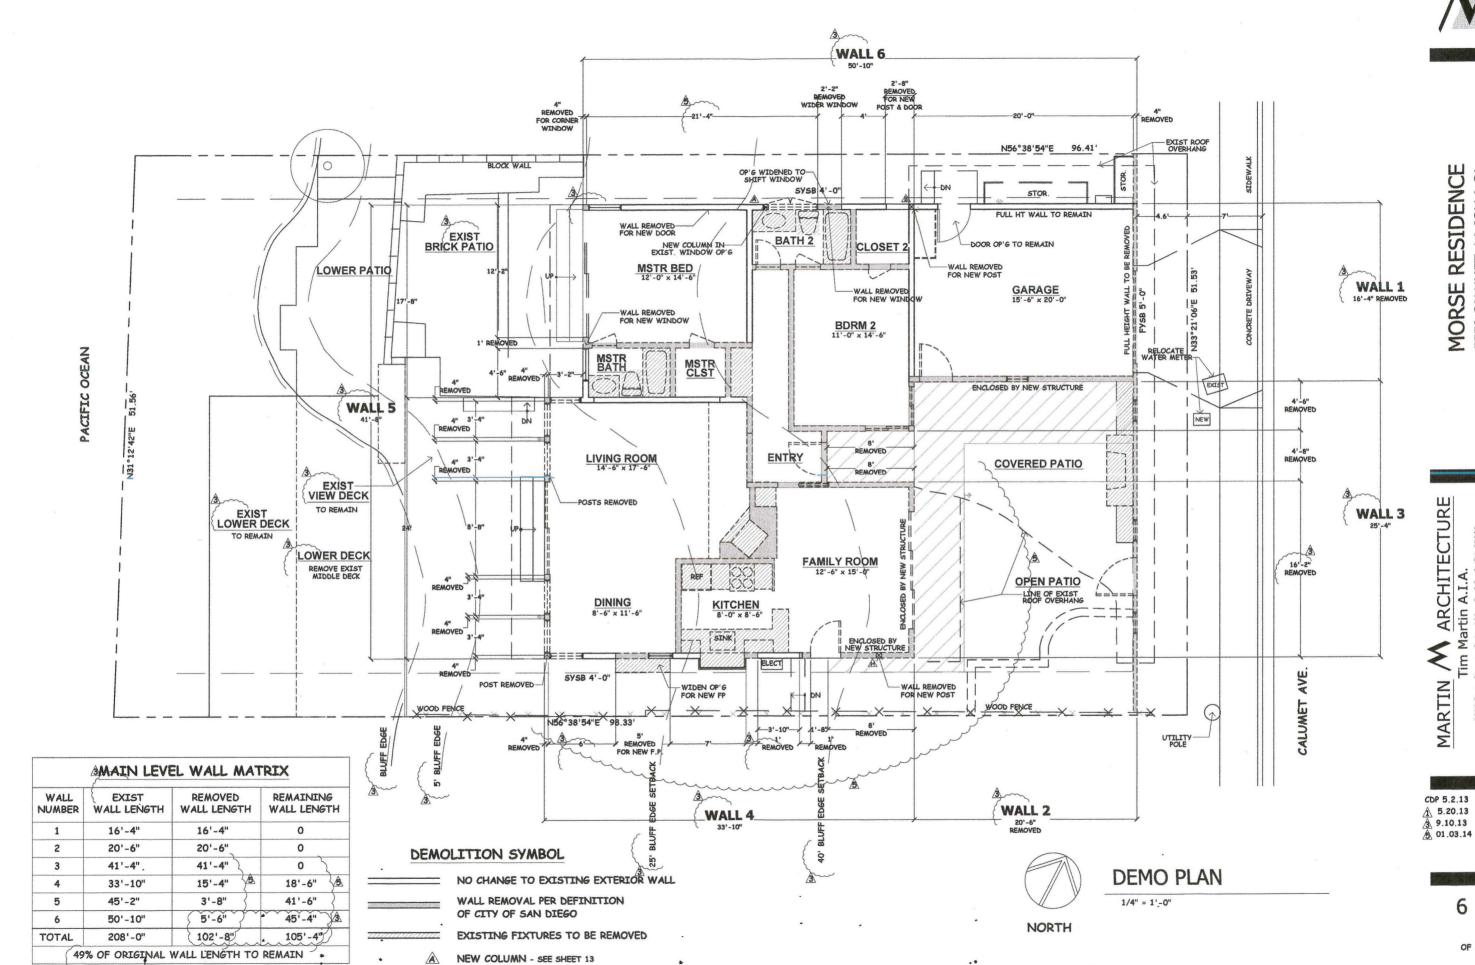


ATTACHMENT 4

OF 14

MORSE RESIDENCE 5550 CALUMET, LA JOLLA CA



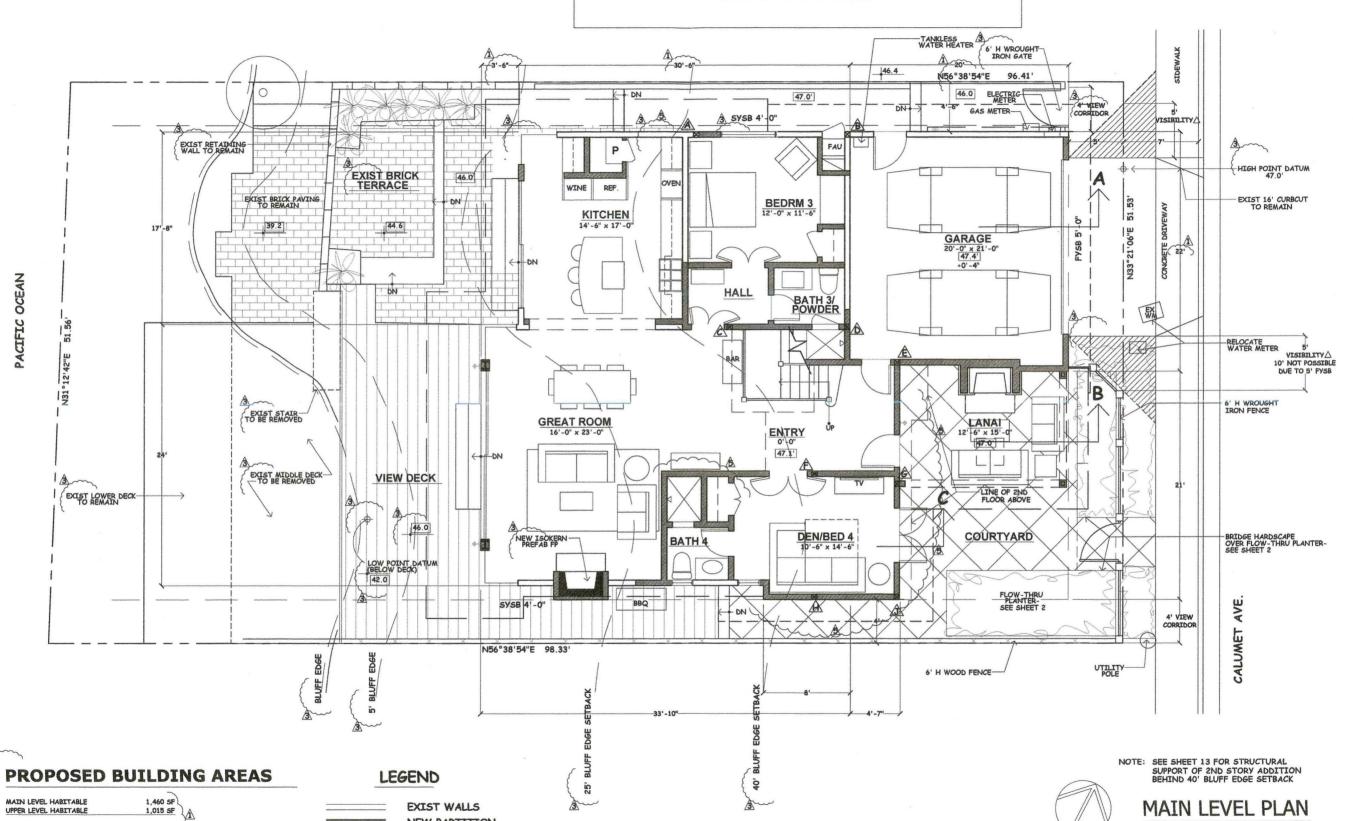

NEW PARTITION

NEW COLUMN - SEE SHEET 13

TOTAL HABITABLE

GARAGE COVERED LANAI (UNDER HAB.)

PROPOSED F.A.R. = 2,935 / 5,019 = .58

2,475 SF 435 SF

25 SF

2,935 SF (2,961 SF ALLOWED)

SHEET NO.

1/4" = 1'-0"

NORTH

CDP 5.2.13 1 5.20.13 § 9.10.13 § 01.03.14

A ARCHITECTURE
Tim Martin A.I.A.

eStreet Suite 100 Carlsbad, CA 92008
70(O) 760-729-3473 (F) 858-349-3474 (C)

MARTIN

OF 14

13'-2"

CLOSET

SHEET NO. 8

ATTACHMENT 4



MARTIN Martin A.I.A.

Tim Martin A.I.A.


2333 State Street Suite 100 Carlsbad, CA 92008
760-729-3470 (O) 760-729-3473 (F) 858-349-3474 (C)



UPPER LEVEL PLAN

1/4" = 1'-0"

NORTH

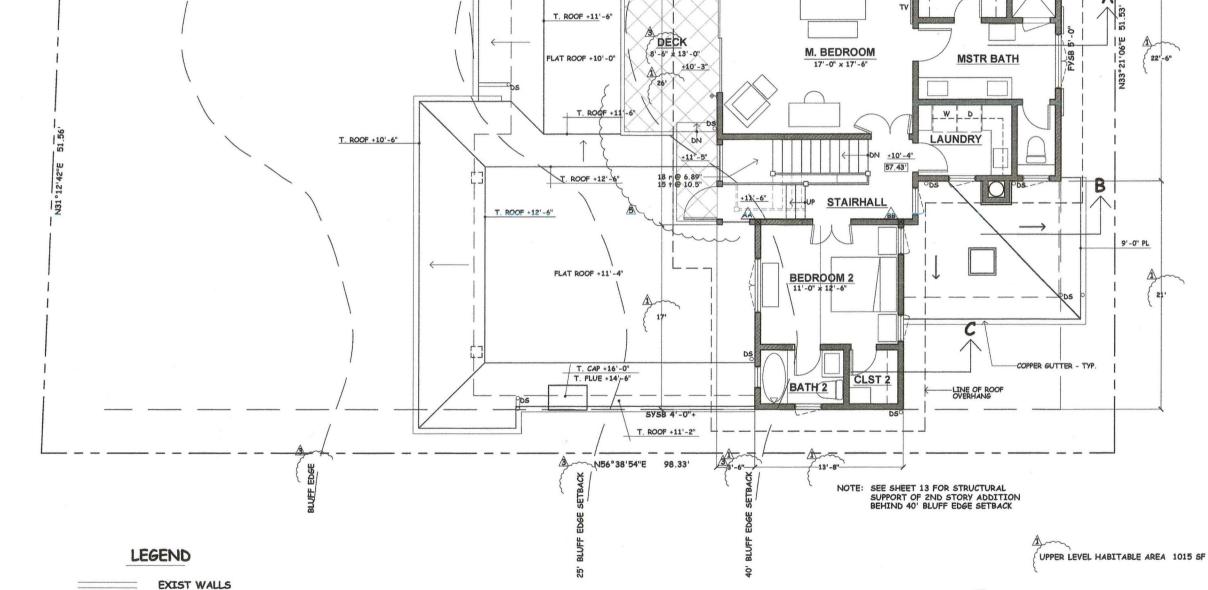

T. ROOF +11'-6"

T. ROOF + 9'-6"/

NEW PARTITION

NEW COLUMN - SEE SHEET 13








SHEET NO. 9


OF 14

ATTACHMENT

ELEVATIONS

1/4" = 1'-0"

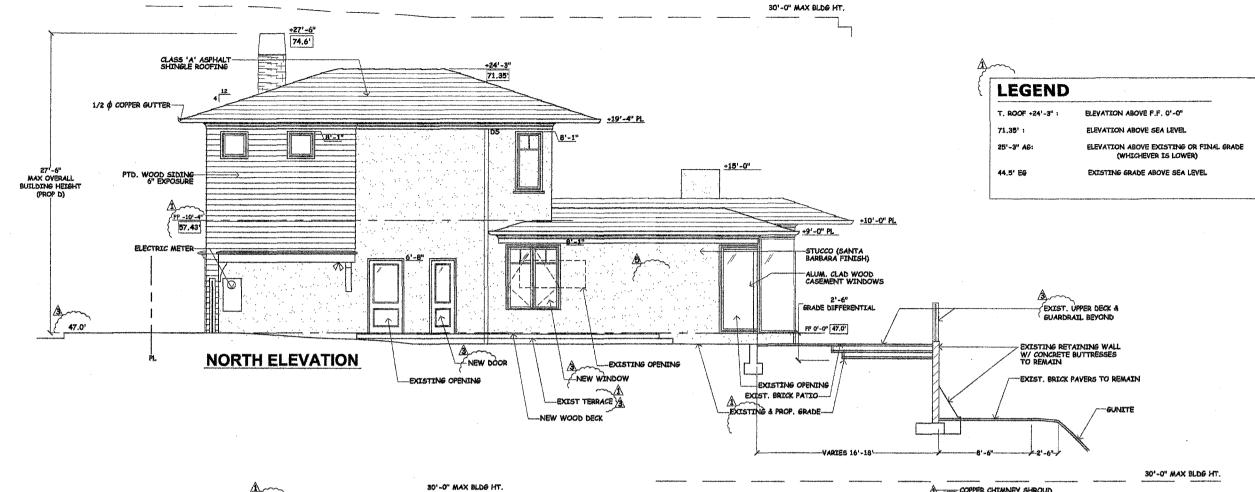

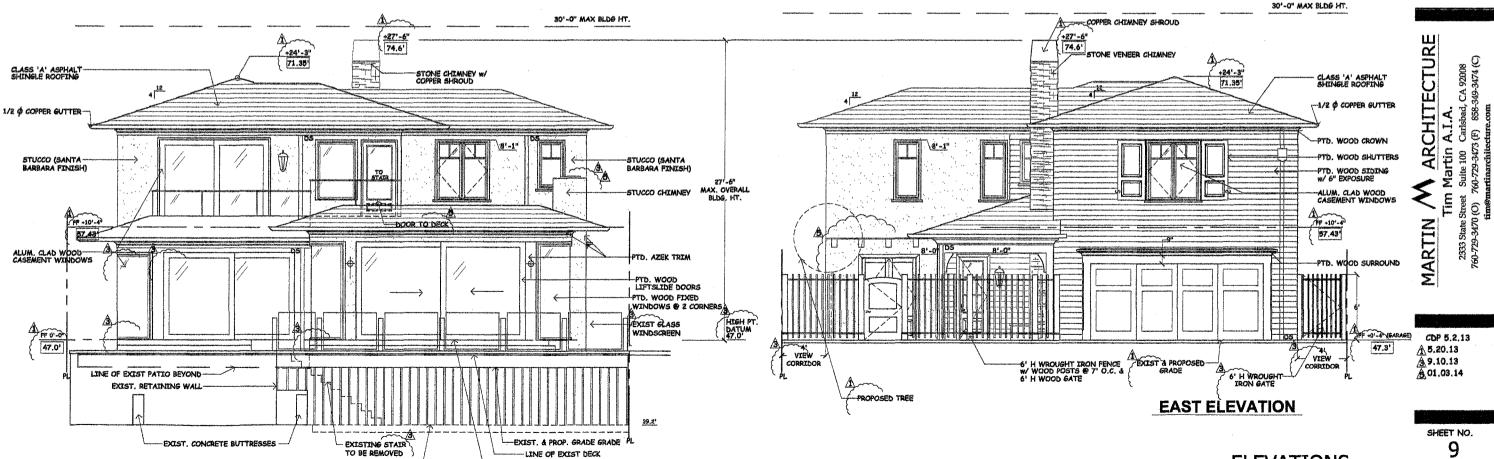

-LINE OF EXIST DECK


-ELEVATION OF NEW DECK

WEST ELEVATION

EXISTING MIDDLE DECK-TO BE REMOVED

ATTACHMENT 4



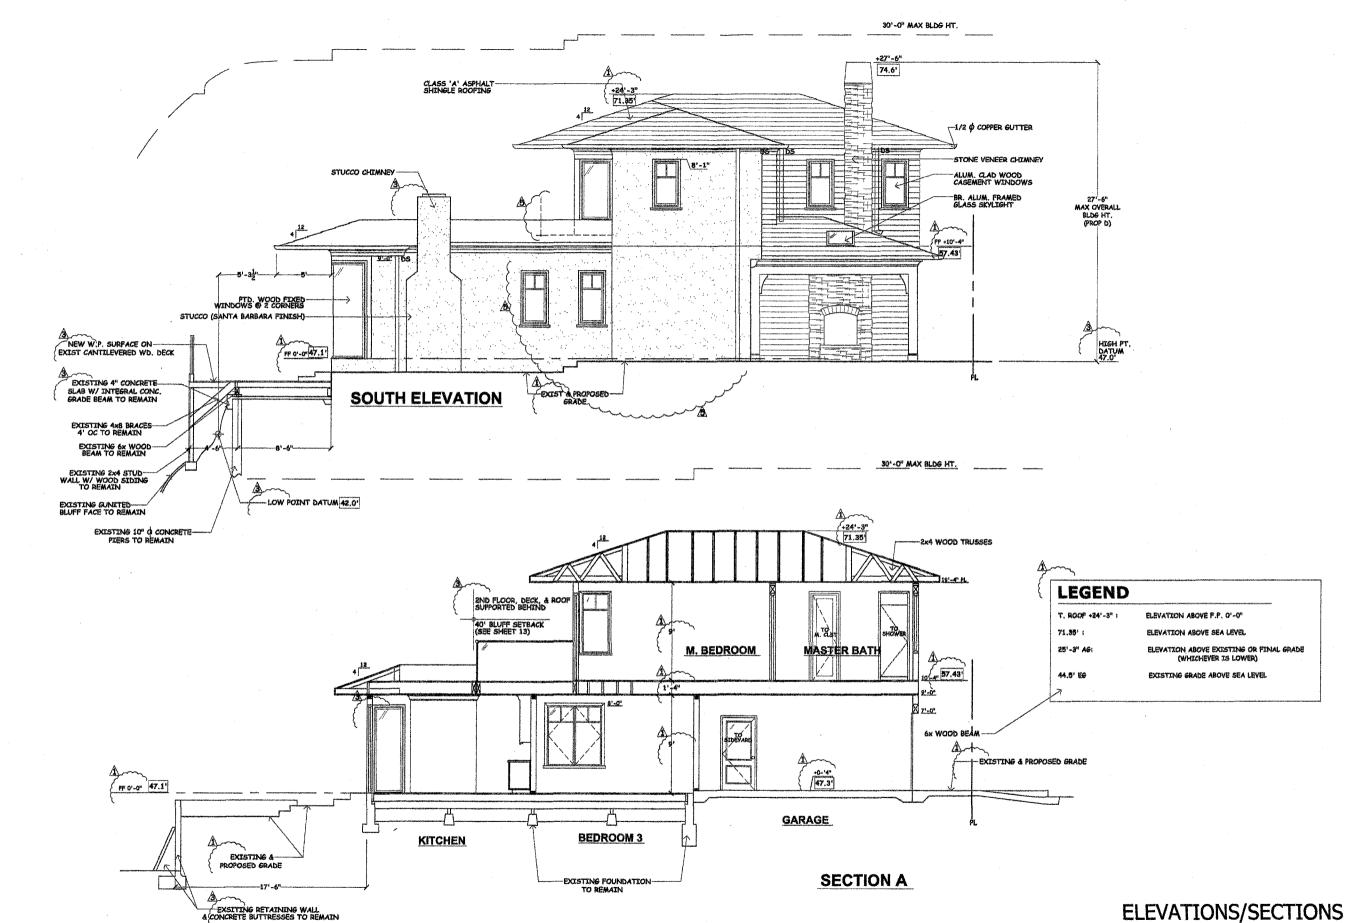



ELEVATIONS/SECTIONS

1/4" = 1'-0"

ATTACHMENT

SHEET NO. 11

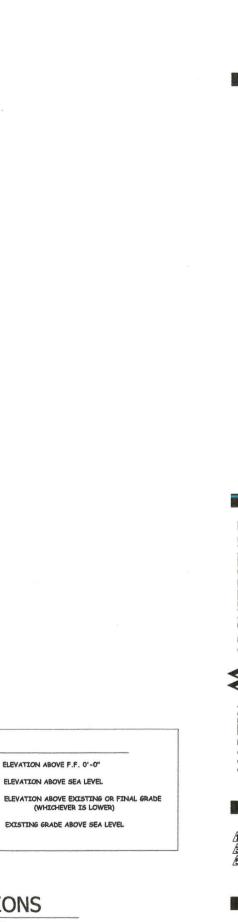

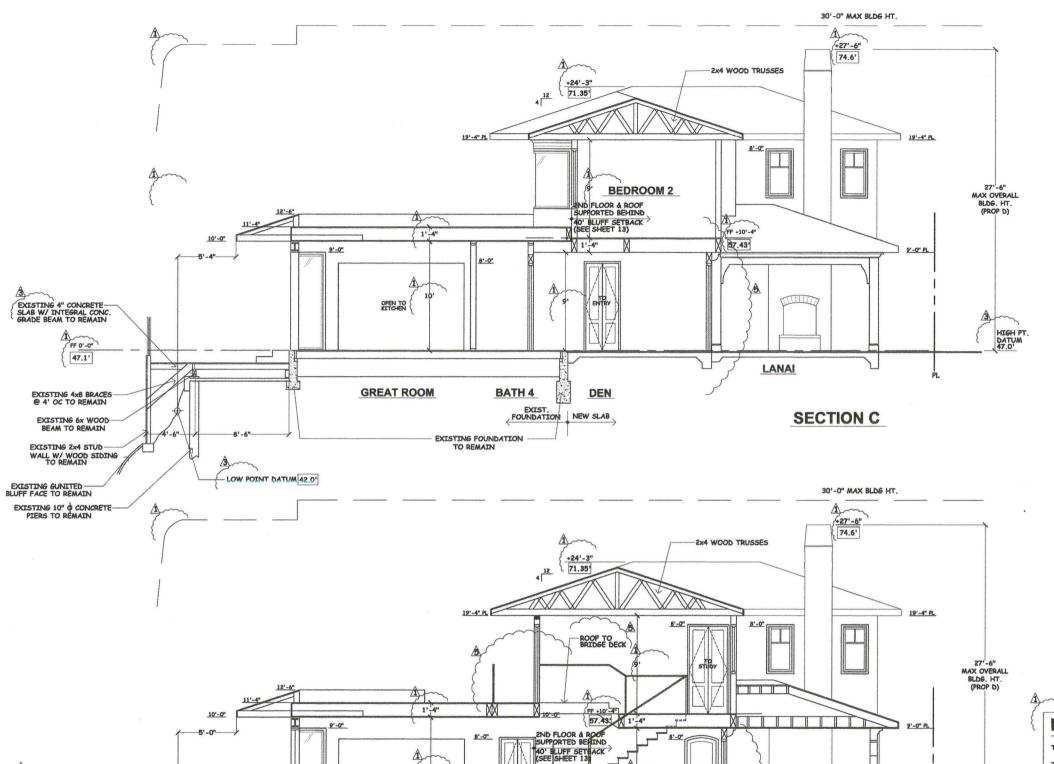

OPEN TO

GREAT ROOM

LEGEND

T. ROOF +24'-3" : 71.35' :

HIGH PT. DATUM 47.0'

LANAI

SECTION B

FOUNDATION | NEW SLAB

ELEVATION ABOVE SEA LEVEL

25'-3" AG: 44.5' EG

EXISTING GRADE ABOVE SEA LEVEL

SECTIONS

1/4" = 1'-0"

LOW POINT DATUM 42.0' EXISTING GUNITED—BLUFF FACE TO REMAIN EXISTING 10" \$\phi\$ CONCRETE-PIERS TO REMAIN

EXISTING 4" CONCRETE— SLAB W/ INTEGRAL CONC. GRADE BEAM TO REMAIN

EXISTING 4x8 BRACES

EXISTING 6x WOOD-BEAM TO REMAIN

EXISTING 2x4 STUD-WALL W/ WOOD SIDING TO REMAIN


FF 0'-0"


ATTACHMENT 4

SHEET NO.

12

ATTACHMENT

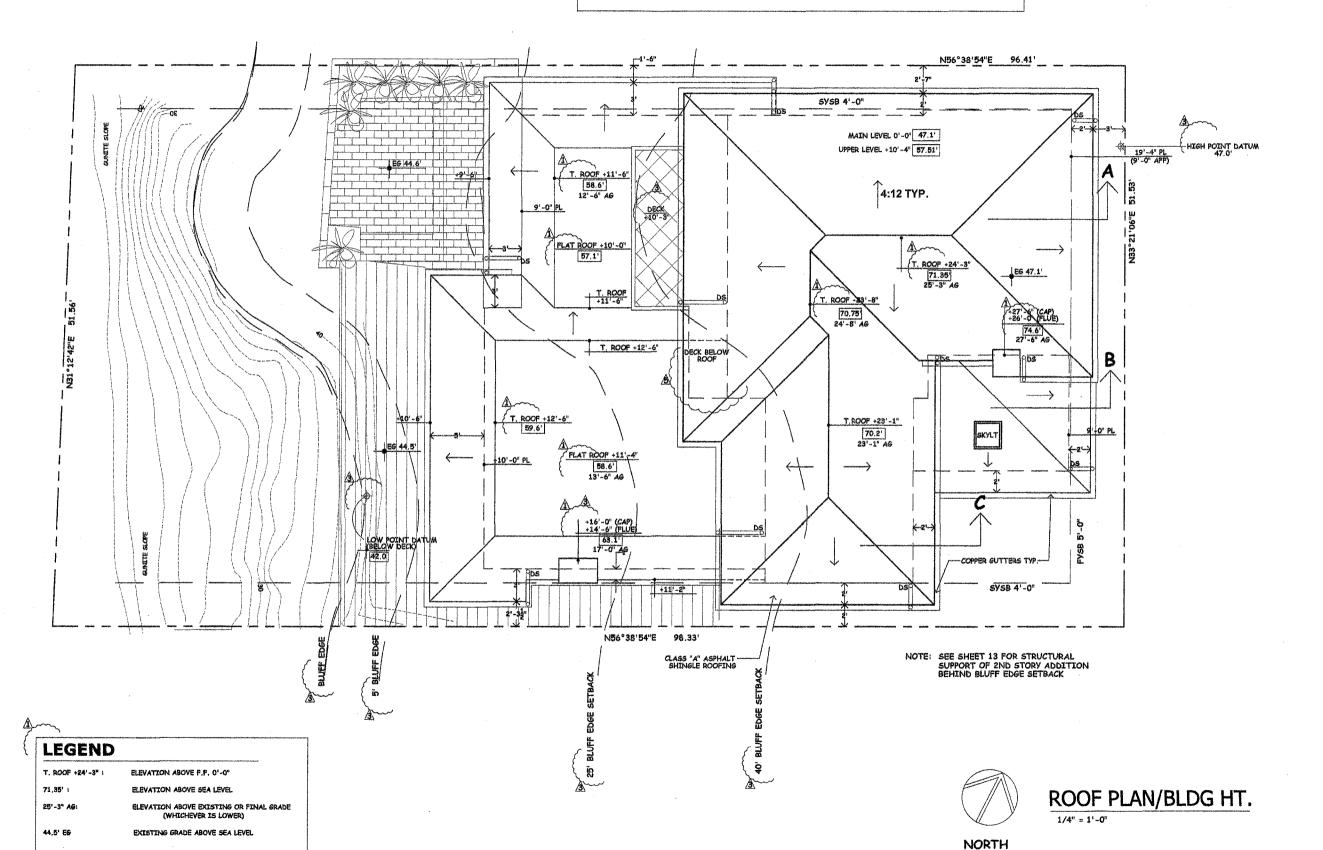

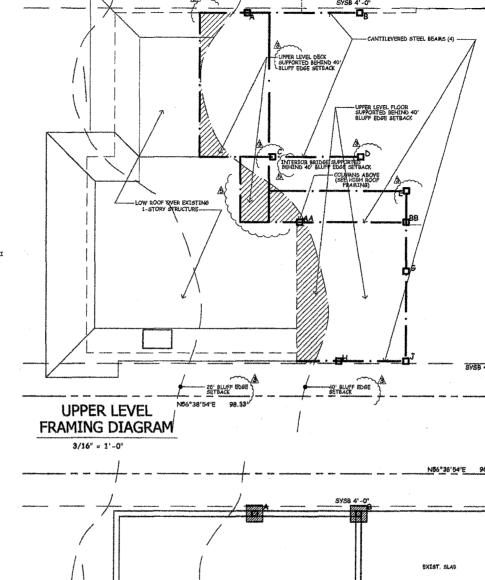

FOUNDATION/LOWER FLOOR FRAMING DIAGRAM

3/16" = 1'-0"



4.11.13 A 9.10.13 A 11.25.13 A 01.03.14

ALL LOADBEARING SUPFORT FOR THE PROPOSED NEW DEVELOPMENT SHALL BE LOCATED AT LEAST 40' LANDWARD OF THE COASTAL BLUFF EDGE.

NOTE: ALL CONSTRUCTION SUPPORTED BEHIND 40' BLUFF EDGE SETBACY

CONCEPTUAL FRAMING PLANS


3/16" = 1'-0"

NORTH

SHEET NO.

OF 14

13

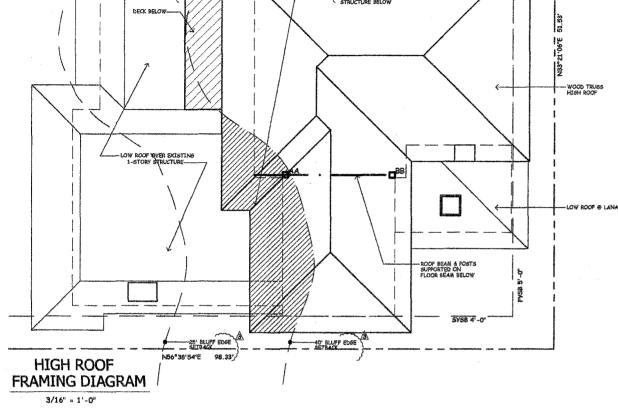

ARCHITECT

ATTACHMENT

LANDSCAPE DESIGN STATEMENT:

Provide a landscape that enhances the residential quality of Calumet, while specifying low-water and sea-tolerant plants. Using plants to soften the street-side façade, our goal was to bring living plant material to the deve

Objectives:

- 1. Consistent with the La Jolla PDO, low-water plants are specified.
- 2. Use plants that thrive in first exposure sea coast conditions.
- 3. Select plants that relate to human scale and enhance the experience of pedestrians and occupants.
- 4. Street tree to be consistent with La Jolla Street Tree recommendations for Zone 1.

LANDSCAPE & MAINTENANCE NOTES:

- The long term maintenance of the project shall be the responsibility of the owner. The landscape areas shall be maintained in a healthy growing condition. Diseased or dead plant material shall be satisfactorily treated or replaced per the conditions of the permit.
- All landscape and irrigation required by this permit shall conform to the City of San Diego's Landscape Requirements Section 142.0400, the Land Development Manual Landscape Standards, and all other landscape related city and regional standards.
- 3. All canopy trees shall be provided a minimum root zone of 40 s.f. in area.

IRRIGATION SYSTEM NOTES:

- All planting areas will be irrigated according to plant type and environmental exposure. Planting areas will receive complete water coverage by means of an automatically controlled, electronically operated, underground piped sprinkler system. Irrigation mainline piping shall be plastic (type 1220) schedule 40 or class 315 and class 200 or class 315 lateral lines. Lines will be installed at 18" deep for pressure lines and 12" deep for lateral lines.
- 2. Drip irrigation and low-emitting spray irrigation heads to be used.

ROOT BARRIER NOTES:

- 1. Root barrier type to be
- "Biobarrier" by Reemay Inc. (800) 284-2780.
- 2. Root barrers are not to be wrapped around root ball of tree.
- Non-biodegradeable root barriers shall be installed around all new street trees. Root barriers may be eliminated where the combination of tree species, soil type, soil area, and drainage conditions can be shown to afford equivalent protection against tree root damage to public improvements (LDC 142.0403).

LANDCSAPE CALCULATIONS


	Required:	Provided/Claimed:
Street Yard:		
Total Area:		746 s.f.
Planling Area:	373 s.f. (50% of total area)	354 s.f.
Excess Points Applied to Reduce Square Footage Requirements per SDCMC: 142.0405 (a) (3)	93 max. can be used (25%):	19 s.f.
Plent Points:	37 points (0.05 per total s.f.)	104 points
Points Achieved through Trees:	19 points (1/2 required points)	20 points
Remaining Yard:		
Total Area:		2486.5 s.f.
Planting Area:	40 s.f. (40 s.f. per (199)	92 s.f.
Plant Points:	60 points	205 points
Points Achieved through Trees:	75 points (1/2 required points)	100 points
Vehicular Use Area Within Street Yard:		
Total Area:		105 s.f.
Planting Area (under 6000 s.f.):	(40 s.f. per tree)	20 s.f.
Plant Points:	1 point (0.05 valicular use area)	18 points
Vehicular Use Area Outside Street Yard:		
Total Ares:		100 s.f.
Planting Area:	5 s.f.	40 s.f.
Plant Points:	5 points	12 points
Street Trees in Public Right-of-Way:		
Length of street Frontage:		52 feet
Street Trees:	1 (1 per avery 30 feet)	4

EXIST OF BRICK TERRACE,

IMPROVEMENT:	MINIMUM DISTANCE TO STREET TREE:
 Traffic Signal, Stop Sign	20 feet
 Underground Utility Lines	5 feet
Above Ground Utility Structure (Transformers, hydrants, utility poles, etc.)	10 feet
 Driveways	10 feet
 Intersections	25 feet

SYMBOL %	SIZE	BOTANICAL NAME/COMMON NAME	FORM/FUNCTION	SIZE AT MATURITY
TREES & PALMS		SUCH AS:	STREET TREE	
100%	24" box	METROSIDEROS EXCELSUS	N.Z.CHRISTMAS TREE	20' h. x 20' w.
		SUCH AS:	SMALL PATIO TREE	12' h. x 8' w.
100%	15 gal.	DRACAENA MARGINATA	MADAGASCAR TREE	
R	alt.	ALOE FEROX	NCN	
		SUCH AS:	ACCENT SHRUB	3' x 3'
SHRUBS (X)100%	5 gal.	EUPHORBIA TIRUCALLI 'STICKS ON FIRE'	STICKS ON FIRE	
. ~		SUCH AS:	SMALL ACCENT SHRUB	2' x 2'
	5 gal	ALOE PETRICOLA	STONE ALOE	
©33% 33%		AGAVE 'BLUE BOY' ALOE STRIATA	NCN	
&@ _{33%}	a gai		CORAL ALOE	all or
©100%	5 nai	SUCH AS: CRASSULA SPP.	JADE PLANT	3' h. x 3' w.
VINES & ESPALLIER	- g	SUCH AS:	TRELLIS VINE	•
100%	15 gal	MACFADYENA UNGUIS-CATI (ESPALIER: TRAIN ON WALL/FENCE)	CAT'S CLAWVINE	6' h. x 6' w,
GROUND COVER		SUCH AS:	GROUND COVER	
100%	1 gal	DYMONDIA MARGARETAE	SILVER CARPET	2" h. x 6" w.
EXISTING VEGETATION TREES	ON .			
(0) 100%	EXISTING	JUNIPERUS TORULOSA	TORULOSA JUNIPER	10' h. x 8' w. 4" calips
SHRUB				
(100%	EXISTING	CRASSULA SPP.	JADE PLANT	30" h, x 30" w.

LANDSCAPE DEVELOPMENT PLAN

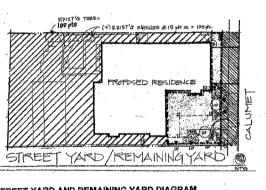


STREET YARD AND REMAINING YARD DIAGRAM

STREET YARD (746 S.F.)




REMAINING YARD (2486.5 S.F.)

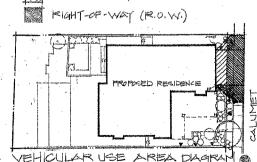

VEHICULAR USE AREA DIAGRAM

LEGEND:

VEHICULAR USE AREA: OUTSIDE STREET YARD (100 S.F.) VEHICULAR USE AREA: WITHIN STREET YARD (105 S.F.)

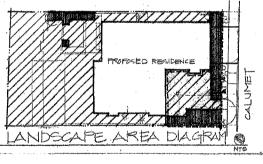

LANDSCAPE AREA DIAGRAM

LEGEND:



LANDSCAPE AREA PROVIDED INON- VEGETATED



STREET, JARD: VEGETATED = 354 S.F. NON-VEG .= 392 S.F.

REMAINING YARD: VEGETATED= 92 S.F. NON-VEG= 2394 5581

WALLS & PLANTER TO REMAIN A (1) EXIST' G SHRUBS TO REMAIN WHY (1) EXISTY JUNIPER-RANDOM STONE STAPPERS TOKENOW A"CALIPER KKON VISIBILITY TURF BLOCK AREA PER DRIVEWAY SOMC PROPOSED RESIDENCE LIMIT OF WORK **OVERED** LINE (LANDSCAPE) LANA! SEE ARCH DWGS RANDOM STONE -STEPPERS (LOUSE SET) FRONT WALL! - existig decks & FENCE (3 SOLID BLUFF STABILIZATION RELIGIENT POLE TO REMAIN (SEE ARCH, DAVOIS.)

RESIDENCE CALUME S MORSE RE 5550 CAI LA JOLLA, C swings scaled verify, verify, serv, eny end ings.

SCALE: 1/8" = 1' - 0"

SCALE: /8 =1-0

Sheet No.

L-1

HEARING OFFICER RESOLUTION NO. HO-XX-CCC SITE DEVELOPMENT PERMIT NO. 1130780 and COASTAL DEVELOPMENT PERMIT NO. 1131955 MORSE RESIDENCE PROJECT NO. 323667

WHEREAS, Robert J. Morse and Karen B. Morse, Owner/Permittee, filed an application with the City of San Diego for a permit to remodel an existing single family residence to allow an addition to the first floor and a new second-story for a total gross floor area of approximately 2,935 square feet (as described in and by reference to the approved Exhibits "A" and corresponding conditions of approval for the associated Permit Nos. 1130780 and 1131955), on portions of a 0.12 acre site;

WHEREAS, the project site is located at 5550 Calumet Avenue in the RS-1-7 zone in the La Jolla Community Plan area;

WHEREAS, the project site is legally described as Lot 36 of Cliffside, according to Map thereof No. 2799, filed July 11, 1951;

WHEREAS, on January 22, 2014, the Hearing Officer of the City of San Diego considered Site Development Permit No. 1130955 and Coastal Development Permit No. 1131955 pursuant to the Land Development Code of the City of San Diego;

WHEREAS, on December 16, 2013, the City of San Diego, as Lead Agency, through the Development Services Department, made and issued an Environmental Determination that the project is exempt from the California Environmental Quality Act (CEQA) (Public Resources Code section 21000 et. seq.) under CEQA Guideline Section 15301 and there was no appeal of the Environmental Determination filed within the time period provided by San Diego Municipal Code Section 112.0520;

NOW, THEREFORE, BE IT RESOLVED by the Hearing Officer of the City of San Diego as follows:

That the Hearing Officer adopts the following written Findings, dated January 22, 2014.

FINDINGS:

Site Development Permit - Section 126.0504

1. The proposed development will not adversely affect the applicable land use plan. The Morse Residence (Project) will allow an addition to the first floor and a new second-story floor for a total gross floor area of approximately 2,935 square feet. The La Jolla Community Plan (Plan) identifies the site for residential development. The Project is consistent with the designated use identified in the Plan. Further the Project will be consistent with the single family character of the existing neighborhood as perceived from the public right-of-way. The design of the home will be compatible with the appearance of the existing neighborhood and incorporate façade articulation and architectural details that will improve the aesthetic appeal of the structure when viewed from the street and from along the coast. The proposed home will not adversely affect any visitor-serving or recreational facility. No coastal scenic resources, recreational or visitor-serving facilities were identified on the project site. Therefore, no adverse impacts to such resources would occur as a result of project implementation. The project has been evaluated for

compliance with the adopted land use plan and determined to be consistent with the Plan. Through the review of the proposed project, the Project was determined by city staff to be consistent with the Plan's land use designation, the Plan's design guidelines and the development regulations of the RS-1-7 Zone. For these reasons, the Project will not adversely affect the La Jolla Community Plan. For additional information, also refer to Coastal Development Permit (CDP) Findings, Site Development Permit (SDP) Findings 2 and 3 and Supplemental Findings 1 through 6.

- 2. The proposed development will not be detrimental to the public health, safety, and welfare. The Morse Residence (Project) will allow an addition to the first floor and a new second-story floor for a total gross floor area of approximately 2,935 square feet. The Project will not be detrimental to public health, safety and welfare in that the permit controlling the development and continued use of the project for this site contains specific conditions addressing the project compliance with the City's codes, policies, regulations and other regional, state, and federal regulations to prevent detrimental impacts to the health, safety and general welfare of persons residing and/or working in the area. All Building, Fire, Plumbing, Electrical, Mechanical Code and City regulations governing the construction and continued operation of the development apply to this site to prevent adverse affects to those persons or other properties in the vicinity. Conditions of approval require compliance with several operational constraints, development controls and the review of all construction plans by professional staff to determine the proposed construction will comply with all regulations. Inspection of the proposed construction will assure construction will be implemented in accordance with the approved plans and the final construction will comply with all regulations and will assure the continued health, safety and general welfare of persons residing or working in the area. For additional information, also refer to CDP Findings, SDP 1 above and 3 below, and Supplemental Findings1 through 6.
- The proposed development will comply with the applicable regulations of the Land 3. **Development Code.** The Morse Residence (Project) will remodel an existing single family residence to allow an addition to the first floor and a new second-story floor for a total gross floor area of approximately 2,935 square feet. The Project neither requests nor requires the approval of any deviation or variance to allow the development of the Project as proposed. The front yard setback required for this property is determined by Map thereof No. 2799 filed July 11, 1951 and is established as five feet from the property line parallel to the public right-of-way. The Project is consistent with the established setback. The Project complies with all the development regulations of the RS-1-7 Zone and Environmentally Sensitive Lands Regulations which apply to this site. With the adoption of the permit conditions, the proposed addition and remodel of the single family structure will be in conformance with all relevant regulations including floor area ratio, setbacks, height, parking and all other relevant regulations. Conceptual plans submitted by the applicant have been reviewed by City staff and determined by City staff to be in compliance with all development regulations relevant to the site. No deviations or variance is required to approve the Project. Therefore, the proposed Project will comply with the applicable regulations of the Land Development Code. For additional information, also refer to CDP Findings, SDP Findings 1 and 2 above and Supplemental Findings Findings1 through 6.

B. Supplemental Findings--Environmentally Sensitive Lands

1. The site is physically suitable for the design and siting of the proposed development and the development will result in minimum disturbance to environmentally sensitive lands. The Morse Residence (Project) will allow an addition to the first floor and a new second-story floor for a total gross floor area of approximately 2,935 square feet. The project site is located between the first public roadway and the Pacific Ocean. The project site contains environmentally sensitive lands in the form of a sensitive coastal bluff. The applicant's geotechnical consultant submitted reports, Report of Geotechnical Investigation and Coastal Bluff Edge Evaluation, Morse Residential Project, 5550 Calumet Avenue, La Jolla, California, prepared by Geotechnical Exploration, Inc., dated April 22, 2013 (their project no. 11-10104), Update to Report of Geotechnical Investigation, Morse Residential Project, 5550 Calumet Avenue, La Jolla, California, prepared by Geotechnical Exploration, Inc., dated September 3, 2013 (their project no. 11-10104) and Shore/Bluff Protection and Bluff Improvement Inspection, and Wave Runup Discussion, 5550 Calumet Avenue, La Jolla, San Diego County, CA, prepared by GeoSoils, Inc., dated September 9, 2013 (their project no. S6590). The conclusions of these reports has been confirmed by city staff review and indicates the coastal bluff has a factor of safety greater than of 1.5, a recession rate of 0.1 foot per year and will be adequately stable throughout the 75-year life of the proposed development. The geotechnical reports for the proposed Morse Residence were reviewed and approved by a professional geologist employed by City of San Diego in the Development Services Department.

The Revised Drainage Study, dated September 10, 2013, prepared by Antony Christensen, Registered Civil Engineer, of Christensen Engineering, for the proposed Morse Residence was reviewed and approved by professional engineering staff. The project meets the Basic Objectives and Basic Policy on drainage design required by the City of San Diego Drainage Manual. The project manages increases in runoff discharge rates and durations that are likely to cause increased erosion, silt pollution generation or other impacts to beneficial uses and stream habitat due to increased erosive force. The applicant's consultant submitted a Water Quality Study, dated May 06, 2013, prepared by Antony Christensen, RCE of Christensen Engineering for the proposed Morse Residence was reviewed and approved by professional engineering staff. The Site Design Best Management Practices (BMPs) and Source Control BMPs analysis is adequate and adheres to the City of San Diego Storm Water Standards. The Water Quality Study was reviewed and approved by a professional engineer employed by City of San Diego in the Development Services Department.

No grading of the site is required to accommodate the proposed development. No sensitive coastal resources or environmentally sensitive areas will be disturbed by the proposed project.

No adjacent public parks or public recreational areas adjacent to and immediately surrounding the subject site would be adversely affected because the proposed development will occur on private property. No impacts to these resources would occur as a result of the development. The project as designed and conditioned will ensure the sensitive coastal bluff will not be adversely impacted.

Technical reports submitted by the applicant's consultants have demonstrated the site is physically suitable for the design and siting of the proposed development and the development will not result in a disturbance to environmentally sensitive lands. For additional information, also refer to CDP and SDP Findings and Supplemental Findings 2 through 6 below.

2. The proposed development will minimize the alteration of natural land forms and will not result in undue risk from geologic and erosional forces, flood hazards, or fire hazards. The Morse Residence (Project) will allow an addition to the first floor and a new second-story floor for a total gross floor area of approximately 2,935 square feet. The Project will utilize existing foundations to the greatest extent possible and will not grade the site except wherever necessary to excavate for new foundations. The existing home is located on a relatively flat building pad with an air-placed concrete covered steep coastal bluff on the western part of the property that leads to a shoreline erosion control devise and the rocky shoreline below. The site is located partially in Geologic Hazard Category 53, level or sloping terrain with unfavorable geologic structure, low to moderate risk, and partially in Geologic Hazard Category 47, coastal bluffs, generally stable with favorable geologic structure with minor or no erosion, according to the City of San Diego Maps.

The project site contains environmentally sensitive lands in the form of sensitive coastal bluffs. Currently, the bluff is protected with air-placed concrete and other shoreline protective devices that are permitted and were built between 1966 and 1973. Some of these features, specifically decks and stairs, do not serve as shoreline protection and the project proposes removal of those features pursuant to the recommendation of the La Jolla Community Plan, page 51, Section D. Further, conditions of approval included in Site Development Permit No. 1130955 and Coastal Development Permit No. 1131955 requires the removal of specific non-essential features currently west of the bluff edge provided that such removal will not result in damage to the coastal bluff, or otherwise adversely affect the functionality of the existing shoreline erosion control. Additionally the air-placed concrete will be colored to more naturally match the adjacent bluffs.

The proposed new structural foundations will observe a forty foot bluff edge setback as required by the regulations and recommended by the geologic investigation report. As such, the Project as designed and conditioned will ensure the sensitive coastal bluff will not be adversely impacted by the proposed development. In addition, all drainage will be directed away from the coastal bluff in order to reduce, control or mitigate erosion of, and other impacts from runoff to the coastal bluff and shoreline below as shown on the approved plans.

The project site has been previously graded as a result of construction of the existing structure and associated improvements on the property. No further grading of the site is necessary to implement the proposed additions and remodel.

The Project site is not located within the FW (Floodway) or FPF (Floodplain Fringe) zones and will not result in undue risk from flooding. The existing drainage system designed for the Project is consistent with requirements of the City Engineer and will minimize risks associated with runoff and erosion by directing all runoff into a drainage system and to the public right-of-way and away from the coastal bluff. The Project site does not contain and is not located adjacent to any natural vegetation which would pose a risk from wildfire and will not result in undue risk from fire hazards. The proposed Project will minimize the alteration of natural land forms and will not result in undue risk from geologic and erosional forces, flood hazards, or fire hazards. For additional information refer to CDP and SDP Findings, and Supplemental Findings 1 above and 3 through 6 below.

3. The proposed development will be sited and designed to prevent adverse impacts on any adjacent environmentally sensitive lands. The Morse Residence (Project) will allow an addition to the first floor and a new second-story floor for a total gross floor area of approximately 2,935 square feet. All new construction will occur on areas of the site which have been previously developed and will not

impact the adjacent coastal bluff face. No development will occur on the adjacent coastal bluff face. Therefore, the proposed development will be sited, designed and constructed to prevent adverse impacts on any adjacent environmentally sensitive lands. No adverse impacts on adjacent environmentally sensitive lands, including coastal bluffs, will occur as a result of the Project. For additional information refer to CDP and SDP Findings, and Supplemental Findings 1 through 2 above and 4 through 6 below.

- 4. The proposed development will be consistent with the City of San Diego's Multiple Species Conservation Program (MSCP) Subarea Plan. The Morse Residence (Project) will allow an addition to the first floor and a new second-story floor for a total gross floor area of approximately 2,935 square feet. The Project site is not within the Multi-Habitat Planning Area of the Multiple Species Conservation Program Subarea Plan and will have no effect upon the Multiple Species Conservation Program Subarea Plan. In this way the Project will be consistent with the City of San Diego's Multiple Species Conservation Program Subarea Plan. For additional information refer to CDP and SDP Findings, and Supplemental Findings 1 through 3 above and 5 through 6 below.
- 5. The proposed development will not contribute to the erosion of public beaches or adversely impact local shoreline sand supply. The Morse Residence (Project) will allow an addition to the first floor and a new second-story floor for a total gross floor area of approximately 2,935 square feet. All runoff from the site which occurs as a result of storm events, precipitation or any other rain producing events will be collected into a drain system and directed to the gutter or storm water system in the public right-of-way. No runoff from the site which occurs as a result of storm events, precipitation or any other rain producing events will be allowed down the face of the coastal bluff. In that all runoff from the site which occurs as a result of storm events, precipitation or any other rain producing events will be directed to a storm drain system, the Project will not contribute to the erosion of public beaches or adversely impact the local shoreline sand supply. For additional information refer to CDP and SDP Findings, and Supplemental Findings 1-4 above and 6 below.
- 6. The nature and extent of mitigation required as a condition of the permit is reasonably related to, and calculated to alleviate, negative impacts created by the proposed development. The Morse Residence (Project) will allow an addition to the first floor and a new second-story floor for a total gross floor area of approximately 2,935 square feet. The proposed project is exempt from the California Environmental Quality Act and no mitigation is required.

Coastal Development Permit - Section 126.0708

1. The proposed coastal development will not encroach upon any existing physical accessway that is legally used by the public or any proposed public accessway identified in a Local Coastal Program land use plan; and the proposed coastal development will enhance and protect public views to and along the ocean and other scenic coastal areas as specified in the Local Coastal Program land use plan. The Morse Residence (Project) will allow an addition to the first floor and a new second-story floor for a total gross floor area of approximately 2,935 square feet. The Project will be developed entirely within the private property and will not encroach upon any existing physical access way legally used by the public or any proposed public access way identified in a Local Coastal Program land use plan as there is no existing physical access way legally used by the public or any proposed public access ways located on the private property.

There are no existing physical accessways to the shoreline across the Project site. The La Jolla Community Plan does not identify any proposed public accessway across the site. As such, the proposed

coastal development will not encroach upon any existing physical accessway that is legally used by the public or any proposed public accessway identified in a Local Coastal Program land use plan.

There are no designated public views within the existing side yards. The project is designed and sited so as not to block or obstruct any view along the side yard setbacks. The side yard is required to be four feet wide and the property owner will be required to record two four-foot wide View Corridor Easements, as shown on Exhibit "A," in accordance with SDMC section 132.0403 along the southerly and northerly side property lines. The combined new views created through the private property will be eight feet in width. All fencing, landscaping, and other improvements in the view corridors will be restricted by recording the easement to assure the preservation of the public views towards the ocean. The Project will adhere to community goals, not to intrude into any of the identified public view corridors, in that no identified public view corridors are identified in the La Jolla Community Plan across the site. The Project will result in more viewing opportunities than what exists presently. The new views provided by the project in the north and south side yards will provide public views to the ocean beyond and prevent a walling off or other adverse effect to the community. The Project will not obstruct coastal or scenic views from any public vantage point. There will not be any increase in building footprint of the existing structure that will, from a public vantage point, result in public views blockage to and along the ocean. The ridge height of the second story addition will be twenty-four feet six inches high, which is below the maximum permitted height of thirty feet. Therefore, it has been concluded that implementation of the Project will not adversely obstruct public views to, or along the ocean or other scenic resources.

As such, the proposed coastal development will not encroach upon any existing physical access way that is legally used by the public or any proposed public access way identified in a Local Coastal Development Program Land Use Plan and the proposed coastal development will enhance and protect public views to and along the ocean and other scenic coastal areas as specified in the Local Coastal Program Land Use Plan. For additional information refer to Findings 2-4 below and SDP Findings above.


The proposed coastal development will not adversely affect environmentally sensitive lands. 2. The Morse Residence (Project) will allow an addition to the first floor and a new second-story floor for a total gross floor area of approximately 2,935 square feet. The proposed additions are not located on the portion of the property containing the sensitive coastal bluff. The Project site is located in urbanized area of the La Jolla Community Plan. The developed site does not contain sensitive biological resources. The site is not within or adjacent to the City's Multi-Habitat Planning Area. The proposed project site contains a sensitive coastal bluff which is an environmentally sensitive landform. The Project is designed in such a way so as to have no adverse effect upon the bluff and therefore the proposed project will not adversely affect environmentally sensitive lands. The project will comply with the relevant sensitive coastal regulations. All development will be confined to areas of the site which have been already disturbed by the previous development and use of the site and all load-bearing support for the proposed new development will be located forty-feet landward of the coastal bluff edge. The project as designed and conditioned will ensure the sensitive coastal bluff will not be adversely impacted by the proposed development. The new residence will conform with all applicable provisions of the Municipal Code and certified Local Coastal Program. No deviations or variances are requested or required to approve the Project. Therefore, the proposed development will not adversely affect environmentally sensitive lands. For additional information, refer to Findings 2, 3, 4 and 5 above.

- 3. The proposed coastal development is in conformity with the certified Local Coastal Program land use plan and complies with all regulations of the certified Implementation Program. The Morse Residence (Project) will allow an addition to the first floor and a new second-story floor for a total gross floor area of approximately 2,935 square feet. The project is located in an area identified in the La Jolla Community Plan as Low Density Residential designated for residential uses at a range of 5-9 dwelling units per acre. The proposed residence would be consistent with the land use and would conform to all the requirements of the RS-1-7 zone, the La Jolla Community Plan and Local Coastal Program Land Use Plan. The proposed project will be consistent with the goals identified by the La Jolla Community Plan and Local Coastal Program Land Use Plan for residential development. The proposed structure is designed to achieve a harmonious visual relationship between the bulk and scale of the existing and the adjacent structures. The proposed project would be consistent with the recommended land use, design guidelines, and development standards in effect for the subject property per the adopted La Jolla Community Plan, the Environmentally Sensitive Lands regulations, the City's certified Local Coastal Program, and the City of San Diego's Progress Guide and General Plan, which recommend the subject property be developed with single-family residential development in accordance with development regulations of the existing RS-1-7 zone. The proposed project will comply with all applicable provisions of the Municipal Code and certified Local Coastal Program and deviations or variances are not requested. Therefore, the proposed development is in conformity with the City's certified Local Coastal Program Land Use Plan and any other applicable adopted plans and programs in effect for this site. For additional information, refer to Finding 1 through 2 above and 4 below, and SDP Findings above.
- 4. For every Coastal Development Permit issued for any coastal development between the nearest public road and the sea or the shoreline of any body of water located within the Coastal Overlay Zone the coastal development is in conformity with the public access and public recreation policies of Chapter 3 of the California Coastal Act. The Morse Residence (Project) will allow an addition to the first floor and a new second-story floor for a total gross floor area of approximately 2,935 square feet. The proposed development will have no impact on the public's ability to access coastal areas open to the public and will have no impact upon the public recreation policies of Chapter 3 of the California Coastal Act. The western most portion of the property is a very high nearly vertical coastal bluff without any improved access from the top of the bluff to the shoreline and ocean below. The La Jolla Community Plan identifies access to the shoreline from other locations in the neighborhood and not across the subject property. No coastal access is identified by the La Jolla Community Plan from this site. Therefore, the coastal development is in conformity with the public access and public recreation policies of Chapter 3 of the California Coastal Act. For additional information, refer to CDP Finding 1 through 3 above.

BE IT FURTHER RESOLVED that, the Hearing Office hereby acknowledges the CEQA Exemption and based on the testimony at the hearing and the various reports, studies and correspondence in the public record, and based on the findings hereinbefore adopted by the Hearing Officer, Site Development Permit No. 1130780 and Coastal Development Permit No. 1131955 is hereby GRANTED by the Hearing

Officer to the referenced Owner/Permittee, in the form, exhibits, terms and conditions as set forth in Permit Nos. 1130780 and 1131955, a copy of which is attached hereto and made a part hereof.

John S. Fisher
Development Project Manager
Development Services

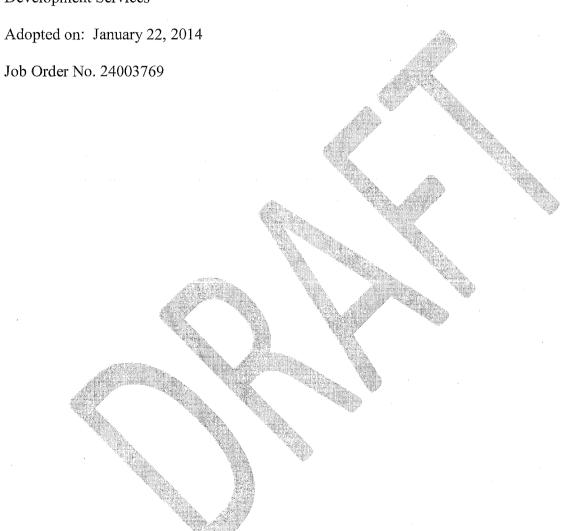

RECORDING REQUESTED BY

CITY OF SAN DIEGO DEVELOPMENT SERVICES PERMIT INTAKE, MAIL STATION 501

WHEN RECORDED MAIL TO PROJECT MANAGEMENT PERMIT CLERK MAIL STATION 501

SPACE ABOVE THIS LINE FOR RECORDER'S USE

INTERNAL ORDER NUMBER: 24003769

SITE DEVELOPMENT PERMIT NO. 1130780 and COASTAL DEVELOPMENT PERMIT NO. 1131955 MORSE RESIDENCE PROJECT NO. 323667 HEARING OFFICER

This Site Development Permit No. 1130780 and Coastal Development Permit No. 1131955 is granted by the Hearing Officer of the City of San Diego to Robert J. Morse and Karen B. Morse, Husband and Wife as Community Property with right of Survivorship, Owner/Permittee, pursuant to San Diego Municipal Code [SDMC] sections 126.0504 and 126.0708. The 0.12-acre site is located at 5550 Calumet Avenue in the RS-1-7 Zone of the La Jolla Community Plan area. The project site is legally described as Lot 36 of Cliffside, according to Map thereof No. 2799, filed July 11, 1951.

Subject to the terms and conditions set forth in this Permit, permission is granted to Owner/Permittee to remodel an existing single family residence to allow an addition to the first floor and a new second-story floor for a total gross floor area of approximately 2,935 square feet described and identified by size, dimension, quantity, type, and location on the approved exhibits [Exhibit "A"] dated [INSERT Approval Date], on file in the Development Services Department.

The project shall include:

- a. Remodel an existing single family residence to allow an addition to the first floor and a new second-story floor for a total gross floor area of approximately 2,935 square feet;
- b. Landscaping (planting, irrigation and landscape related improvements):
- c. Off-street parking:

d. Public and private accessory improvements determined by the Development Services Department to be consistent with the land use and development standards for this site in accordance with the adopted community plan, the California Environmental Quality Act [CEQA] and the CEQA Guidelines, the City Engineer's requirements, zoning regulations, conditions of this Permit, and any other applicable regulations of the SDMC.

STANDARD REQUIREMENTS:

- 1. This permit must be utilized within thirty-six (36) months after the date on which all rights of appeal have expired. If this permit is not utilized in accordance with Chapter 12, Article 6, Division 1 of the SDMC within the 36 month period, this permit shall be void unless an Extension of Time has been granted. Any such Extension of Time must meet all SDMC requirements and applicable guidelines in effect at the time the extension is considered by the appropriate decision maker. This permit must be utilized by [ENTER DATE including the appeal time].
- 2. This Coastal Development Permit shall become effective on the eleventh working day following receipt by the California Coastal Commission of the Notice of Final Action, or following all appeals.
- 3. No permit for the construction, occupancy, or operation of any facility or improvement described herein shall be granted, nor shall any activity authorized by this Permit be conducted on the premises until:
 - a. The Owner/Permittee signs and returns the Permit to the Development Services Department; and
 - b. The Permit is recorded in the Office of the San Diego County Recorder.
- 4. While this Permit is in effect, the subject property shall be used only for the purposes and under the terms and conditions set forth in this Permit unless otherwise authorized by the appropriate City decision maker.
- 5. This Permit is a covenant running with the subject property and all of the requirements and conditions of this Permit and related documents shall be binding upon the Owner/Permittee and any successor(s) in interest.
- 6. The continued use of this Permit shall be subject to the regulations of this and any other applicable governmental agency.
- 7. Issuance of this Permit by the City of San Diego does not authorize the Owner/Permittee for this Permit to violate any Federal, State or City laws, ordinances, regulations or policies including, but not limited to, the Endangered Species Act of 1973 [ESA] and any amendments thereto (16 U.S.C. § 1531 et seq.).

- 8. The Owner/Permittee shall secure all necessary building permits. The Owner/Permittee is informed that to secure these permits, substantial building modifications and site improvements may be required to comply with applicable building, fire, mechanical, and plumbing codes, and State and Federal disability access laws.
- 9. Construction plans shall be in substantial conformity to Exhibit "A." Changes, modifications, or alterations to the construction plans are prohibited unless appropriate application(s) or amendment(s) to this Permit have been granted.
- 10. All of the conditions contained in this Permit have been considered and were determined-necessary to make the findings required for approval of this Permit. The Permit holder is required to comply with each and every condition in order to maintain the entitlements that are granted by this Permit.

If any condition of this Permit, on a legal challenge by the Owner/Permittee of this Permit, is found or held by a court of competent jurisdiction to be invalid, unenforceable, or unreasonable, this Permit shall be void. However, in such an event, the Owner/Permittee shall have the right, by paying applicable processing fees, to bring a request for a new permit without the "invalid" conditions(s) back to the discretionary body which approved the Permit for a determination by that body as to whether all of the findings necessary for the issuance of the proposed permit can still be made in the absence of the "invalid" condition(s). Such hearing shall be a hearing de novo, and the discretionary body shall have the absolute right to approve, disapprove, or modify the proposed permit and the condition(s) contained therein.

The Owner/Permittee shall defend, indemnify, and hold harmless the City, its agents, officers, and employees from any and all claims, actions, proceedings, damages, judgments, or costs, including attorney's fees, against the City or its agents, officers, or employees, relating to the issuance of this permit including, but not limited to, any action to attack, set aside, void, challenge, or annul this development approval and any environmental document or decision. The City will promptly notify Owner/Permittee of any claim, action, or proceeding and, if the City should fail to cooperate fully in the defense, the Owner/Permittee shall not thereafter be responsible to defend, indemnify, and hold harmless the City or its agents, officers, and employees. The City may elect to conduct its own defense, participate in its own defense, or obtain independent legal counsel in defense of any claim related to this indemnification. In the event of such election, Owner/Permittee shall pay all of the costs related thereto, including without limitation reasonable attorney's fees and costs. In the event of a disagreement between the City and Owner/Permittee regarding litigation issues, the City shall have the authority to control the litigation and make litigation related decisions, including, but not limited to, settlement or other disposition of the matter. However, the Owner/Permittee shall not be required to pay or perform any settlement unless such settlement is approved by Owner/Permittee.

ENGINEERING REQUIREMENTS:

12. The project proposes to export no material from the project site. Any excavated material that is exported, shall be exported to a legal disposal site in accordance with the Standard

Specifications for Public Works Construction (the "Green Book"), 2009 edition and Regional Supplement Amendments adopted by Regional Standards Committee.

- 13. The drainage system proposed for this development, as shown on the site plan, is private and subject to approval by the City Engineer.
- 14. Prior to foundation inspection, the Owner/Permittee shall submit a building pad certification signed by a Registered Civil Engineer or a Licensed Land Surveyor, certifying the pad elevation based on USGS datum is consistent with the approved Exhibit "A", satisfactory to the City Engineer.
- 15. Prior to the issuance of any building permits, the Owner/Permittee shall assure, by permit and bond, the existing driveway will be reconstructed with a twelve-foot wide current City Standard SDG-162 Concrete Driveway for Confined Right-of-Way adjacent to the site on Calumet Avenue, satisfactory to the City Engineer.
- 16. Prior to the issuance of any construction permit, the Owner/Permittee shall enter into a Maintenance Agreement for the ongoing permanent BMP maintenance, satisfactory to the City Engineer.
- 17. Prior to the issuance of any construction permit, the Owner/Permittee shall incorporate any construction Best Management Practices necessary to comply with Chapter 14, Article 2, Division 1 (Grading Regulations) of the San Diego Municipal Code, into the construction plans or specifications.
- 18. Prior to the issuance of any construction permit the Owner/Permittee shall submit a Water Pollution Control Plan (WPCP). The WPCP shall be prepared in accordance with the guidelines in Appendix E of the City's Storm Water Standards.

GEOLOGY REQUIREMENTS:

Prior to the issuance of any construction permits, the Owner/Permittee shall submit a geotechnical investigation report that specifically addresses the proposed construction plans. The geotechnical investigation report shall be reviewed for adequacy by the Geology Section of Development Services. All load-bearing support for the proposed new development shall be located at least 40-feet landward from the coastal bluff edge.

LANDSCAPE REQUIREMENTS:

19. Prior to issuance of any construction or Building or Grading Permit, complete landscape and irrigation construction documents consistent with the Landscape Standards shall be submitted to the Development Services Department for approval. The construction documents shall conform to the approved Exhibit "A." Construction plans shall provide and identify a forty square foot area around each tree which is unencumbered by hardscape and utilities as set forth under LDC 142.0403(b)5.

- 20. Prior to Final Inspection, it shall be the responsibility of the Owner/Permittee to install all required landscape and obtain all required landscape inspections.
- 21. The Owner/Permittee shall be responsible for the maintenance of all landscape improvements shown on the approved plans, including in the right-of-way, consistent with the Landscape Standards unless long-term maintenance of said landscaping will be the responsibility of a Landscape Maintenance District or other approved entity.
- 22. All required landscape shall be maintained in a disease, weed and litter free condition at all times. Severe pruning or "topping" of trees is not permitted unless specifically noted in this Permit.
- 23. If any required landscape, including existing or new plantings, hardscape, landscape features, or other landscape improvements, indicated on the approved construction document plans is damaged or removed during demolition or construction, it shall be repaired and/or replaced in kind and equivalent size per the approved documents to the satisfaction of the Development Services Department within thirty days of damage or Certificate of Occupancy.

PLANNING/DESIGN REQUIREMENTS:

- 24. Owner/Permittee shall maintain a minimum of two off-street parking spaces on the property at all times in the approximate locations shown on the approved Exhibit "A." Parking spaces shall comply at all times with the SDMC and shall not be converted for any other use unless otherwise authorized by the appropriate City decision maker in accordance with the SDMC.
- 25. A topographical survey conforming to the provisions of the SDMC may be required if it is determined, during construction, that there may be a conflict between the building(s) under construction and a condition of this Permit or a regulation of the underlying zone. The cost of any such survey shall be borne by the Owner/Permittee.
- 26. Prior to the issuance of any construction permits, the Owner/Permittee shall execute and record a Covenant of Easement which ensures preservation of the Environmentally Sensitive Lands that are outside the allowable development area on the premises as shown on Exhibit "A" for Sensitive Coastal Bluffs, in accordance with SDMC section 143.0152. The Covenant of Easement shall include a legal description and an illustration of the premises showing the development area and the Environmentally Sensitive Lands as shown on Exhibit "A."
- 27. Prior to the issuance of any construction permits, the Owner/Permittee shall record two four–foot wide View Corridor Easements, as shown on Exhibit "A," in accordance with SDMC section 132.0403.
- 28. Prior to the issuance of any construction permits, the Owner/Permittee shall execute a Notice of Hazardous Condition-Indemnification and Hold Harmless Agreement for Sensitive Coastal Bluffs in accordance with SDMC section 143.0143, in a form and content acceptable to the Director of the Development Services Department, or designated representative, which shall

provide: (a) that the Owner/Permittee understands that new accessory structures or landscape features customary and incidental to residential uses are prohibited within 5 feet of the Coastal Bluff Edge or on the face of the Bluff, as illustrated on approved plan Exhibit "A;" (b) that the Owner/Permittee understands that the site may be subject to extraordinary hazard from coastal bluff erosion, and the Owner/Permittee assumes all liability from such hazards; and (c) the Owner/Permittee unconditionally waives any claim of liability against the City of San Diego and agrees to defend, indemnify, and hold harmless the City of San Diego and its advisors relative to the City of San Diego's approval of the project and for any damage due to natural hazards. This Notice of Hazardous Conditions-Indemnification and Hold Harmless Agreement shall be recorded against title to the property and shall run with the land, binding upon all successors and assigns.

- 29. All private outdoor lighting shall be shaded and adjusted to fall on the same premises where such lights are located and in accordance with the applicable regulations in the SDMC.
- 30. Proposed at grade accessory structures and landscape features customary and incidental to residential uses shall not be closer than five feet to the coastal bluff edge, in accordance with the requirements of the Land Development Code.
- 31. Open fencing and landscaping may be permitted within the visual corridor, provided such improvements do not significantly obstruct public views of the ocean. Landscape within this visual corridor shall be planted and maintained not exceed three feet in height in order to preserve public views.
- 32. All private improvements located westerly of the top of the bluff that are shown to be removed on the approved Exhibit "A" shall be done without damaging the coastal bluff. It shall be the responsibility of the Owner/Permittee to properly remove and dispose of any and all debris resulting from such removal.

INFORMATION ONLY:

- The issuance of this discretionary use permit alone does not allow the immediate commencement or continued operation of the proposed use on site. The operation allowed by this discretionary use permit may only begin or recommence after all conditions listed on this permit are fully completed and all required ministerial permits have been issued and received final inspection.
- Any party on whom fees, dedications, reservations, or other exactions have been imposed
 as conditions of approval of this Permit, may protest the imposition within ninety days of
 the approval of this development permit by filing a written protest with the City Clerk
 pursuant to California Government Code-section 66020.

• This development may be subject to impact fees at the time of construction permit issuance.

APPROVED by the Hearing Officer of the City of San Diego on[INSERT Approval Date] and [Approved Resolution Number].



Permit Type/PTS Approval No.: SDP No. 1130780 and SDP No. 1131955 Date of Approval:


AUTHENTICATED BY THE CITY OF SAN DIEGO DEVELOPMENT SERVICES DEPARTMENT

John S. Fisher

Development Project Manager

NOTE: Notary acknowledgment must be attached per Civil Code section 1189 et seq.

The undersigned Owner/Permittee, by execution hereof, agrees to each and every condition of this Permit and promises to perform each and every obligation of Owner/Permittee hereunder.

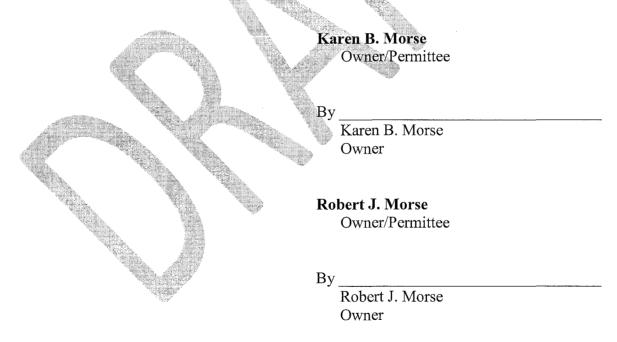

NOTE: Notary acknowledgments must be attached per Civil Code section 1189 et seq.

NOTICE OF EXEMPTION

TO:	X RECORDER/COUNTY CI P.O. BOX 1750, MS A-1 1600 PACIFIC HWY, RO SAN DIEGO, CA 92101	33 оом 260	FROM:	CITY OF SAN DIEGO DEVELOPMENT SERVICES DEPARTMENT 1222 FIRST AVENUE, MS 501 SAN DIEGO, CA 92101
	Office of Planning at 1400 Tenth Street, Ro Sacramento, CA 958	оом 121		
PROJECT NO	.: 323667	PROJECT TITLE: Morse R	Lesidence C	DP/SDP
PROJECT LO	CATION-SPECIFIC: 5550 Calu	ımet Avenue, La Jolla, CA 92	2037	
PROJECT LO	CATION-CITY/COUNTY: San I	Diego/San Diego		
(SDP) to ren story addition Overlay zone Bluffs, Parki	nodel an existing 2,010 square n, and reconstruct an existing e (Appealable), Coastal Heigh	e-foot, one-story single famil g wood deck on a 0.12-acre si ht and Sensitive Coastal Over ial Tandem Parking Overlay,	y residence te. The pro rlay, Enviro Geologic I	T PERMIT (CDP) and SITE DEVELOPMENT PERMIT, construct a 925 square-foot first and second eject is located within the RS-1-7 zone, Coastal enmentally Sensitive Lands — Sensitive Coastal Hazard Categories 12, 47 and 53, Transit Area ouncil District 1.
NAME OF PU	BLIC AGENCY APPROVING PR	OJECT: City of San Diego		
NAME OF PE	RSON OR AGENCY CARRYING	OUT PROJECT: Robert Morse	e, 59 26 th S	t. NW, Atlanta, GA 30309. (703) 981-8961.
() M () Di () EM	TUS: (CHECK ONE) INISTERIAL ECLARED EMERGENCY MERGENCY PROJECT ATEGORICAL EXEMPTION: SEC	ction 15301: existing facil	ITIES	
CEQA Guide the floor area	lines. Section 15301 allows a	additions to existing structure dition. None of the exception	es that woul	t from CEQA pursuant to Section 15301 of d not result in more than a 50 percent increase of CEQA Guidelines Section 15003.2 apply,
LEAD AGENC	Y CONTACT PERSON: M. Bla	ke	TE	LEPHONE: (619) 446-5375
2. HA	PPLICANT: FACH CERTIFIED DOCUMENT C S A NOTICE OF EXEMPTION BE YES () NO		NCY APPRO	VING THE PROJECT?
IT IS HEREBY	CERTIFIED THAT THE CITY OF	SAN DIEGO HAS DETERMINEI	O THE ABOV	E ACTIVITY TO BE EXEMPT FROM CEQA
SIGNATURE/S	H July ENIOR PLANNER	<u></u>		January 8, 2014 date
CHECK ONE:				3
	Y LEAD AGENCY 7 APPLICANT	Date Re	ECEIVED FO	R FILING WITH COUNTY CLERK OR OPR:

PROJECT DATA SHEET		
PROJECT NAME: Morse Residence		
PROJECT DESCRIPTION:	Renovation and addition to single family structure.	
COMMUNITY PLAN AREA:	La Jolla	
DISCRETIONARY ACTIONS:	Site Development Permit & Coastal Development Permit	
COMMUNITY PLAN LAND USE DESIGNATION:	Low Density Residential	

ZONING INFORMATION:

ZONE: RS-1-7

HEIGHT LIMIT: 30 foot maximum height limit.

LOT SIZE: 5,000 square-foot minimum lot size.

FLOOR AREA RATIO: 0.59

FRONT SETBACK: Established setback of 5 feet per Map No. 2799.

SIDE SETBACK: 4 feet. STREETSIDE SETBACK: NA

REAR SETBACK: 13 feet.

PARKING: 2 parking spaces required.

ADJACENT PROPERTIES:	LAND USE DESIGNATION & ZONE	EXISTING LAND USE
NORTH:	Low Density Residential/ RS-1-7	Single family residential
SOUTH:	Low Density Residential/ RS-1-7	Single family residential
EAST:	Low Density Residential/ RS-1-7	Single family residential
WEST:	Pacific Ocean	
DEVIATIONS OR VARIANCES REQUESTED:	None proposed.	
COMMUNITY PLANNING GROUP RECOMMENDATION:	The La Jolla Community Planning Association voted 12:1:1 on November 7, 2013, to recommend approval of the project	



LA JOLLA COMMUNITY PLANNING ASSOCIATION

P.O. Box 889 La Jolla CA 92038 Ph 858.456.7900 http://www.LaJollaCPA.org Email: Info@LaJollaCPA.org

Regular Meeting - 7 November 2013

Attention: John Fisher, PM

City of San Diego

Project:

Morse Residence

5550 Calmet Ave.

PN: 323667

Motion:

To accept the recommendations of the DPR Committee:

Vote: 12-1-1

12 November 2013

Findings can be made to recommend a Coastal

Development Permit and Site Development Permit to construct an addition at the first and second stories, and

reconstruct existing wood deck 6-0-1

Submitted Tony Crisafi, President

Date

by:

La Jolla CPA



City of San Diego **Development Services** 1222 First Ave., MS-302 San Diego, CA 92101 (619) 446-5000

Ownership Disclosure Statement

			· · · · · · · · · · · · · · · · · · ·
Approval Type: Check appropr	iate box for type of approval (s) request	ed: 「Neighborhood Use Pe	rmit Coastal Development Permit
Neighborhood Development Variance Tentative Map	Permit Site Development Permit Vesting Tentative Map Map Wa	Planned Development Pe aiver Land Use Plan Amen	rmit Conditional Use Permit dment · Conditional Use
Project Title			Project No. For City Use Only
•	residence		323667
Project Address:			
5550 (CAlumet, Las	olla CA	
		0,.00	
Part I - To be completed who	en property is held by Individual(s)	
	ure Statement, the owner(s) acknowled		
			cumbrance against the property. Please list
			de the names and addresses of all persons , tenants who will benefit from the permit, all
ndividuals who own the property). A signature is required of at least on	e of the property owners. Att	ach additional pages if needed. A signature
rom the Assistant Executive Dire	ctor of the San Diego Redevelopment	Agency shall be required for al	I project parcels for which a Disposition and
			cant is responsible for notifying the Project
			 Changes in ownership are to be given to to provide accurate and current ownership
nformation could result in a delay		ino busious proporty. Tunato	to provide addition and dailon ownership
And affect of the control of the con	purces V Samed V		
Additional pages attached	Yes No		
Name of Individual (type or p	rint):	Name of Individual (typ	e or print):
Robert 3	T. Morre	KARer	B Morre
Owner Tenant/Lesse			/Lessee Redevelopment Agency
Street Address: 33 HH Pe	active Rd #350	Street Address: 3344	Peachtree Rd #3501
City/State/Zip: Hanta	GA 30326	City/State/Zip:	ta 6A 30326
Phone No: 203 981 8	961 Fax No:	Phone No: 203 615	5 4750 Fax No:
Signature:	_ Date: 1/7/13	Signature	Date: 4/7/13
Name of Individual (type or p	rint):	Name of Individual (typ	e or print):
Owner Tenant/Lessee	Redevelopment Agency	Owner Tenant/I	essee Redevelopment Agency
Street Address:		Street Address:	
City/State/Zip:		City/State/Zip:	
Phone No:	Fax No:	Phone No:	Fax No:
Signature :	Date:	Signature :	Date: