

4909 Pacific Highway, San Diego, CA 92110 Cannabis Outlet (CO) and Cannabis Production Facility (CPF) Conditional Use Permits



2934 Lincoln Ave., San Diego, CA 92104
techno-us.com sustainablarchitect.org
o 619-940-5814 m 313-595-5814

CONSULTANTS

01-11-2023



4909 Pacific Highway,
San Diego, CA 92110
OWNER
RAP Holdings, LLC & United Partners,
LLC



PROJECT INFORMATION		Pacific Highway CO
PROJECT ADDRESS:	4909 Pacific Highway San Diego, CA 92110	
ASSESSORS PARCEL NUMBER:	436-44-22-00	
LEGAL DESCRIPTION:	Portions of LOT 272 of the Pueblo Lands of San Diego, County of San Diego, State of California, according to Map thereof made by James Pascoe in may 1870, a copy of which said Map was filed in the Office of the County Recorder of San Diego County, November 14, 1921 and is known as Miscellaneous Map No. 36. Abuttee's right of ingress and egress to or from State Highway have been relinquished in the Document recorded November 20, 1951 in Book 4295, Page 345 and October 1, 1951 in Book 4249, Page 370, both of Official Records. An Easement and rights incidental thereto as granted in a document. In favor of the San Diego Gas and Electric Company for the purpose of public utilities, ingress and egress, Recorded, May 14, 1945, Book 1376 and Page 88, of Official Records affecting a portion of said land.	
YEAR BUILT:	1953	
APPROVED OCCUPANCY CLASSIFICATION:	F-1 - Moderate-hazard Factory Industrial / S-1 Moderate-hazard Storage	
PROPOSED OCCUPANCY CLASSIFICATION:	B - Business / M - Mercantile	
APPROVED USE:	Cannabis Production Facility / Warehouse	
PROPOSED USE:	Cannabis Outlet	
CONSTRUCTION TYPE:	TYPE - VA (Sprinklered)	
NUMBER OF STORIES:	1	
BUILDING HEIGHT:	18' - 4" (no change)	
LOT AREA:	44,511.7 S.F. 1.02 ACRES	

GROSS FLOOR AREA (Project Suite):	464.18 sf	(Proposed Cannabis Outlet; Suite A)
GROSS FLOOR AREA (Remainder):	32,365.32 sf	(Amended Cannabis Production Facility; Suite B)
TOTAL BUILDING GROSS FLOOR AREA:	32,829.5 sf	

ZONING INFORMATION		Pacific Highway CO
BASE ZONE:	IL-3-1	
Overlay Zones:	San Diego Unified School District (SDUSD), Community Plan Implementation Overlay Zone - A, City Coastal Overlay (COZ) - N-APP-2, Transit Priority Area (TPA), San Diego International Airport - Airport Influence Area (AIA), Council District 2, Airports: FAA Height Notification, Community Plan - LINDA VISTA, Parking Standards Transit Priority Area, Mobility Zone 5, Geological Hazard Category 31, Parking Impact Overlay (PIOZ).	
Geological Hazard Categories:	31	
NUMBER OF BUILDINGS:	1	
SETBACKS:		
FRONT:	15'-0" (min)	20'-0" (std.)
SIDE:	10'-0" (min)	
REAR:	0'-0" (min)	15'-0" (std.)
MAX. STRUCTURE HEIGHT:	30'-0"	
MAXIMUM FLOOR AREA RATIO:	2.0	89,023 sf
ACTUAL FLOOR AREA RATIO:	0.7	32,829.5 sf

PARKING CALCULATION			
Use	Area (sq ft)	Ratio	Parking Stalls
Cannabis Outlet (Project Suite A)	464.18	4.30	Per 1,000 S.F.
Amended Cannabis Production Facility (Suite B)	32,365.32	1	1 Per Employee
Total Parking Required			12
Total Building Gross Floor Area	32,829.5		

Proposed Carpool / Vanpool Parking (On Site)	Req. Parking Spaces	Ratio	Parking Spaces
SDMC 142.0530(i)(1)(B)(ii)	12	10 to 25	2.0
Total Carpool / Vanpool Spaces Required *			2
Proposed Electric Vehicle Charging Spaces (On Site)	Req. Parking Spaces	Ratio	Parking Spaces
CGESC Table 5.106.5.3.3	12	10 to 25	4.0
Total Electric Vehicle Charging Stations Required *			4
Proposed Motorcycle Spaces (On site)	Req. Parking Spaces	Ratio	Parking Stalls
2% of Reg. Automobile Parking (Min. Req. = 2)	12	0.02	0.2
Total Motorcycle Spaces Required *			2
Proposed Bicycle Spaces (Short Term)	Area (sq ft)	Ratio	Bicycle Spaces
10% per 1,000 sq ft of building area (Min. Req. = 2)	32,829.5	0.10	3.3
Total Short term Bicycle Spaces Required			3
Proposed Bicycle Spaces (Long Term)	Req. Parking Spaces	Ratio	Parking Stalls
5% of Reg. Automobile Parking (Min. Req. = 1)	12	0.05	0.6
Total Long term Bicycle Spaces Required			1

APPROVED PARKING PER CUP-#2066720 & BP-#0678882	Number / Area (sq ft)	Ratio	Parking Stalls
Parking Spaces	32,829.5		12
Accessible Spaces (On Site)	1-25 per 118-6	0.00	1
Bicycle Parking (On Site) (1 Long Term and 3 Short Term)	0.0	0.00	4
Motorcycle Parking (On site)	0.0	0.00	2
TOTAL		0.37	12

Ratio Parking per approved CUP: #2066720 and Building Permit: #0678882	Number / Area (sq ft)	Ratio	Parking Stalls
Parking Spaces (On Site)	0.0		12
Carpool / Vanpool Parking (On Site)	0.0		2
Electric Vehicle Parking (On Site)	5.0		3
Van Accessible Spaces (On Site)	12.0		1
Short-Term Bicycle Parking (On Site)	0.0		3
Long-Term Bicycle Parking (On Site)	12.0		2
Motorcycle Parking (On site)	12.0		2
Loading Dock (On site)	-		1
TOTAL			21


VEHICULAR PARKING SUMMARY - Proposed Project			
	Standard Parking	Electric Vehicle	Van Accessible Spaces
TOTAL	7	4	1

SHEET INDEX

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APPLICABLE CODES	
•	City of San Diego Municipal Code
•	2022 California Building Code
•	2022 California Green Code
•	2022 California Plumbing Code
•	2022 California Electrical Code
•	2022 California Mechanical Code

SCOPE OF WORK	PROJECT TEAM
Project consists of a Conditional Use Permit (CUP) in order to partially convert an existing single-story industrial building with an approximate area of 32,829.5sf into a 464.18sf Cannabis Outlet (Suite A). The project proposes an amendment to the previously approved Marijuana Production Facility CUP (#2066720) to reduce an approximate area of 464.18sf and convert into a 32,365.32sf Cannabis Production Facility (CPF) (Suite B).	<p>OWNER: RAP Holdings, LLC & United Partners, LLC, Contact: Jon Lyons 3843 Observation Pl., Escondido, CA 92025 Email: jonlyons@rap.com</p> <p>PERMIT HOLDER (APPLICANT): Adam Knopf 7734 Herschel Ave. #L, La Jolla, CA 92037 Phone: 619.886.4251</p> <p>DESIGN FIRM: TECHNE Project Contact: Abhay Schweitzer - Assoc. AIA 2934 Lincoln Ave., San Diego, CA 92104 Phone: 619.940.5814, email: abhay@techno-us.com</p> <p>ARCHITECT: Michael Rene Morton C-19371 2934 Lincoln Ave., San Diego, CA. 92104 Phone: 619.857.8144 Email: m.morton.blueskydesign@gmail.com</p> <p>CIVIL ENGINEER: Snipes-Dye Associates Contact: Son P. Nguyen, R.C.E 86249 8348 Center Drive, Suite G, La Mesa, CA. 91942 Phone: 619.697.9234</p> <p>LANDSCAPE ARCHITECT: Sam Wade Landscape Architect - CA Lic. #3703 2204 Garnet Ave., San Diego CA. 92109 Phone: 858.270.8688, email: samw@samwadelandscapearchitect.com</p>
<ul style="list-style-type: none"> Interior Improvements Include: <ul style="list-style-type: none"> Reconfiguration of interior walls to create new Cannabis Outlet space. Minor Site Improvements Include: <ul style="list-style-type: none"> Bicycle parking configuration and striping Additional Electrical Vehicle charging stations. <p>Approved Cannabis Production Facility for reference: CUP: #2066720 Building Permit #: PTS-0678882 ROW Permit #: PTS-0669821</p>	

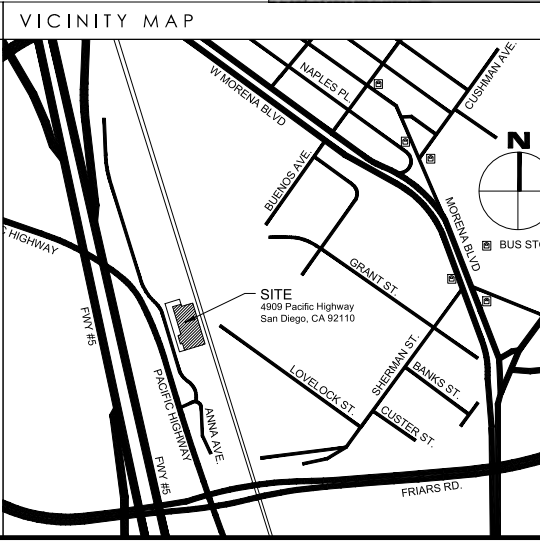

MARK	DATE	DESCRIPTION
01	09.06.22	Completeness Review Submittal
02	12.13.22	Conditional Use Permit - 2nd Submittal
03	01.11.23	Conditional Use Permit - 3rd Submittal

PROJECT NO:	CAD DWG FILE:	DRAWN BY:	CHK'D BY:
2206	0001-0004 COVER SHEET - A.DWG	ABHAY SCHWEITZER, C.G., S.V., D.V., J.A.	ABHAY SCHWEITZER, MICHAEL R. MORTON

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COVER SHEET

G001

SHEET 1 OF 22

ABBREVIATIONS

Table of abbreviations and their meanings, organized in columns. Includes terms like 'AB: Above', 'AC: Air Conditioning', 'ACC: American Concrete Institute', etc.

Project General Notes

- 1. These drawings and specifications are the property and the copyright of TECHNE and Architect of Record...
2. Before commencing any work on the site the General Contractor shall verify locations of all site dimensions and site conditions...
3. These drawings have been prepared from the latest information available on existing conditions...

- 43. Permanent vacuum breakers shall be installed with all hose bibs.
44. All mechanical and electrical systems shall be installed in accordance with approved plans and governing codes...
45. All thermostats shall be of the automatic changeover type to sequence heating or cooling...
46. Equipment shall have the capacity of terminating all cooling at a temperature of not more than 78 degrees Fahrenheit...
47. At least one automatic space temperature control device shall be provided for each zone...
48. All ductwork shall be constructed, erected and tested in accordance with the most restrictive of local regulation procedures...

- 77. A certification completed and signed by the general contractor, subcontractor or building owner certifying that the resilient flooring, composite wood product, plywood, particle board etc comply with the VOC limits and formaldehyde limits specified in the notes above and the California Green Building Standards Code.
A. Existing Conditions:
1. Verify all existing conditions and dimensions before starting work. Report all discrepancies involving existing conditions to TECHNE and the Architect...
B. Submittals:
1. All submittals, shop drawings, product samples, etc. shall be reviewed and accepted by TECHNE and the Architect prior to final submittal to fabricator or suppliers...
C. Construction Quality:
1. All construction shall be of the highest standards for materials and methods of installation...
2. All finish materials not selected shall be reviewed and accepted by TECHNE, the Architect and the Owner...

TECHNE DESIGN | DEVELOPMENT
2934 Lincoln Ave., San Diego, CA 92104
techn@techne.com sustain@techne.com
619-940-5814 313-595-5814

CONSULTANTS
01-11-2023
Michael Mazon AIA
C-19371
RENEWABLE
04-30-2023

4909 Pacific Highway, San Diego, CA 92110
OWNER
RAP Holdings, LLC & United Partners, LLC

- 1. Locations and classifications of extinguishers shall be in accordance with CFC 906 and California Code of Regulations (CCR), Title 19.
2. During construction, at least one extinguisher shall be provided on each floor level at each stairway, in all storage and construction sheds, in locations where flammable or combustible liquids are stored or used...
3. Buildings undergoing construction, alteration, or demolition shall conform to CFC Chapter 33. Welding, cutting, and other hot work shall be in conformance with CFC Chapter 35...
4. Address identification shall be provided for all new and existing buildings in a location that is plainly visible and legible from the street or road fronting the property...

Table with columns: NO., DATE, DESCRIPTION. Includes entries like '01 09.06.22 Completeness Review Submittal', '02 12.13.22 Conditional Use Permit - 2nd Submittal', '03 01.11.23 Conditional Use Permit - 3rd Submittal'.

CONDITIONS FOR CANNABIS OUTLET CUP:

PLANNING/DESIGN REQUIREMENTS:

1. Lighting shall be provided to illuminate the interior, facade, and the immediate surrounding area of the cannabis outlet, including any accessory uses, parking lots, and adjoining sidewalks. Lighting shall be hooded or oriented to deflect light away from adjacent properties.
2. Security shall be provided at the cannabis outlet which shall include operable cameras, alarms, and a security guard. The security guard shall be licensed by the State of California and be present on the premises during business hours. The security guard shall only be engaged in activities related to providing security for the facility, except on an incidental basis.
3. Primary signs shall be posted on the outside of the cannabis outlet and shall only contain the name of the business, which shall contain only alphabetic characters, and shall be limited to two colors. Secondary signs advertising cannabis, window signs and any display visible from the public right-of-way are not permitted.
4. The name and emergency contact phone number of the designated responsible managing operator shall be posted in a location visible from outside the cannabis outlet in character size at least two inches in height.
5. The cannabis outlet shall operate only between the hours of 7:00 a.m. and 9:00 p.m., seven days a week.
6. The use of vending machines which allow access to cannabis and cannabis products except by a responsible person, as defined in San Diego Municipal Code Section 42.1502, is prohibited. For purposes of this Section, a vending machine is any device which allows access to cannabis and cannabis products without a human intermediary.
7. A permit shall be obtained as required pursuant to Chapter 4, Article 2, Division 15.
8. A Conditional Use Permit for a cannabis outlet shall expire no later than five years from the date of issuance.
9. Deliveries shall be permitted as an accessory use only from cannabis outlets with a valid Conditional Use Permit unless otherwise allowed pursuant state law.
10. The cannabis outlet, adjacent public sidewalks, and areas under the control of the cannabis, shall be maintained free of litter and graffiti at all times.
11. The cannabis outlet shall provide daily removal of trash, litter, and debris. Graffiti shall be removed from the premises within 24 hours.
12. Consultations by medical professionals shall not be a permitted accessory use at a cannabis outlet.

LANDSCAPE REQUIREMENTS:

13. Prior to issuance of any grading permit, the Owner/Permittee shall submit complete construction documents for the revegetation and hydro-seeding of all disturbed land in accordance with the City of San Diego Landscape Standards, Storm Water Design Manual, and to the satisfaction of the Development Services Department. All plans shall be in substantial conformance to this permit (including Environmental conditions) and Exhibit "A," on file in the Development Services Department.
14. Prior to issuance of any public improvement permit, the Owner/Permittee shall submit complete landscape construction documents for right-of-way improvements to the Development Services Department for approval. Improvement plans shall show, label, and dimension a 40-square-foot area around each tree which is unencumbered by utilities. Driveways, utilities, drains, water, and sewer laterals shall be designed so as not to prohibit the placement of street trees.
15. Prior to issuance of any building permit (including shell), the Owner/Permittee shall submit complete landscape and irrigation construction documents, which are consistent with the Landscape Standards, to the Development Services Department for approval. The construction documents shall be in substantial conformance with Exhibit "A," Landscape Development Plan, on file in the Development Services Department. Construction plans shall provide a 40-square-foot area around each tree that is unencumbered by hardscape and utilities unless otherwise approved per §142.0403(b)6.
16. In the event that a foundation only permit is requested by the Owner/Permittee, a site plan or staking layout plan, shall be submitted to the Development Services Department identifying all landscape areas consistent with Exhibit "A," Landscape Development Plan, on file in the Development Services Department. these landscape areas shall be clearly identified with a distinct symbol, noted with dimensions, and labeled as 'landscaping area.'
17. The Owner/Permittee shall be responsible for the maintenance of all landscape improvements shown on the approved plans, including in the right-of-way, unless long-term maintenance of said landscaping will be the responsibility of another entity approved by the Development Services Department. All required landscape shall be maintained consistent with the Landscape Standards in a disease, weed, and litter free condition at all times. Severe pruning or "topping" of trees is not permitted.



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01-11-2023



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 San Diego, CA 92110

OWNER

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 LLC

01	09.06.23	Completeness Review Submittal
02	12.13.23	Conditional Use Permit - 2nd Submittal
03	01.11.23	Conditional Use Permit - 3rd Submittal

MARK DATE DESCRIPTION

PROJECT NO: 2206

CAD DWG FILE: 0001-0004 COVER SHEET - A.DWG

DRAWN BY: ABHAY SCHWEITZER, C.G., S.V., D.V., J.A.

CHK'D BY: ABHAY SCHWEITZER, MICHAEL R. MORTON

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FCMA DS-560 September 2021 Stormwater Requirements Applicability Checklist

Project Address: 4909 Pacific Hwy., San Diego, CA 92110 Project Number: PRJ-1070996

SECTION 1 Construction Stormwater Best Management Practices (BMP) Requirements

All construction sites are required to implement construction BMPs per the performance standards in the Construction Standards Manual. Some sites are also required to obtain coverage under the State Construction General Permit (CGP), administered by the California State Water Resources Control Board.

For all projects, complete Part A - If the project is required to submit a Stormwater Pollution Prevention Plan (SWPPP) or Water Pollution Control Plan (WPCP), continue to Part A.

PART A - Determine Construction Phase Stormwater Requirements

- 1. Is the project subject to California's statewide National Pollutant Discharge Elimination System (NPDES) permit for stormwater discharges associated with construction activities...
2. Does the project propose construction or demolition activity...
3. Does the project propose routine maintenance to maintain the original line and grade...
4. Does the project only include the following Permit types listed below...

* More information on the City's construction BMP requirements as well as CGP requirements can be found at...

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PART B - Determine Construction Site Priority

This prioritization must be completed within this form, noted on the plans, and included in the SWPPP or WPCP. The City reserves the right to adjust the priority of projects both before and after construction...

Complete Part B and continue to Section 2

- 1. ASBS
A. Projects located in the ASBS watershed.
2. High Priority
A. Projects that qualify as Risk Level 2 or Risk Level 3 per the Construction General Permit (CGP) and are not located in the ASBS watershed.
3. Medium Priority
A. Projects that are not located in an ASB watershed or designated as a High priority site.

SECTION 2: Construction Stormwater BMP Requirement

Additional information for determining the requirements is found in the Construction Standards Manual.

PART C - Determine if Project is Subject to Permanent Stormwater Requirements

- 1. Does the project only include interior remodels and/or is the project entirely within an existing enclosed structure...
2. Does the project include the construction of overhead or underground utilities without creating new impervious surfaces...
3. Does the project fall under routine maintenance examples outside but are not limited to roof or exterior structure surface replacement...

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PART D - PDP Exempt Requirements

PDP exempt projects are required to implement site design and source control BMPs.

- 1. Does the project ONLY include new or retrofit sidewalks, bicycle lanes, or trails that...
2. Does the project ONLY include retrofitting or redesigning existing paved alleys, streets or roads designed and constructed in accordance with the Green Streets guidance...

PART E - Determine if Project is a Priority Development Project (PDP)

Projects that match one of the definitions below are subject to additional requirements, including preparation of a Stormwater Quality Management Plan (SQMP).

- 1. New development that creates 10,000 square feet or more of impervious surfaces collectively over the project site.
2. Redevelopment project that creates and/or replaces 5,000 square feet or more of impervious surfaces on an existing site of 10,000 square feet or more of impervious surfaces.
3. New development or redevelopment of a restaurant...
4. New development or redevelopment on a hillside...
5. New development or redevelopment of a parking lot that creates and/or replaces 5,000 square feet or more of impervious surface...
6. New development or redevelopment of streets, roads, highways, freeways, and driveways.

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- 7. New development or redevelopment discharging directly to an environmentally sensitive area.
8. New development or redevelopment projects of retail gasoline outlet (RGO) that create and/or replace 5,000 square feet of impervious surface.
9. New development or redevelopment projects of an automotive repair shop that creates and/or replaces 5,000 square feet or more of impervious surfaces.
10. Other Pollutant Generating Project. These projects are not covered in any of the categories above but involve the disturbance of one or more acres of land...

PART F - Select the appropriate category based on the outcomes of Part C through Part E

- 1. The project is NOT SUBJECT TO PERMANENT STORMWATER REQUIREMENTS.
2. The project is a STANDARD DEVELOPMENT PROJECT.
3. The project is PDP EXEMPT.
4. The project is a PRIORITY DEVELOPMENT PROJECT.

Name of Owner or Agent: Abhay Schweitzer, Title: Authorized Agent, Date: 03/16/2022

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MARK | DATE | DESCRIPTION
01-11-23 Conditional Use Permit - 2nd Submittal

PROJECT NO: 2206
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SHEET 4 OF 22



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01-11-2023



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OWNER

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SITE PLAN NOTES


- A. Before commencing any site foundation or slab cutting or excavation, the contractor shall verify and mark locations of all site utilities, dimensions and conditions. These include but are not limited to property lines, setback location to all new or existing walls, easements (if any), existing site utilities, including water, sewer, gas and electrical lines and any other new or existing site items which could affect in any way the construction of the building. Flag or otherwise mark all locations of site property lines, easements (if any), underground utilities, and indicate utility type.
- B. The Contractor or subcontractor shall notify TECHNE if any conflicts or discrepancy occurs between the information on this plan and actual field conditions. Do not proceed with work in conflict with these drawing until written or verbal instructions are issued by TECHNE.
- C. Protect and mark all existing building structure including walls, beams, columns, area separation walls, and other items that are part of the existing structure and not part of the scope of the tenant improvement, and mark perimeter of construction zone.
- D. Coordinate with other tenants the temporary shutoff of any site utilities.
- E. Refer to Topographic Survey for additional information.
- F. BUILDING ADDRESS: Building address numbers must be visible and legible from the street or road fronting the property, per FHPS Policy P-00-6 (LFC 901.4.4)
- G. TRANSIT STOP: Nearest transit stop is at Morena Blvd. & Napa Street, approximately 5,597 feet away from project.
- H. No obstruction including solid walls in the visibility area shall exceed 3 feet in height. Plant material, other than trees, within the public right-of-way that is located within visibility areas shall not exceed 24 inches in height, measured from the top of the adjacent curb.
- I. No obstruction including solid walls in the visibility area shall exceed 2 feet in height. Plant material, other than trees, within the public right-of-way that is located within visibility areas shall not exceed 24 inches in height, measured from the top of the adjacent curb.

SITE PLAN LEGEND


- PROPERTY LINE
- AREA OF PROPOSED PROJECT (SUITE A)
- AREA OF APPROVED LANDSCAPE
- AREA OF APPROVED PERVIOUS CONCRETE
- SITE DRAINAGE PATTERN
- APPROVED 24" BOX "TRISTANOPSIS LAURINA"
- APPROVED 40SF ROOT BARRIER

ADDITIONAL SITE PLAN NOTES

- 1. 5,597 FEET FROM PROJECT SUITE ENTRY TO NEAREST TRANSIT STOP #12360 LOCATED AT MORENA BLVD & NAPA ST.
- 2. VISIBILITY TRIANGLES PER SDMC 113.0273. NO OBJECTS HIGHER THAN 24" SHALL BE PROPOSED WITHIN THE VISIBILITY AREAS.

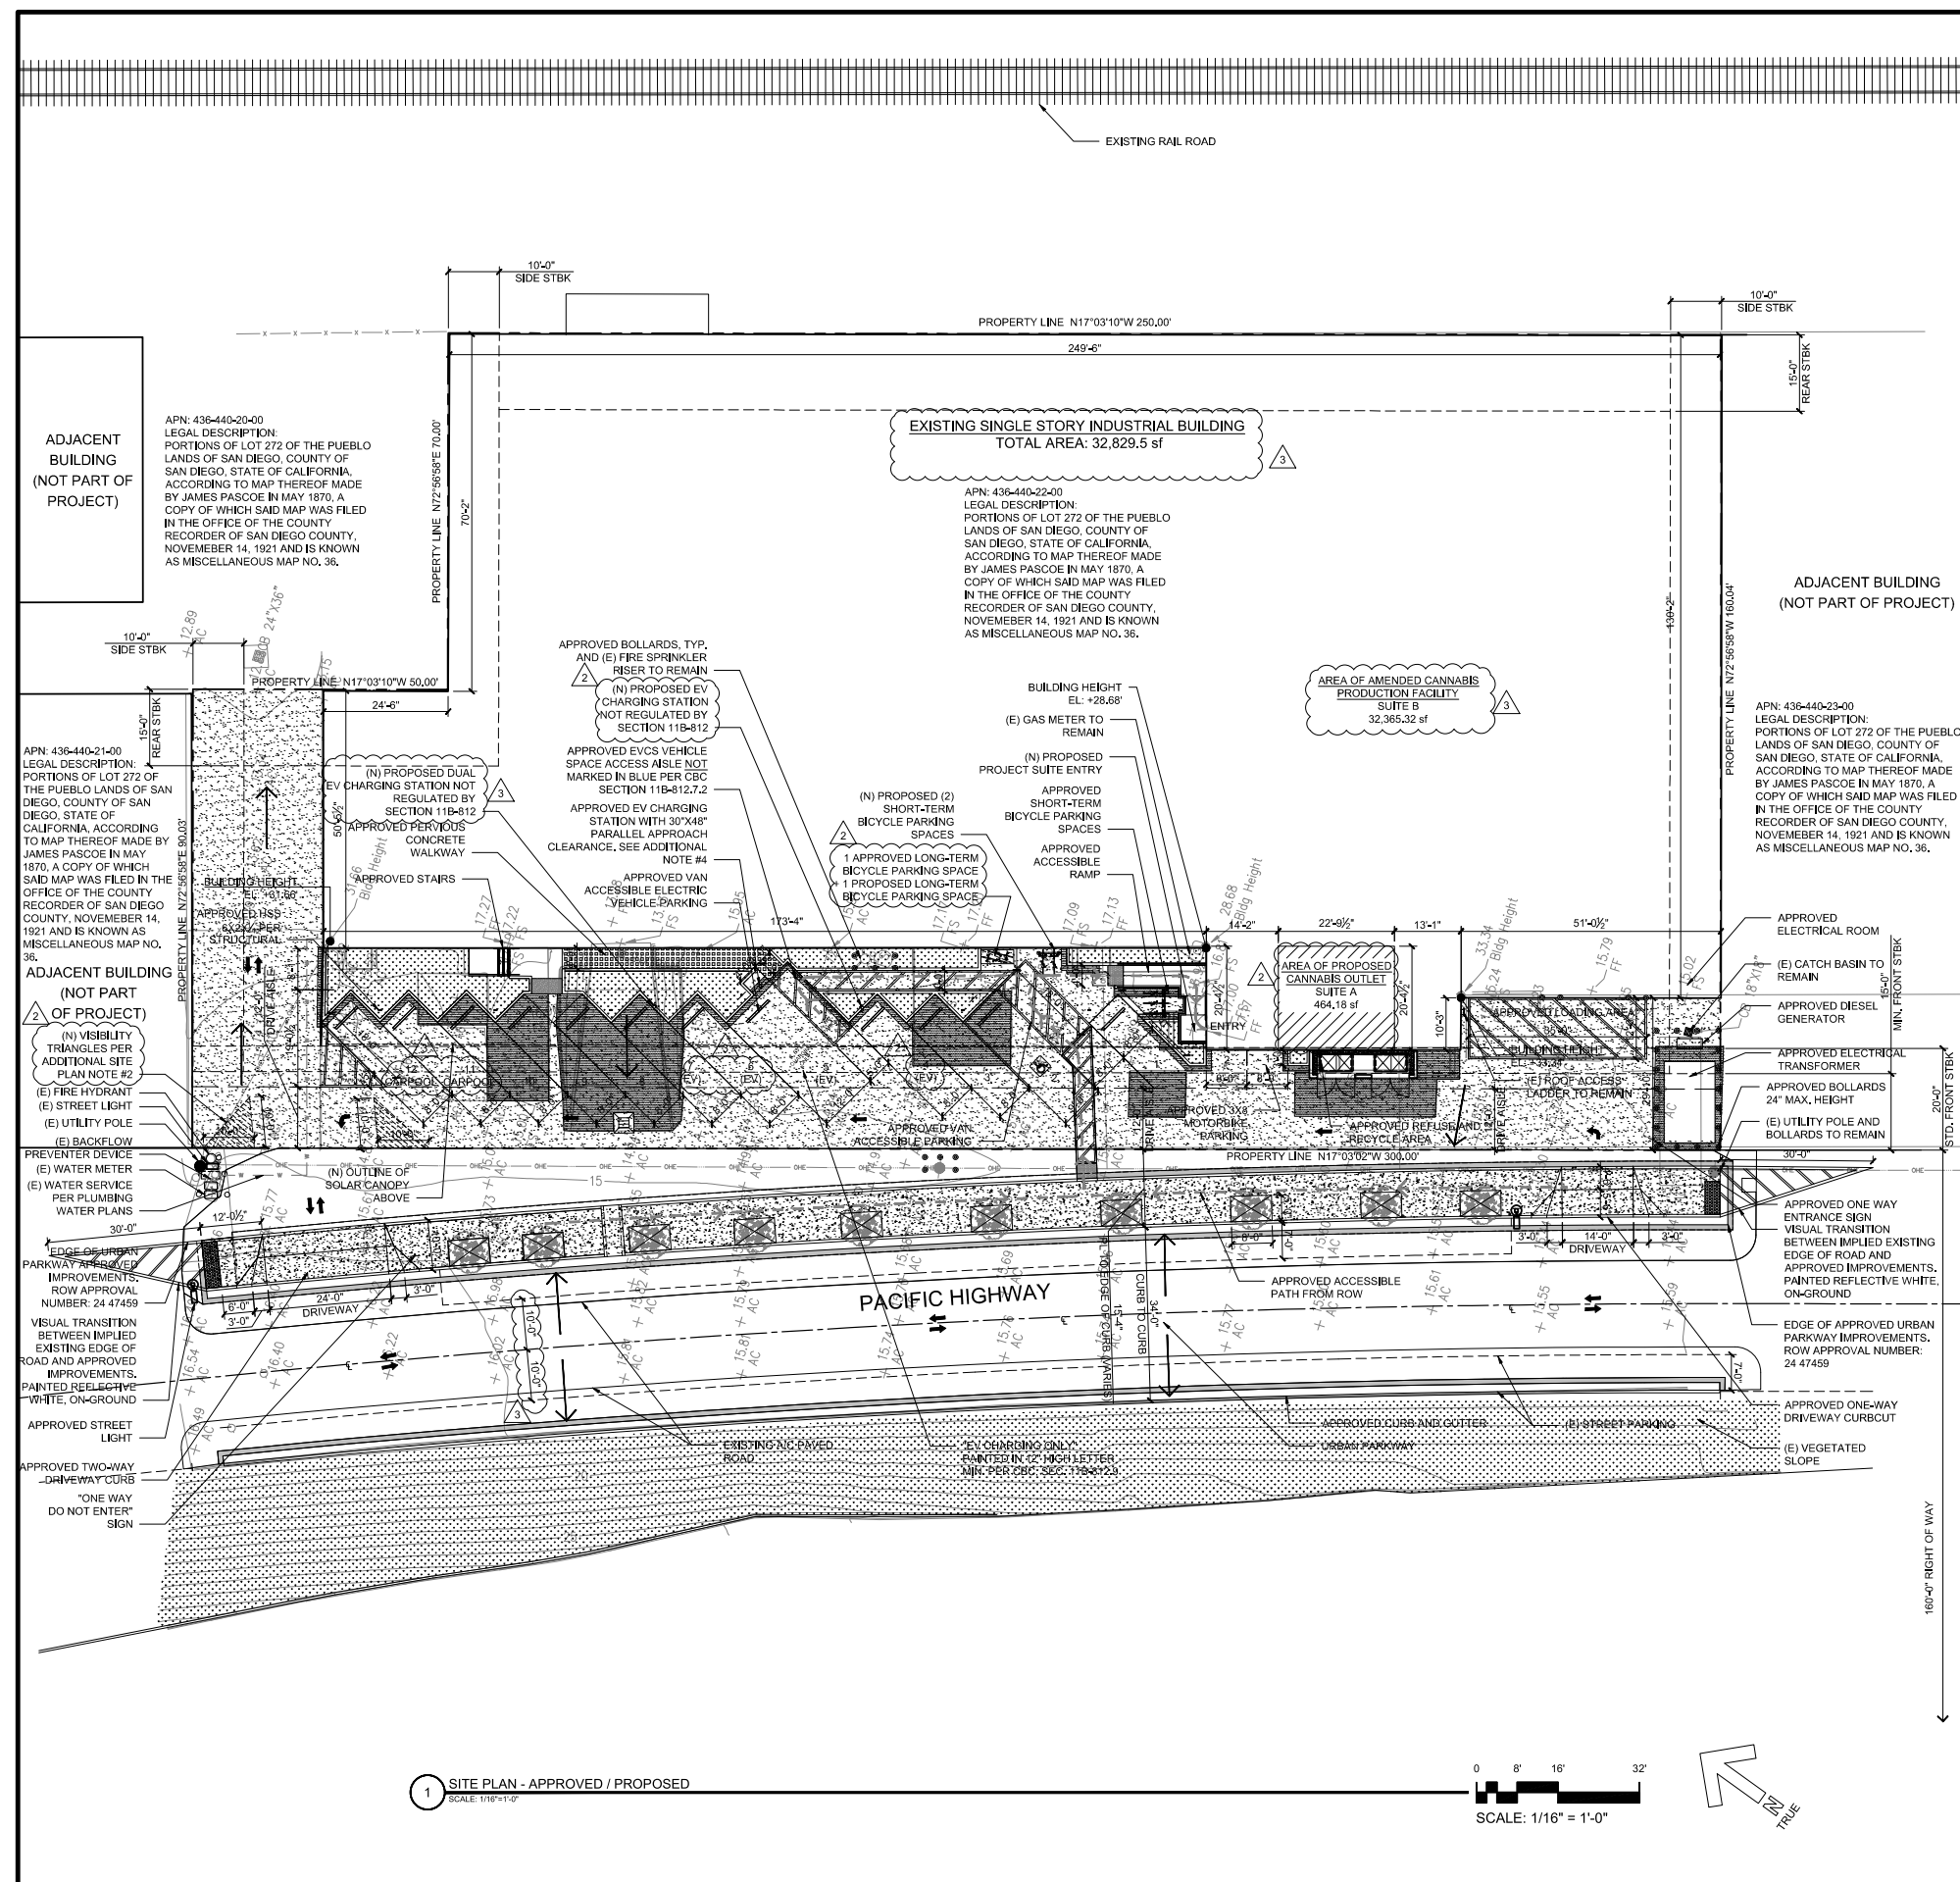

1 SITE PLAN - APPROVED / PROPOSED
 SCALE: 1/16"=1'-0"

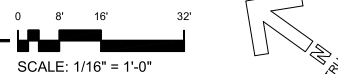

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MARK DATE DESCRIPTION

PROJECT NO: 2206
 CAD DWG FILE: A101 SITE PLAN - APPROVED-PROPOSED-A.DWG
 DRAWN BY: ABHAY SCHWEITZER, C.G., S.V., D.V., J.A.
 CHK'D BY: ABHAY SCHWEITZER, MICHAEL R. MORTON

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SITE PLAN -
 APPROVED /
 PROPOSED

A101

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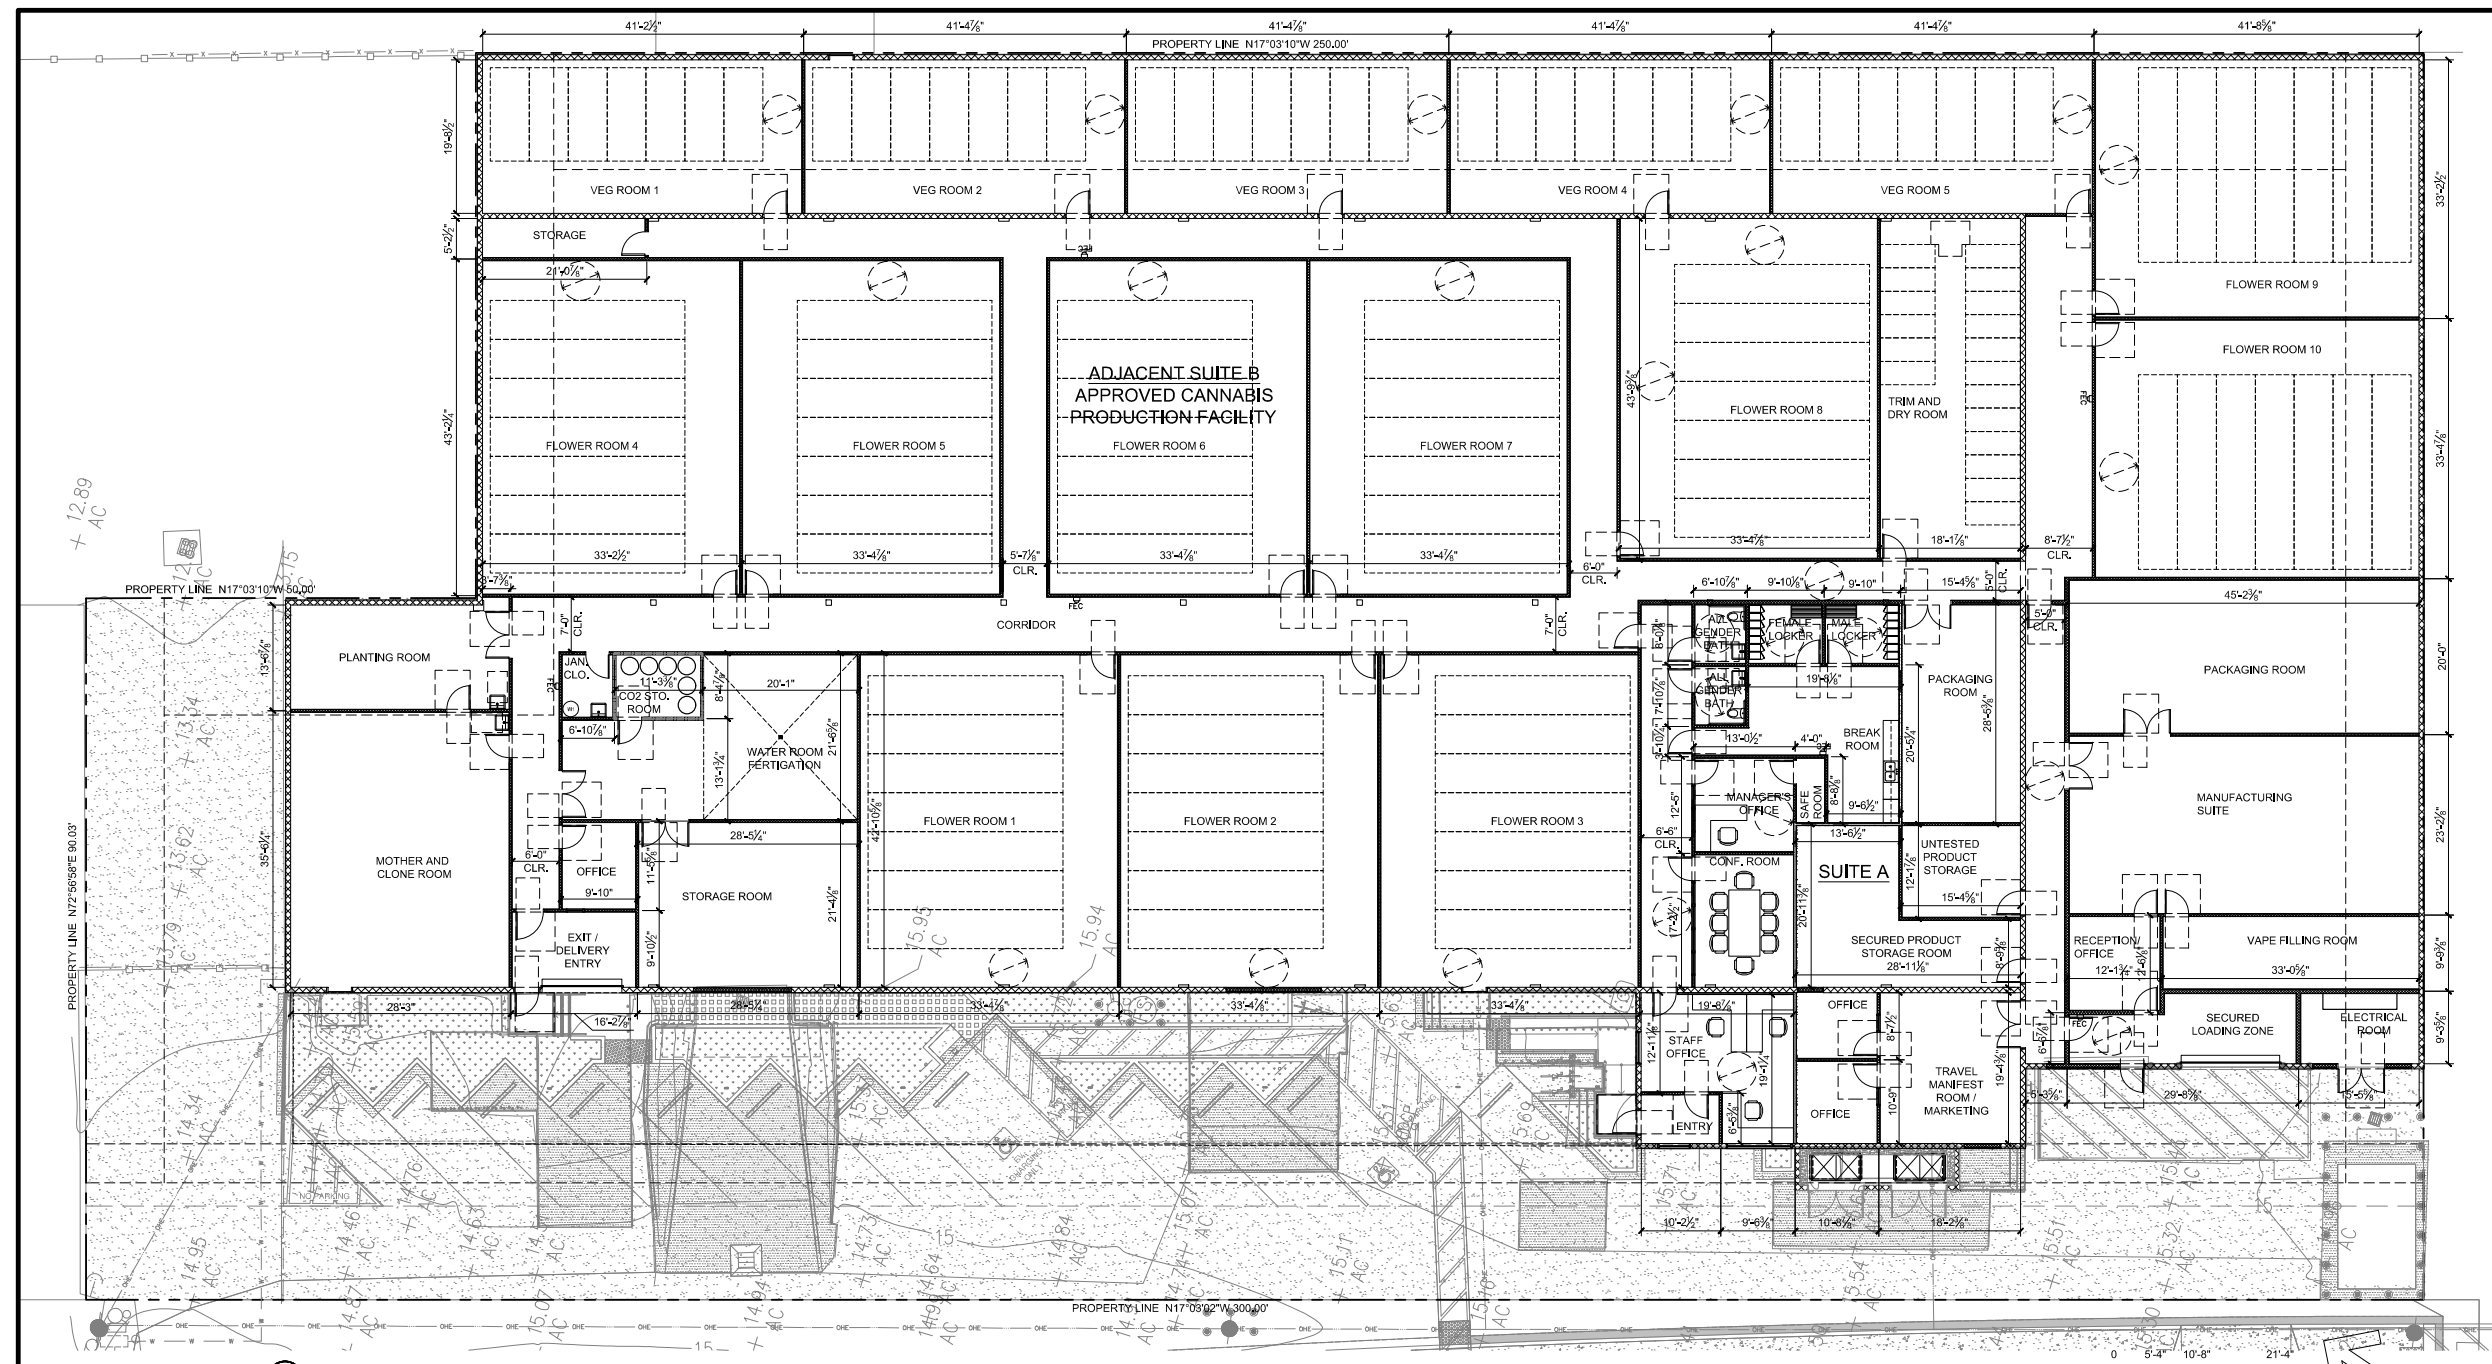
01-11-2023



4909 Pacific Highway,
San Diego, CA 92110

OWNER

RAP Holdings, LLC & United Partners,
LLC



1 FIRST FLOOR PLAN - APPROVED
SCALE: 3/32" = 1'-0"

SCALE: 3/32" = 1'-0"

FLOOR PLAN NOTES

- A. The General Contractor or Sub-Contractor shall verify all conditions or dimensions on these plans in the field with actual site conditions.
- B. Written dimensions shall take precedence over scaled dimensions and shall be verified on the job site. On-site verification of all dimensions and conditions shall be the sole responsibility of the General Contractor and Sub-Contractors.
- C. The Contractor or sub-contractor shall notify TECHNE if any conflicts or discrepancy occurs between this information on this plan and actual field conditions.
- D. Any discrepancies with this drawing affecting project layout shall be brought to the attention of TECHNE. Do not proceed with work until written or verbal instructions are issued by TECHNE.
- E. No extraction operation will be conducted per scope of work.
- F. Interior finish, including the use of any plastic, mylar, or other thin film sheeting to enclose rooms or cover any walls or ceilings shall be in accordance with CFC Ch.8. Hanging of plastic from ceiling or from suspended overhead structures to create wall dividers shall not be permitted.

- DIMENSIONS**
- EXTERIOR WALL DIMENSIONS TO FACE OF FINISH (U.N.O.)
 - INTERIOR WALL DIMENSIONS TO CENTER LINE OF STUD (U.N.O.)
 - CLEARANCE DIMENSIONS ARE TO FACE OF FINISH MATERIALS, NOTED WITH CLR.

FLOOR PLAN LEGEND

- EXISTING 8" REINFORCED CMU WALL TO REMAIN
- EXISTING NON-STRUCTURAL INTERIOR WALL TO REMAIN
- EXISTING NON-STRUCTURAL INTERIOR WALL: 6" Light Gauge Steel Stud @ 24" O.C. with 1 layer of 5/8" gypsum board with level 4 finish each side.
- EXISTING NON-STRUCTURAL INTERIOR WALL: 3/8" Light Gauge Steel Stud @ 24" O.C. with 1 layer of 5/8" gypsum board with level 4 finish each side.
- EXISTING NON-STRUCTURAL EXTERIOR WALL: 6" Light Gauge Steel Stud @ 24" O.C. with 1 layer of 5/8" gypsum board with level 4 finish on the interior and 1 layer of 5/8" sheathing and 5/8" stucco on the exterior
- 1-HOUR FIRE RATED WALL
- 3" U.N.O. DOOR.
- WINDOW.
- EXISTING FIRE EXTINGUISHER CABINET

01	09.06.23	Completeness Review Submittal
02	12.13.23	Conditional Use Permit - 2nd Submittal
03	01.11.23	Conditional Use Permit - 3rd Submittal

MARK	DATE	DESCRIPTION
PROJECT NO:	2206	
CAD DWG FILE:	A102 FIRST FLOOR PLAN - APPROVED DWG	
DRAWN BY:	ABHAY SCHWEITZER, C.G., S.V., D.V., J.A.	
CHK'D BY:	ABHAY SCHWEITZER, MICHAEL R. MORTON	

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SHEET TITLE
FIRST FLOOR PLAN - APPROVED


01-11-2023



4909 Pacific Highway,
San Diego, CA 92110

OWNER


RAP Holdings, LLC & United Partners,
LLC

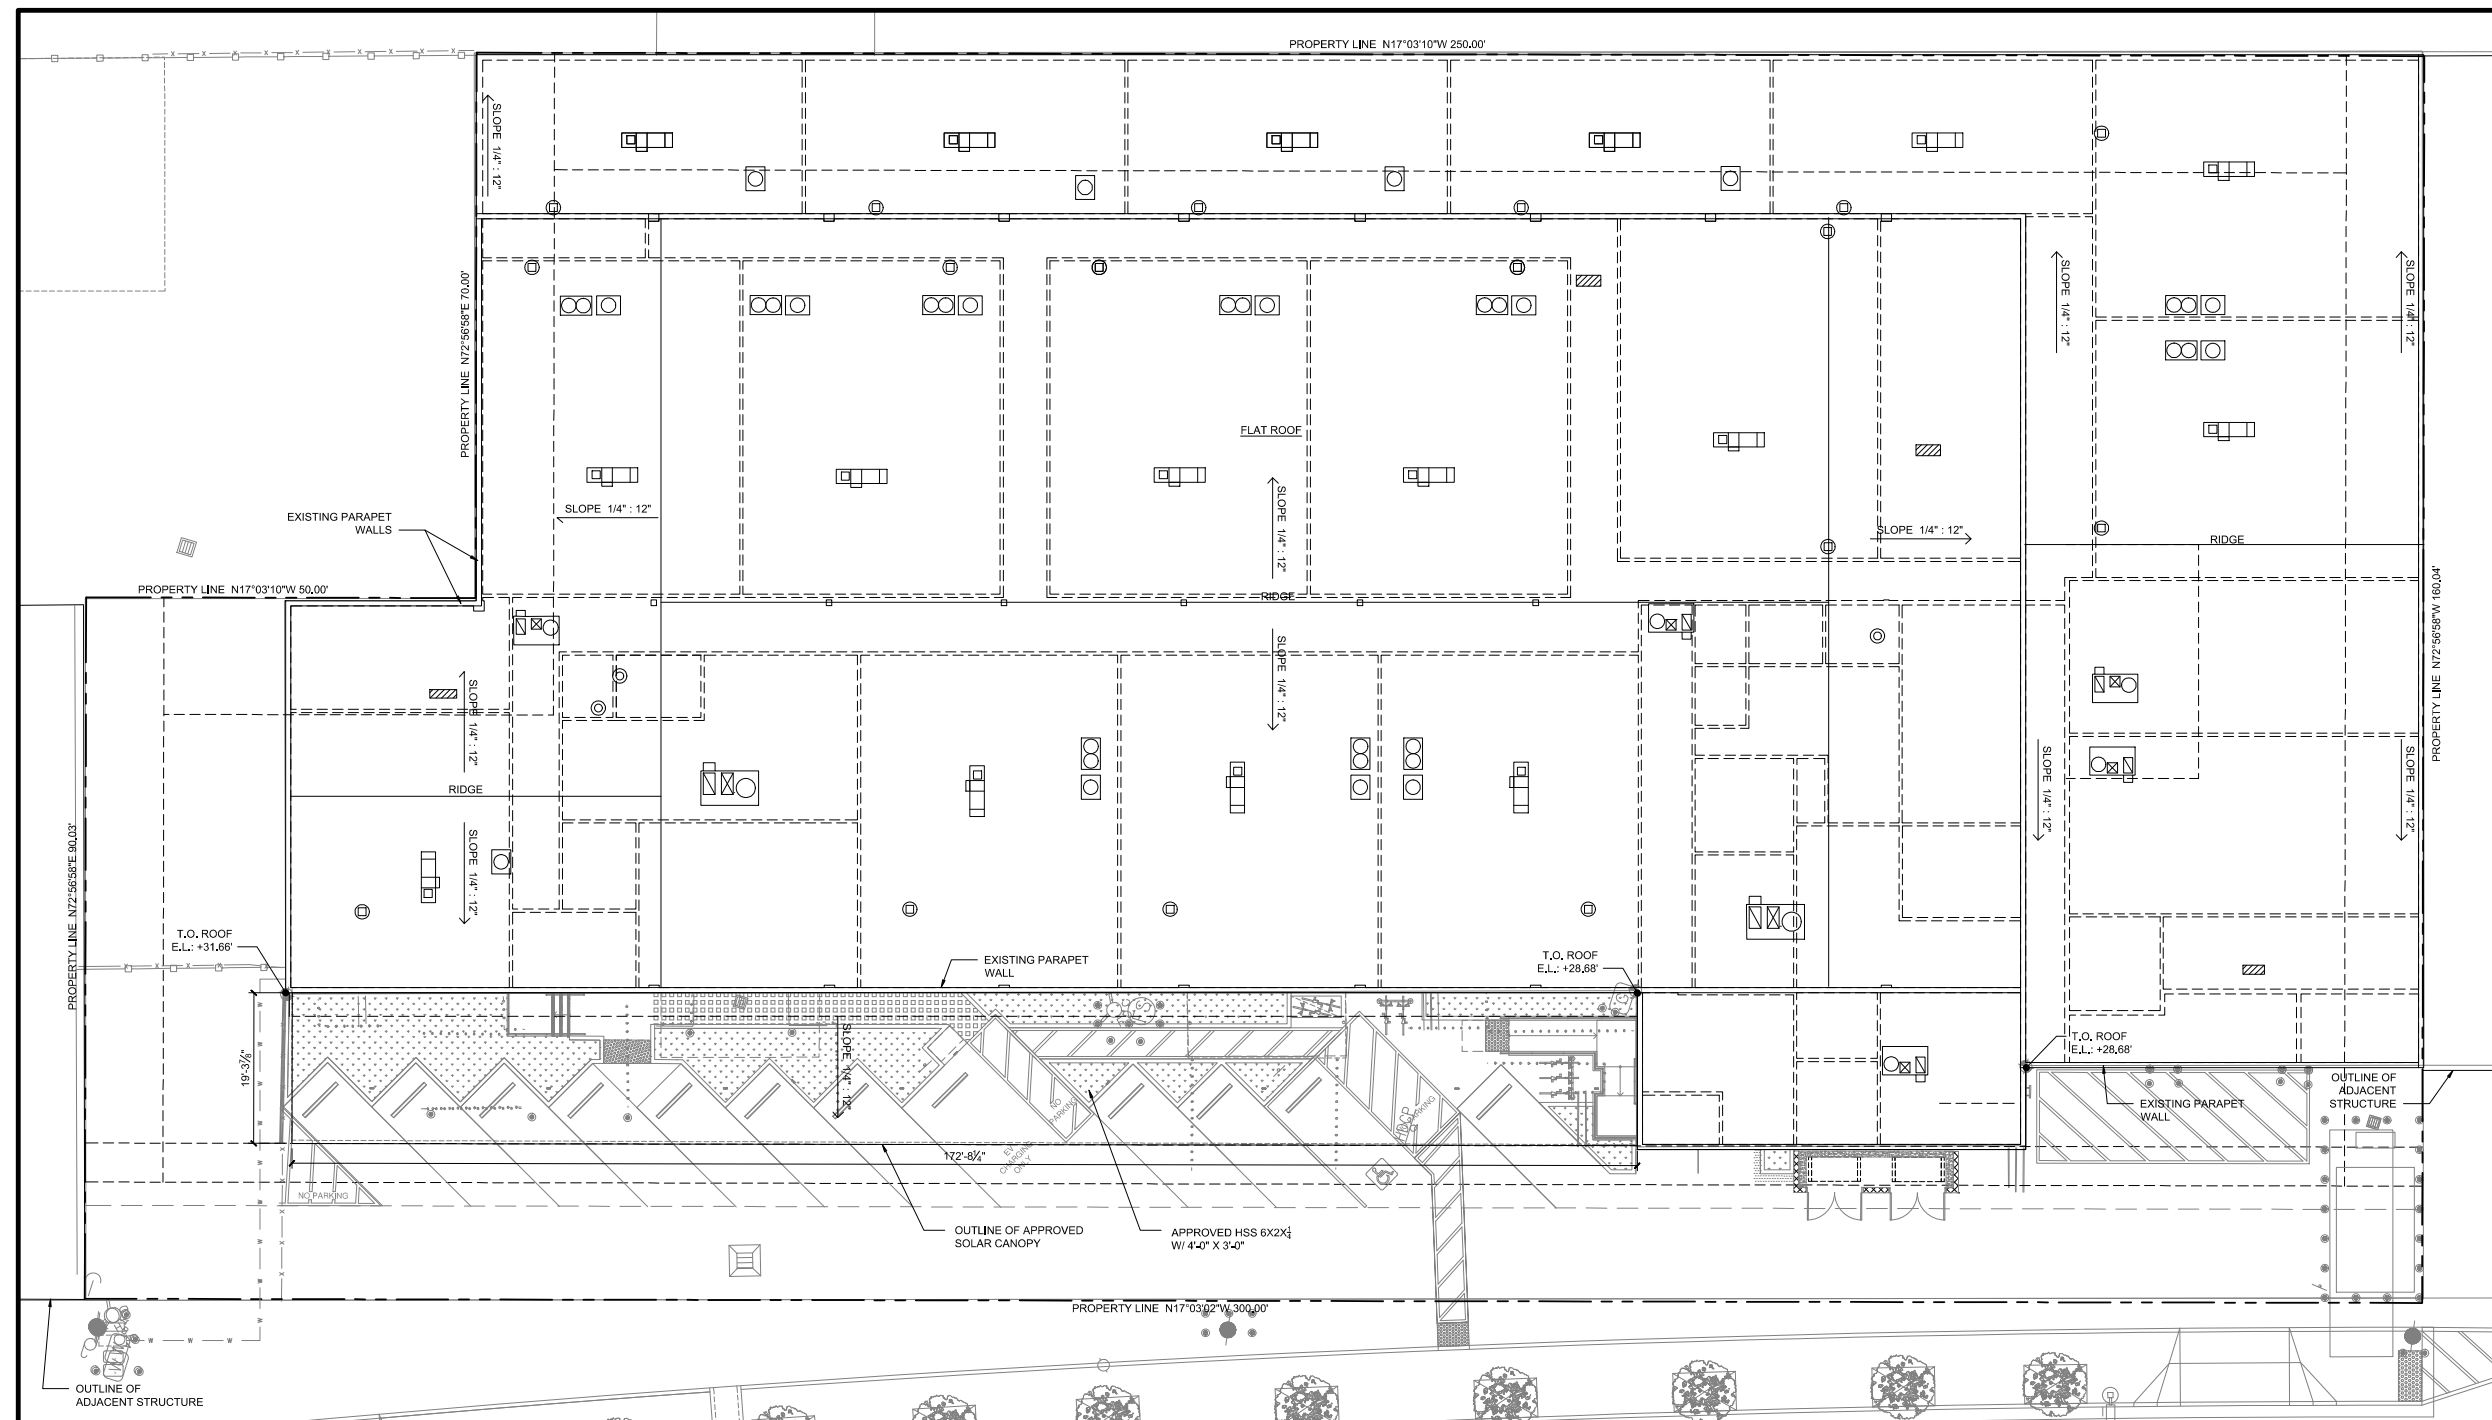

ROOF PLAN LEGEND

- ROOF SLOPE INDICATOR
- OUTLINE OF WALLS BELOW
- APPROVED ROOF MOUNTED MECHANICAL UNIT
- APPROVED VRF CONDENSING UNITS
- APPROVED EXHAUST FAN
- APPROVED ROOF MOUNTED INTAKE FAN
- APPROVED HEAT PUMP CONDENSING UNIT
- APPROVED RESTROOM TERMINATION CAP

1 ROOF PLAN - APPROVED
SCALE: 3/32" = 1'-0"

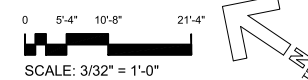

01	09.06.22	Completeness Review Submittal
02	12.13.22	Conditional Use Permit - 2nd Submittal
03	01.11.23	Conditional Use Permit - 3rd Submittal

MARK	DATE	DESCRIPTION
01	01/11/23	Final

PROJECT NO: 2206
CAD DWG FILE: A103 ROOF PLAN - APPROVED DWG
DRAWN BY: ABHAY SCHWEITZER, C.G., S.V., D.V., J.A.
CHK'D BY: ABHAY SCHWEITZER, MICHAEL R. MORTON

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SHEET TITLE
ROOF PLAN - APPROVED

A103

CONSULTANTS


01-11-2023




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RAP Holdings, LLC & United Partners,
LLC



1 FIRST FLOOR PLAN - PROPOSED
SCALE: 3/32" = 1'-0"

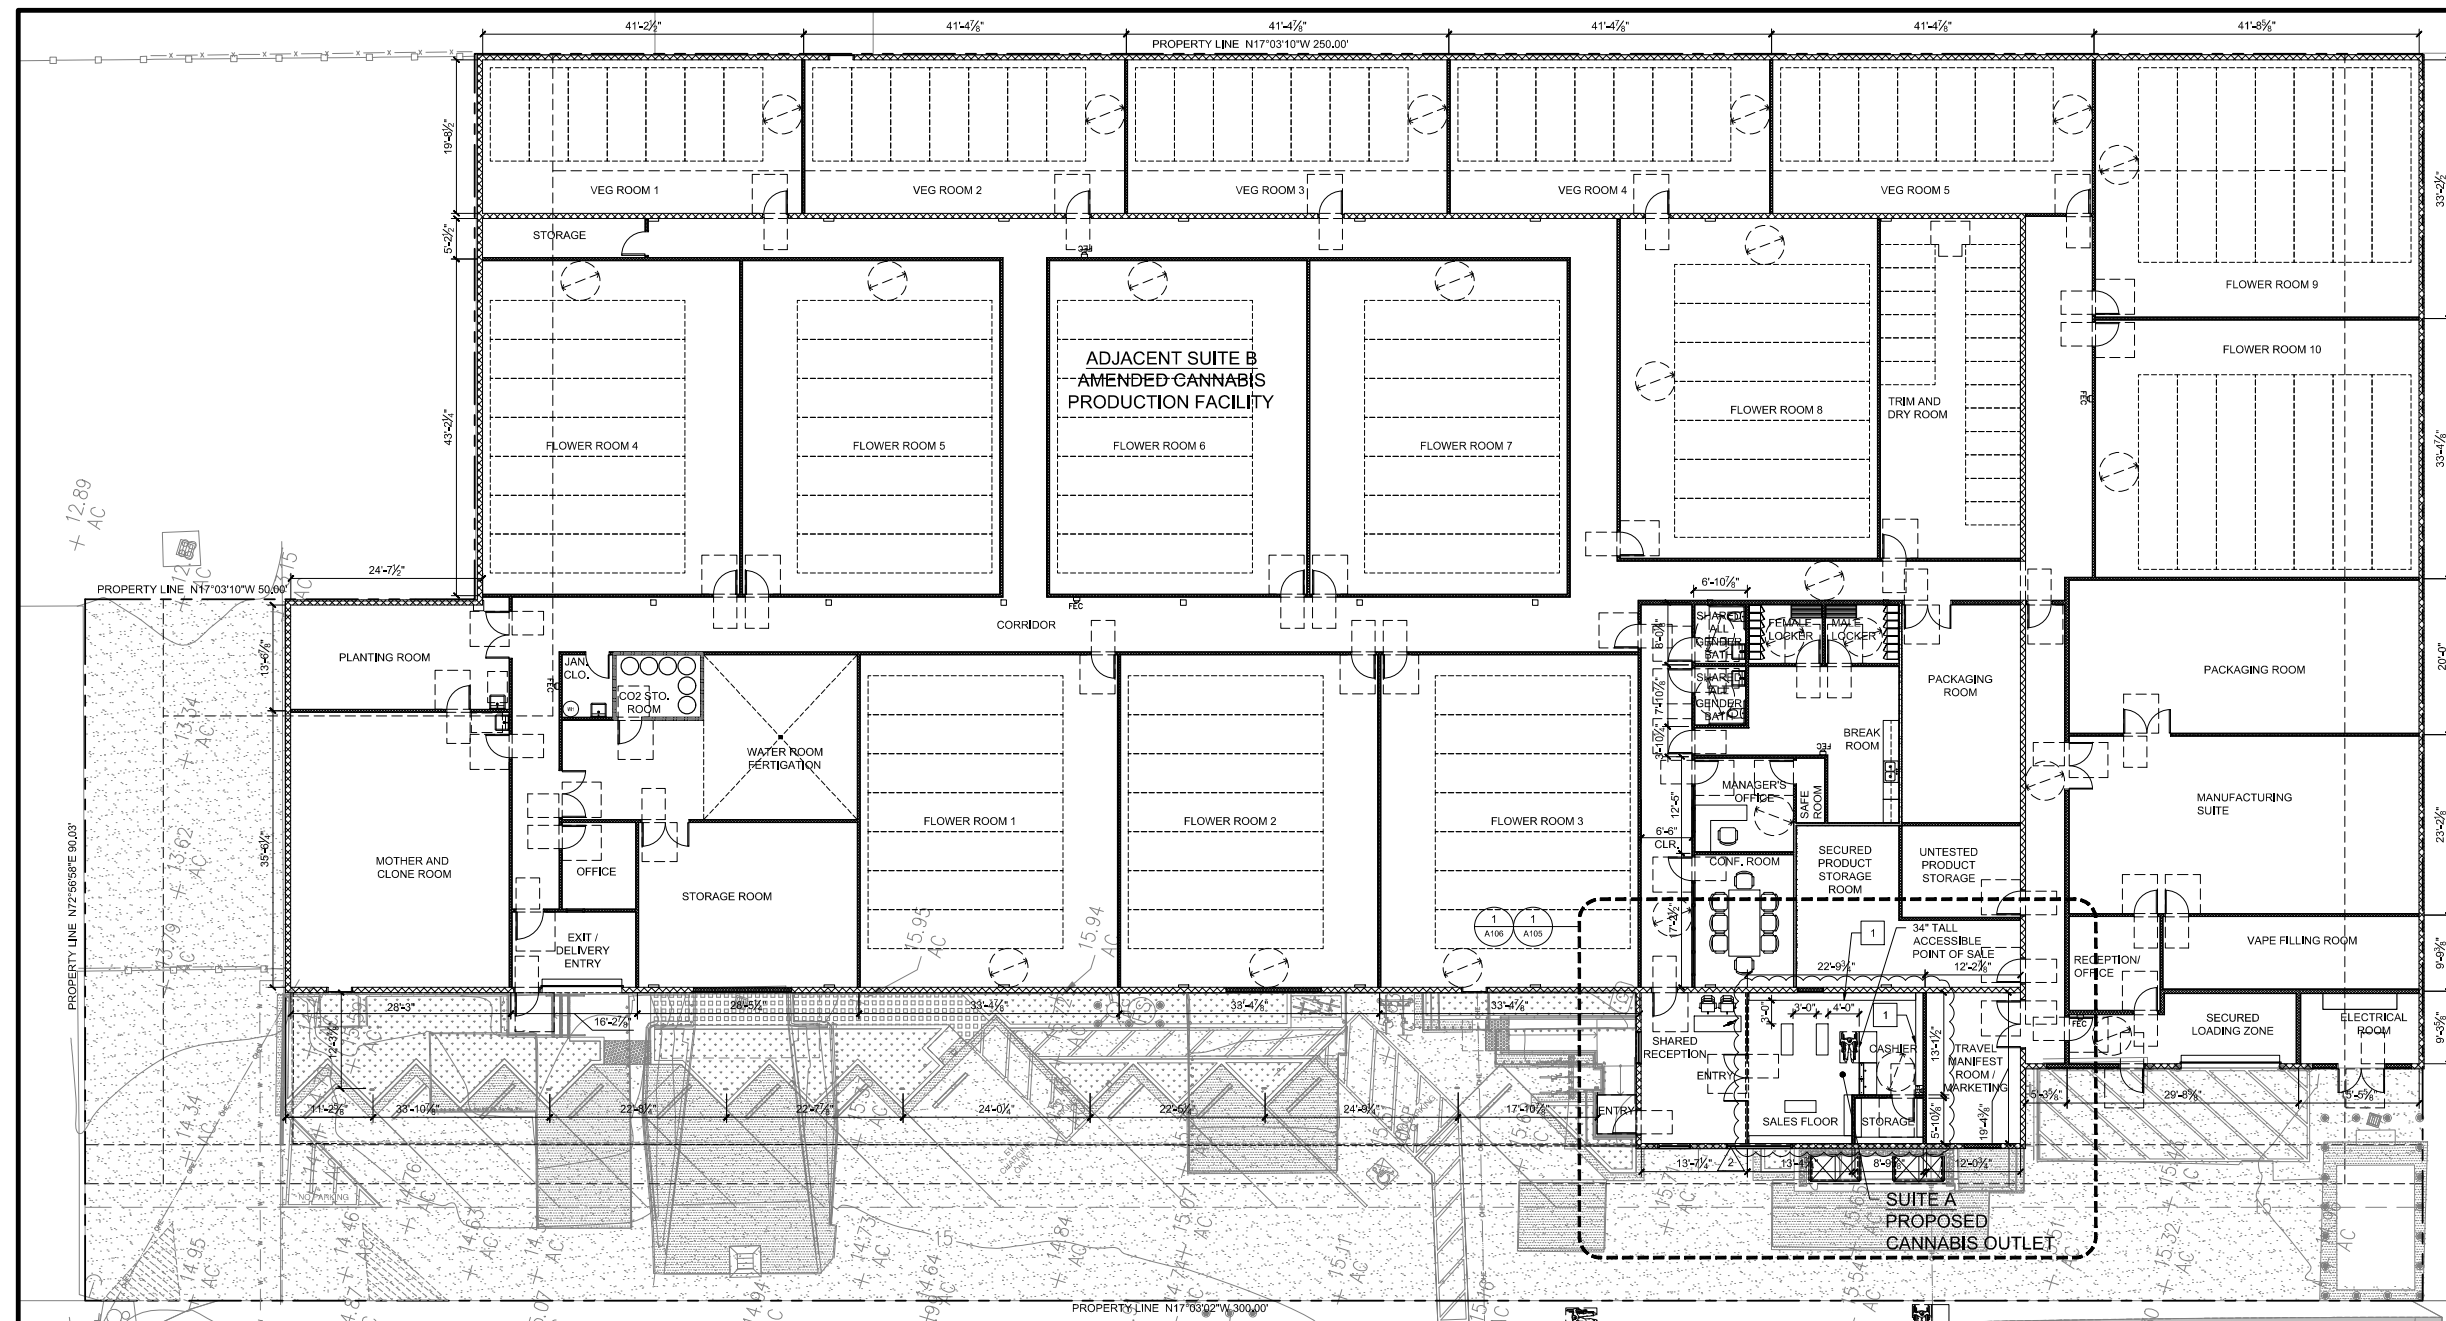

FLOOR PLAN NOTES

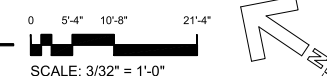- A. The General Contractor or Sub-Contractor shall verify all conditions or dimensions on these plans in the field with actual site conditions.
- B. Written dimensions shall take precedence over scaled dimensions and shall be verified on the job site. On-site verification of all dimensions and conditions shall be the sole responsibility of the General Contractor and Sub-Contractors.
- C. The Contractor or sub-contractor shall notify TECHNE if any conflicts or discrepancy occurs between this information on this plan and actual field conditions.
- D. Any discrepancies with this drawing affecting project layout shall be brought to the attention of TECHNE. Do not proceed with work until written or verbal instructions are issued by TECHNE.

- DIMENSIONS**
- EXTERIOR WALL DIMENSIONS TO FACE OF FINISH (U.N.O.)
 - INTERIOR WALL DIMENSIONS TO CENTER LINE OF STUD (U.N.O.)
 - CLEARANCE DIMENSIONS ARE TO FACE OF FINISH MATERIALS, NOTED WITH CLR.

FLOOR PLAN KEYNOTES

1. SALES FLOOR PERIMETER CABINETRY: HIGH DRAWERS AND UPPER CABINETS WITH OPEN SHELVING.

FLOOR PLAN LEGEND

- EXISTING 8" REINFORCED CMU WALL TO REMAIN
- EXISTING 2" X 4" WALL
- APPROVED NON-STRUCTURAL INTERIOR WALL: 6" Light Gauge Steel Stud @ 24" O.C. with 1 layer of 5/8" gypsum board with level 4 finish each side.
- APPROVED NON-STRUCTURAL INTERIOR WALL: 3 1/2" Light Gauge Steel Stud @ 24" O.C. with 1 layer of 5/8" gypsum board with level 4 finish each side.
- APPROVED NON-STRUCTURAL EXTERIOR WALL: 6" Light Gauge Steel Stud @ 24" O.C. with 1 layer of 5/8" gypsum board with level 4 finish on the interior and 1 layer of 5/8" sheathing and 5/8" stucco on the exterior
- PROPOSED NON-STRUCTURAL INTERIOR WALL: 3 1/2" Light Gauge Steel Stud @ 24" O.C. with 1 layer of 5/8" gypsum board each side.
- 1-HOUR FIRE RATED WALL
- 3 1/2" U.N.O. DOOR.
- WINDOW.
- PROPOSED FIRE EXTINGUISHER CABINET

NO.	DATE	DESCRIPTION
01	09.06.23	Completeness Review Submittal
02	12.13.23	Conditional Use Permit - 2nd Submittal
03	01.11.23	Conditional Use Permit - 3rd Submittal

MARK	DATE	DESCRIPTION
PROJECT NO:	2206	
CAD DWG FILE:	A104 FIRST FLOOR PLAN - PROPOSED - C.DWG	
DRAWN BY:	ABHAY SCHWEITZER, C.G., S.V., D.V., J.A.	
CHK'D BY:	ABHAY SCHWEITZER, MICHAEL R. MORTON	

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SHEET TITLE
FIRST FLOOR PLAN - PROPOSED



2934 Lincoln Ave., San Diego, CA 92104
 techn-us.com sustainablearchitecture.org
 619-940-5814 313-595-5814

CONSULTANTS


01-11-2023



4909 Pacific Highway,
 San Diego, CA 92110

OWNER

RAP Holdings, LLC & United Partners,
 LLC

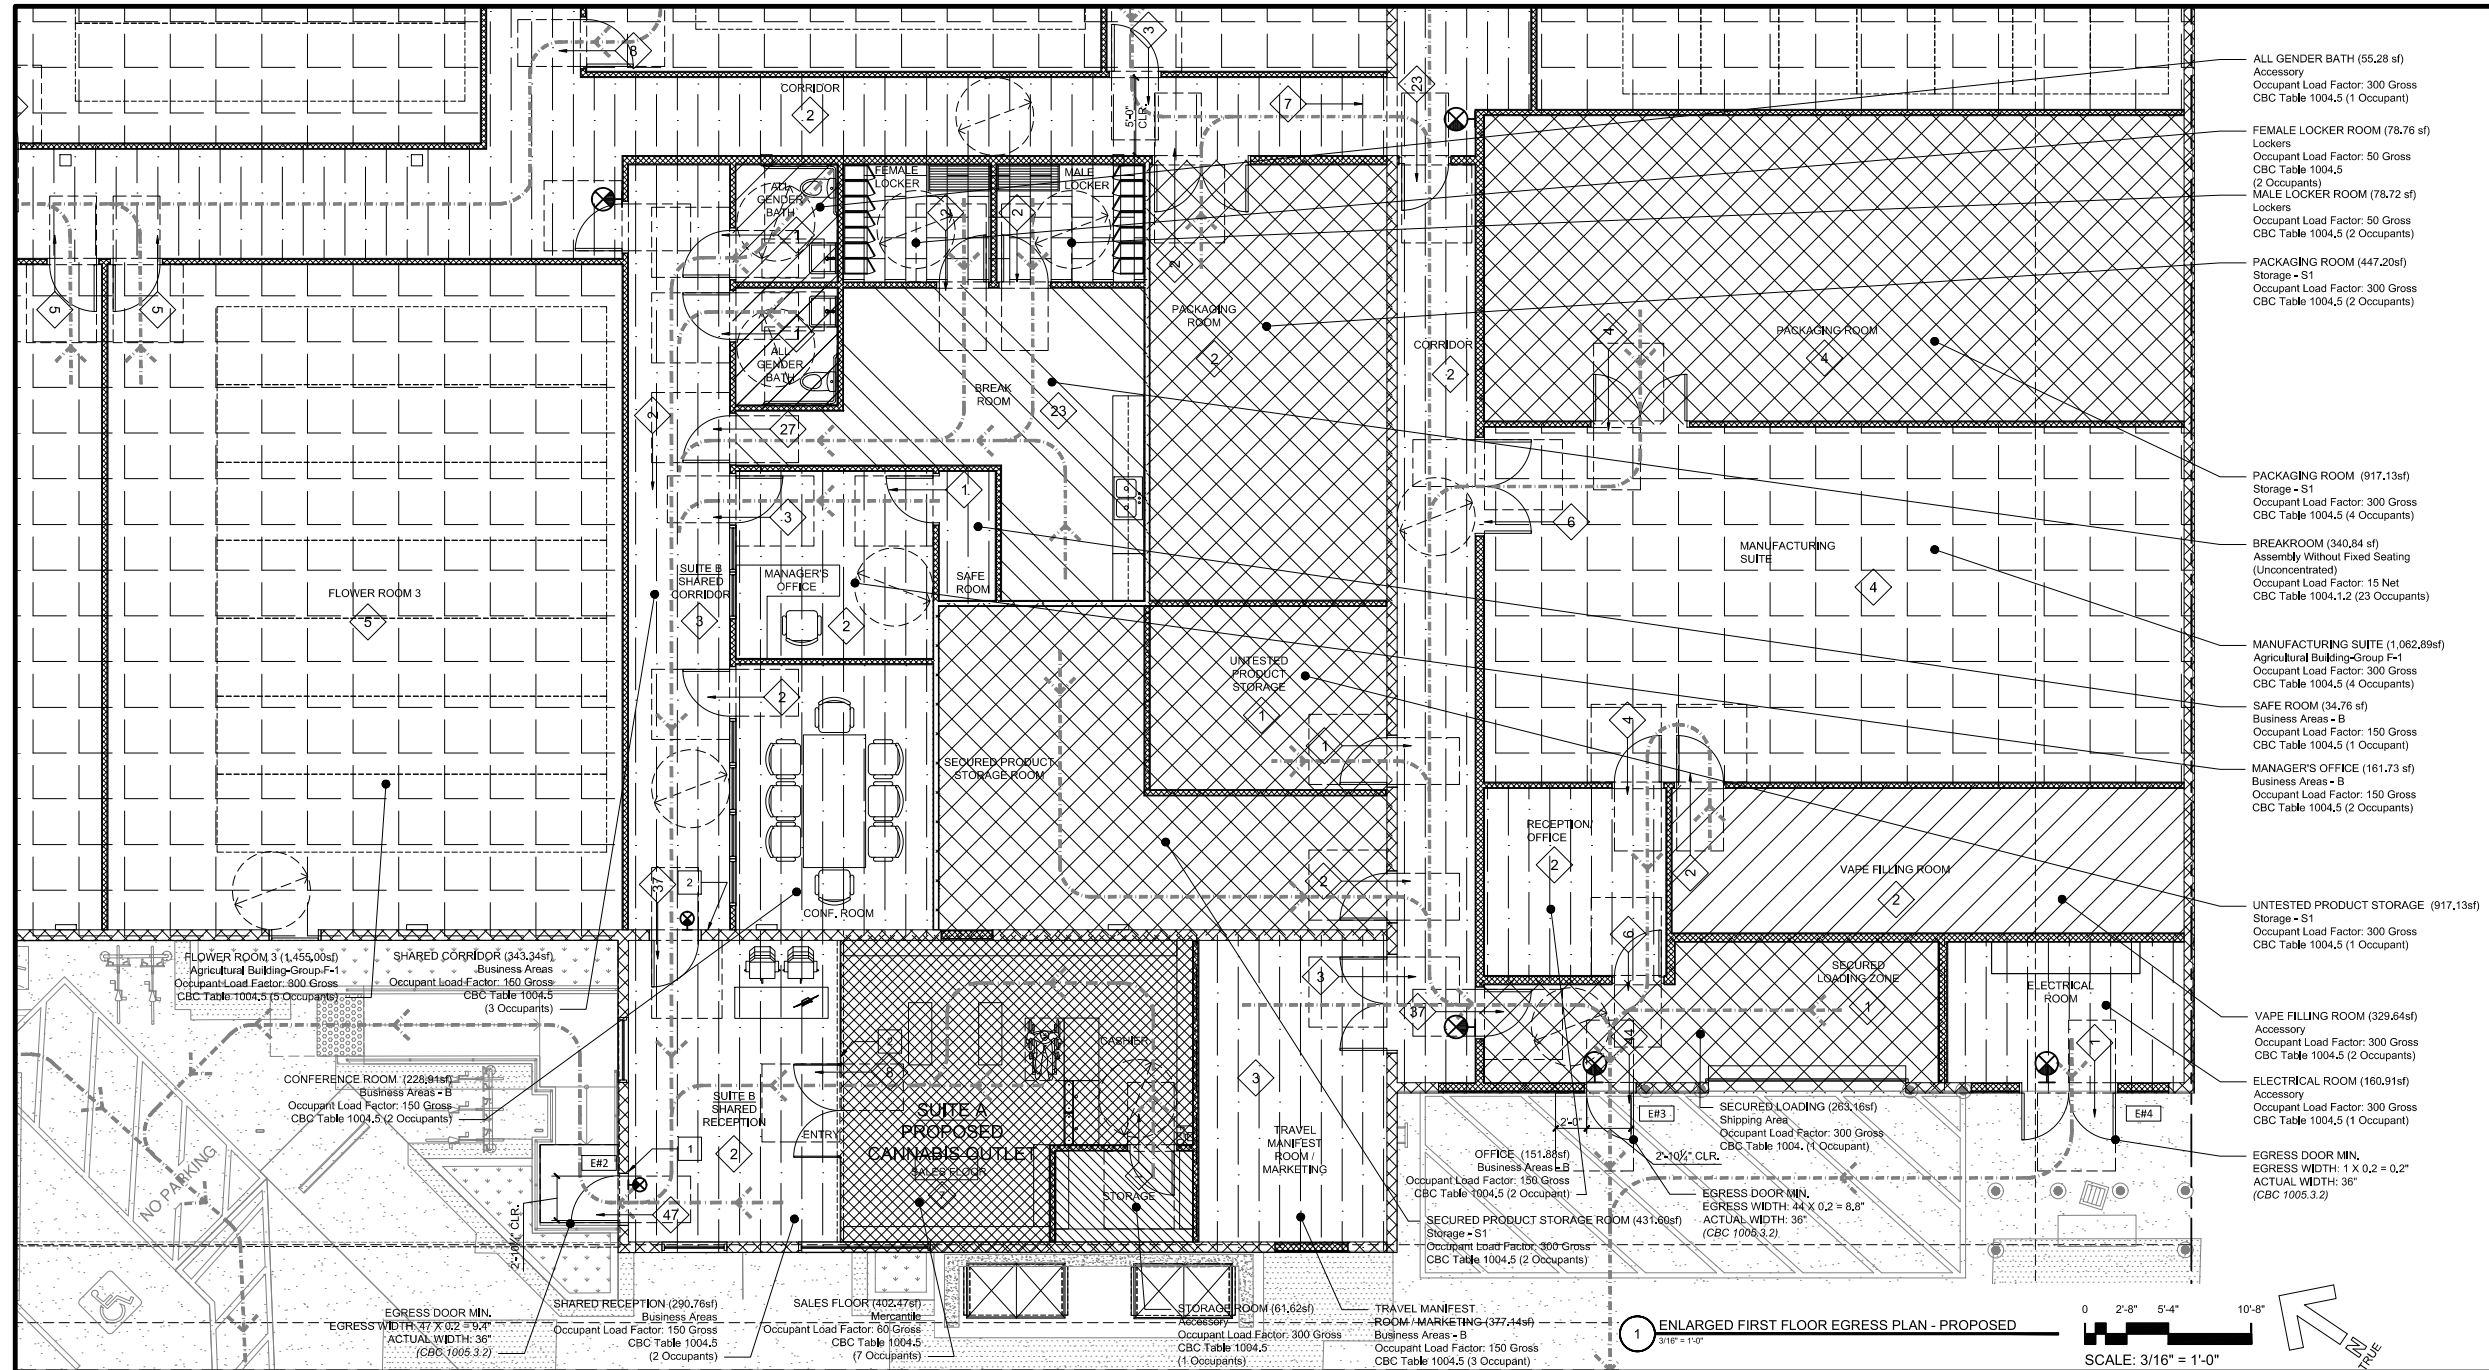

EGRESS PLAN LEGEND	
	FUNCTION OF SPACE: Business Areas Occupant Factor: 150 gross
	FUNCTION OF SPACE: Accessory Occupant Factor: 300 gross
	FUNCTION OF SPACE: Cultivation Occupant Factor: 300 gross
	FUNCTION OF SPACE: Storage, Stock & Shipping Areas Occupant Factor: 300 gross
	FUNCTION OF SPACE: Assembly Without Fixed Seating (Unconcentrated) Occupant Factor: 15 net
	FUNCTION OF SPACE: Locker Room Occupant Factor: 50 gross
	FUNCTION OF SPACE: Mercantile Occupant Factor: 60 gross

EGRESS PLAN KEYNOTES	
	TACTILE EXIT SIGN
	WALL MOUNTED EMERGENCY EXIT SIGN

ACCESSIBILITY NOTES	
1.	At least one accessible route shall be provided within the site from accessible parking spaces and accessible passenger drop-off and loading zones; public streets and sidewalks; and public transportation stops to the accessible building or facility entrance they serve. Where more than one route is provided, all routes must be accessible. (CBC Sec. 11B-206.2.1)
2.	At least one accessible route shall connect accessible buildings, accessible facilities, accessible elements, and accessible spaces that are on the same site. (CBC Sec. 11B-206.2.2)
3.	At least one accessible route shall connect accessible building or facility entrances with all accessible spaces and elements within the building or facility, including mezzanines, which are otherwise connected by a circulation path unless exempted by CBC 2019 Section 11B-206.2.3 Exception: 1 through 7. (CBC Sec. 11B-206.2.4)
4.	Handles, pulls, latches, locks, and other operable parts on doors and gates shall comply with CBC Section 11B-309.4. Operable parts of such hardware shall be 34 inches (864 mm) minimum and 44 inches (1118 mm) maximum above the finish floor or ground. Where sliding doors are in the fully open position, operating hardware shall be exposed and usable from both sides. (CBC Sec. 11B-404.2.7)
5.	Operable parts shall be operable with one hand and shall not require tight grasping, pinching, or twisting of the wrist. The force required to activate operable parts shall be 5 pounds (22.2 N) maximum. (CBC Sec. 11B-309.4)
6.	Door openings shall provide a clear width of 32 inches (813 mm) minimum. Clear openings of doorways with swinging doors shall be measured between the face of the door and the stop, with the door open 90 degrees. Openings more than 24 inches (610 mm) deep shall provide a clear opening of 36 inches (914 mm) minimum. There shall be no projections into the required clear opening width lower than 34 inches (864 mm) above the finish floor or ground. Projections into the clear opening width between 34 inches (864 mm) and 80 inches (2032 mm) above the finish floor or ground shall not exceed 4 inches (102 mm). (CBC Sec. 11B-404.2.3)
7.	Minimum maneuvering clearances at doors and gates shall comply with CBC Section 11B-404.2.4, Figure 11B-404.2.4.1. Maneuvering clearances shall extend the full width of the doorway and the required latch side or hinge side clearance. (CBC Sec. 11B-404.2.4)
8.	Floor or ground surface within required maneuvering clearances shall be stable, firm, and slip resistant in compliance with CBC Section 11B-302. Changes in level are not permitted. (CBC Sec. 11B-404.2.4.4)
9.	Maneuvering clearances for forward approach shall be provided when any obstruction within 18 inches (457 mm) of the latch side of an interior doorway, or within 24 inches (610 mm) of the latch side of an exterior doorway, projects more than 8 inches (203 mm) beyond the face of the door, measured perpendicular to the face of the door or gate. (CBC Sec. 11B-404.2.4.3 and Fig. 11B-404.2.4.3)
10.	Thresholds, if provided at doorways, shall be as follows: Changes in level of 1/4 inch (6.4 mm) high maximum shall be permitted to be vertical and without edge treatment (CBC Sec. 11B-303.2) and changes in level between 1/4 inch (6.4 mm) high minimum and 1/2 inch (12.7 mm) high maximum shall be beveled with a slope not steeper than 1:2 (CBC Sec. 11B-303.3)
11.	Swinging door and gate surfaces within 10 inches (254 mm) of the finish floor or ground measured vertically shall have a smooth surface on the push side extending the full width of the door or gate. Parts creating horizontal or vertical joints in these surfaces shall be within 1/16 inch (1.6 mm) of the same plane as the other and be free of sharp or abrasive edges. Cavities created by added kick plates shall be capped. (CBC Sec. 11B-404.2.10)
12.	The force for pushing or pulling open a door or gate shall be as follows: Interior hinged doors and gates: 5 pounds (22.2 N) maximum; Sliding or folding doors: 5 pounds (22.2 N) maximum; Required fire doors: the minimum opening force allowable by the appropriate administrative authority, not to exceed 15 pounds (66.7 N); Exterior hinged doors: 5 pounds (22.2 N) maximum. These forces do not apply to the force required to retract latch bolts or disengage other devices that hold the door or gate in a closed position. (CBC Sec. 11B-404.2.9)
13.	Except as provided in CBC Sections 11B-403.5.2 and 11B-403.5.3, the clear width of walking surfaces shall be 36 inches (914 mm) minimum. (CBC Sec. 11B-403.5.1)
14.	Employee workstations shall be on an accessible route complying with Division 4. Spaces and elements within employee workstations shall only be required to comply with CBC Sections 11B-207.1, 11B-215.3, 11B-302, 11B-303, 11B-308.1.1, 11B-308.1.2, and 11B-308.1.2.3 unless exempted by other parts of this code. Common use circulation paths within employee workstations shall comply with Section 11B-206.2.8. (CBC Sec. 11B-303.9)
15.	The clear width shall be permitted to be reduced to 32 inches (813 mm) minimum for a length of 24 inches (610 mm) maximum provided that reduced width segments are separated by segments that are 48 inches (1219 mm) long minimum and 36 inches (914 mm) wide minimum. (CBC Sec. 11B-403.5.1, exception 1)
16.	Exterior Exit doors shall have a sign posted above stating: THIS DOOR TO REMAIN UNLOCKED WHILE BUSINESS IS OCCUPYING.
17.	PROVIDE PANIC HARDWARE AT EXIT DOORS WHERE NOTED.
18.	Means of egress doors shall be readily distinguishable from the adjacent construction & finishes such that the doors are easily recognized. Mirrors or similar reflecting materials shall not be used on means of egress doors. Means of egress doors shall not be concealed by curtains, drapes, decorations or similar materials. (CBC Sec. 1010.1)
19.	Gates used as a component in a means of egress shall conform to the applicable requirements for doors. (CBC Sec. 1010.2)
20.	Door closers and gate closers shall be adjusted so that from an open position of 90 degrees, the time required to move the door to a position of 12 degrees from the latch is 5 seconds minimum. (CBC Sec. 11B-404.2.8.1)

EGRESS & ACCESSIBILITY NOTES	
	ACCESSIBLE ROUTE - Accessible routes shall comply with CBC Section 11B-402. Walking surfaces shall provide clearances complying with CBC Section 11B-403.5. The running slope of walking surfaces shall not be steeper than 1:20. The cross slope of walking surfaces shall not be steeper than 1:48 per CBC Section 11B-403.9. Except as provided in CBC Sections 11B-403.5.2 and 11B-403.5.3, the clear width of walking surfaces shall be 36 inches (914 mm) minimum. The clear width for walking surfaces in corridors serving an occupant load of 10 or more shall be 44 inches (1118 mm) minimum. The clear width for sidewalks and walks shall be 48 inches (1219 mm) minimum.
	MEANS OF EGRESS - A continuous and unobstructed path of vertical and horizontal egress travel from any occupied portion of a building or structure to a public way. A means of egress consists of three separate and distinct parts: the exit access, the exit and the exit discharge. Means of Egress shall comply with CBC Chapter 10.
	DESIGN OCCUPANT LOAD - The number of occupants whom means egress facilities shall be provided. Where occupants from accessory areas egress through a primary space, the calculated occupant load for the primary space shall include the total occupant load of the primary space plus the number of occupants egressing through it from the accessory area.
	MINIMUM EGRESS WIDTH - The total width of means of egress in inches (mm) shall not be less than the total occupant load served by the means of egress multiplied by 0.3 inches (7.62 mm) per occupant for stairways and by 0.2 inches (5.08 mm) per occupant for other egress components. Multiple means of egress shall be sized such that the loss of any one means of egress shall not reduce the available capacity to less than 50 percent of the required capacity. The maximum capacity required from any story of a building shall be maintained to the termination of the means of egress. (CBC Sec. 1005.1)
	DOOR ENCROACHMENT - Doors, when fully opened, and handrails shall not reduce the required means of egress width by more than 7 inches (178 mm). Doors in any position shall not reduce the required width by more than one-half. Other nonstructural projections such as trim and similar decorative features shall be permitted to project into the required width a maximum of 1 1/2 inches (38 mm) on each side. (CBC Sec. 1005.7)
	EGRESS - Egress doors must be readily openable from egress side without use of a key or any special knowledge or effort. (CBC Sec. 1010.1.9) Unlatching any door or leaf shall not require more than one operation. (CBC Sec. 1010.1.9.6)
	EXIT SIGNS - Exit signs shall be internally and externally illuminated at all times. Externally illuminated exit signs shall be connected to an emergency power system (batteries, unit equipment or an on-site generator) that will automatically illuminate the exit signs for a duration of not less than 90 minutes in case of primary loss. (CBC Sec. 1013.1, 1013.3, 1013.6.3)
	EGRESS ILLUMINATION - The means of egress, including the exit discharge, shall be illuminated to a level of not less than 1 footcandle (11 lux) at the walking surface at all times the building space served by the means of egress is occupied. (CBC Sec. 1008.2.1)
	ILLUMINATION EMERGENCY POWER - The power supply for means of egress illumination shall normally be provided by the premises' electrical supply. (CBC Sec. 1008.3)
	In the event of power supply failure in buildings that require two or more means of egress, an emergency electrical system shall automatically illuminate all of the following areas: 1. Interior exit access stairways and ramps. 2. Interior and exterior exit stairways and ramps. 3. Exit passageways. 4. Vestibules and areas on the level of discharge used for exit discharge in accordance with CBC Section 1028.1. 5. Exterior landings as required by CBC Section 1010.1.6 for exit doorways that lead directly to the exit discharge. (CBC Sec. 1008.3.2)
	The emergency power system shall provide power for a duration of not less than 90 minutes and shall consist of storage batteries, unit equipment or an on-site generator. The installation of the emergency power system shall be in accordance with CBC Section 2702. (CBC Sec. 1008.3.4)
	Illumination level under emergency power. Emergency lighting facilities shall be arranged to provide initial illumination that is at least an average of 1 footcandle (11 lux) and a minimum at any point of 0.1 footcandle (1 lux) measured along the path of egress at floor level. Illumination levels shall be permitted to decline to 0.6 footcandle (6 lux) average and a minimum at any point of 0.06 footcandle (0.6 lux) at the end of the emergency lighting time duration. A maximum-to-minimum illumination uniformity ratio of 40 to 1 shall not be exceeded. (CBC Sec. 1008.3.5)
	This facility will not utilize delayed egress components or systems.

MARK	DATE	DESCRIPTION
01	09.06.22	Completeness Review Submittal
02	12.13.22	Conditional Use Permit - 2nd Submittal
03	01.11.23	Conditional Use Permit - 3rd Submittal

PROJECT NO:	2206
CAD DWG FILE:	A105-1108 FIRST FLOOR EGRESS, ACCESSIBILITY PLAN - PROPOSED.rvt
DRAWN BY:	ABHAY SCHWEITZER, C.G., S.V., D.V., J.A.
CHK'D BY:	ABHAY SCHWEITZER, MICHAEL R. MORTON

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SHEET TITLE
ENLARGED FIRST FLOOR EGRESS PLAN - PROPOSED
 A105

SHEET 7 OF 22


01-11-2023



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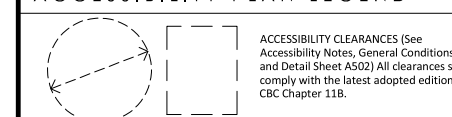
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RAP Holdings, LLC & United Partners,
LLC



1 ENLARGED FIRST FLOOR ACCESSIBILITY PLAN - PROPOSED
SCALE: 1/8" = 1'-0"

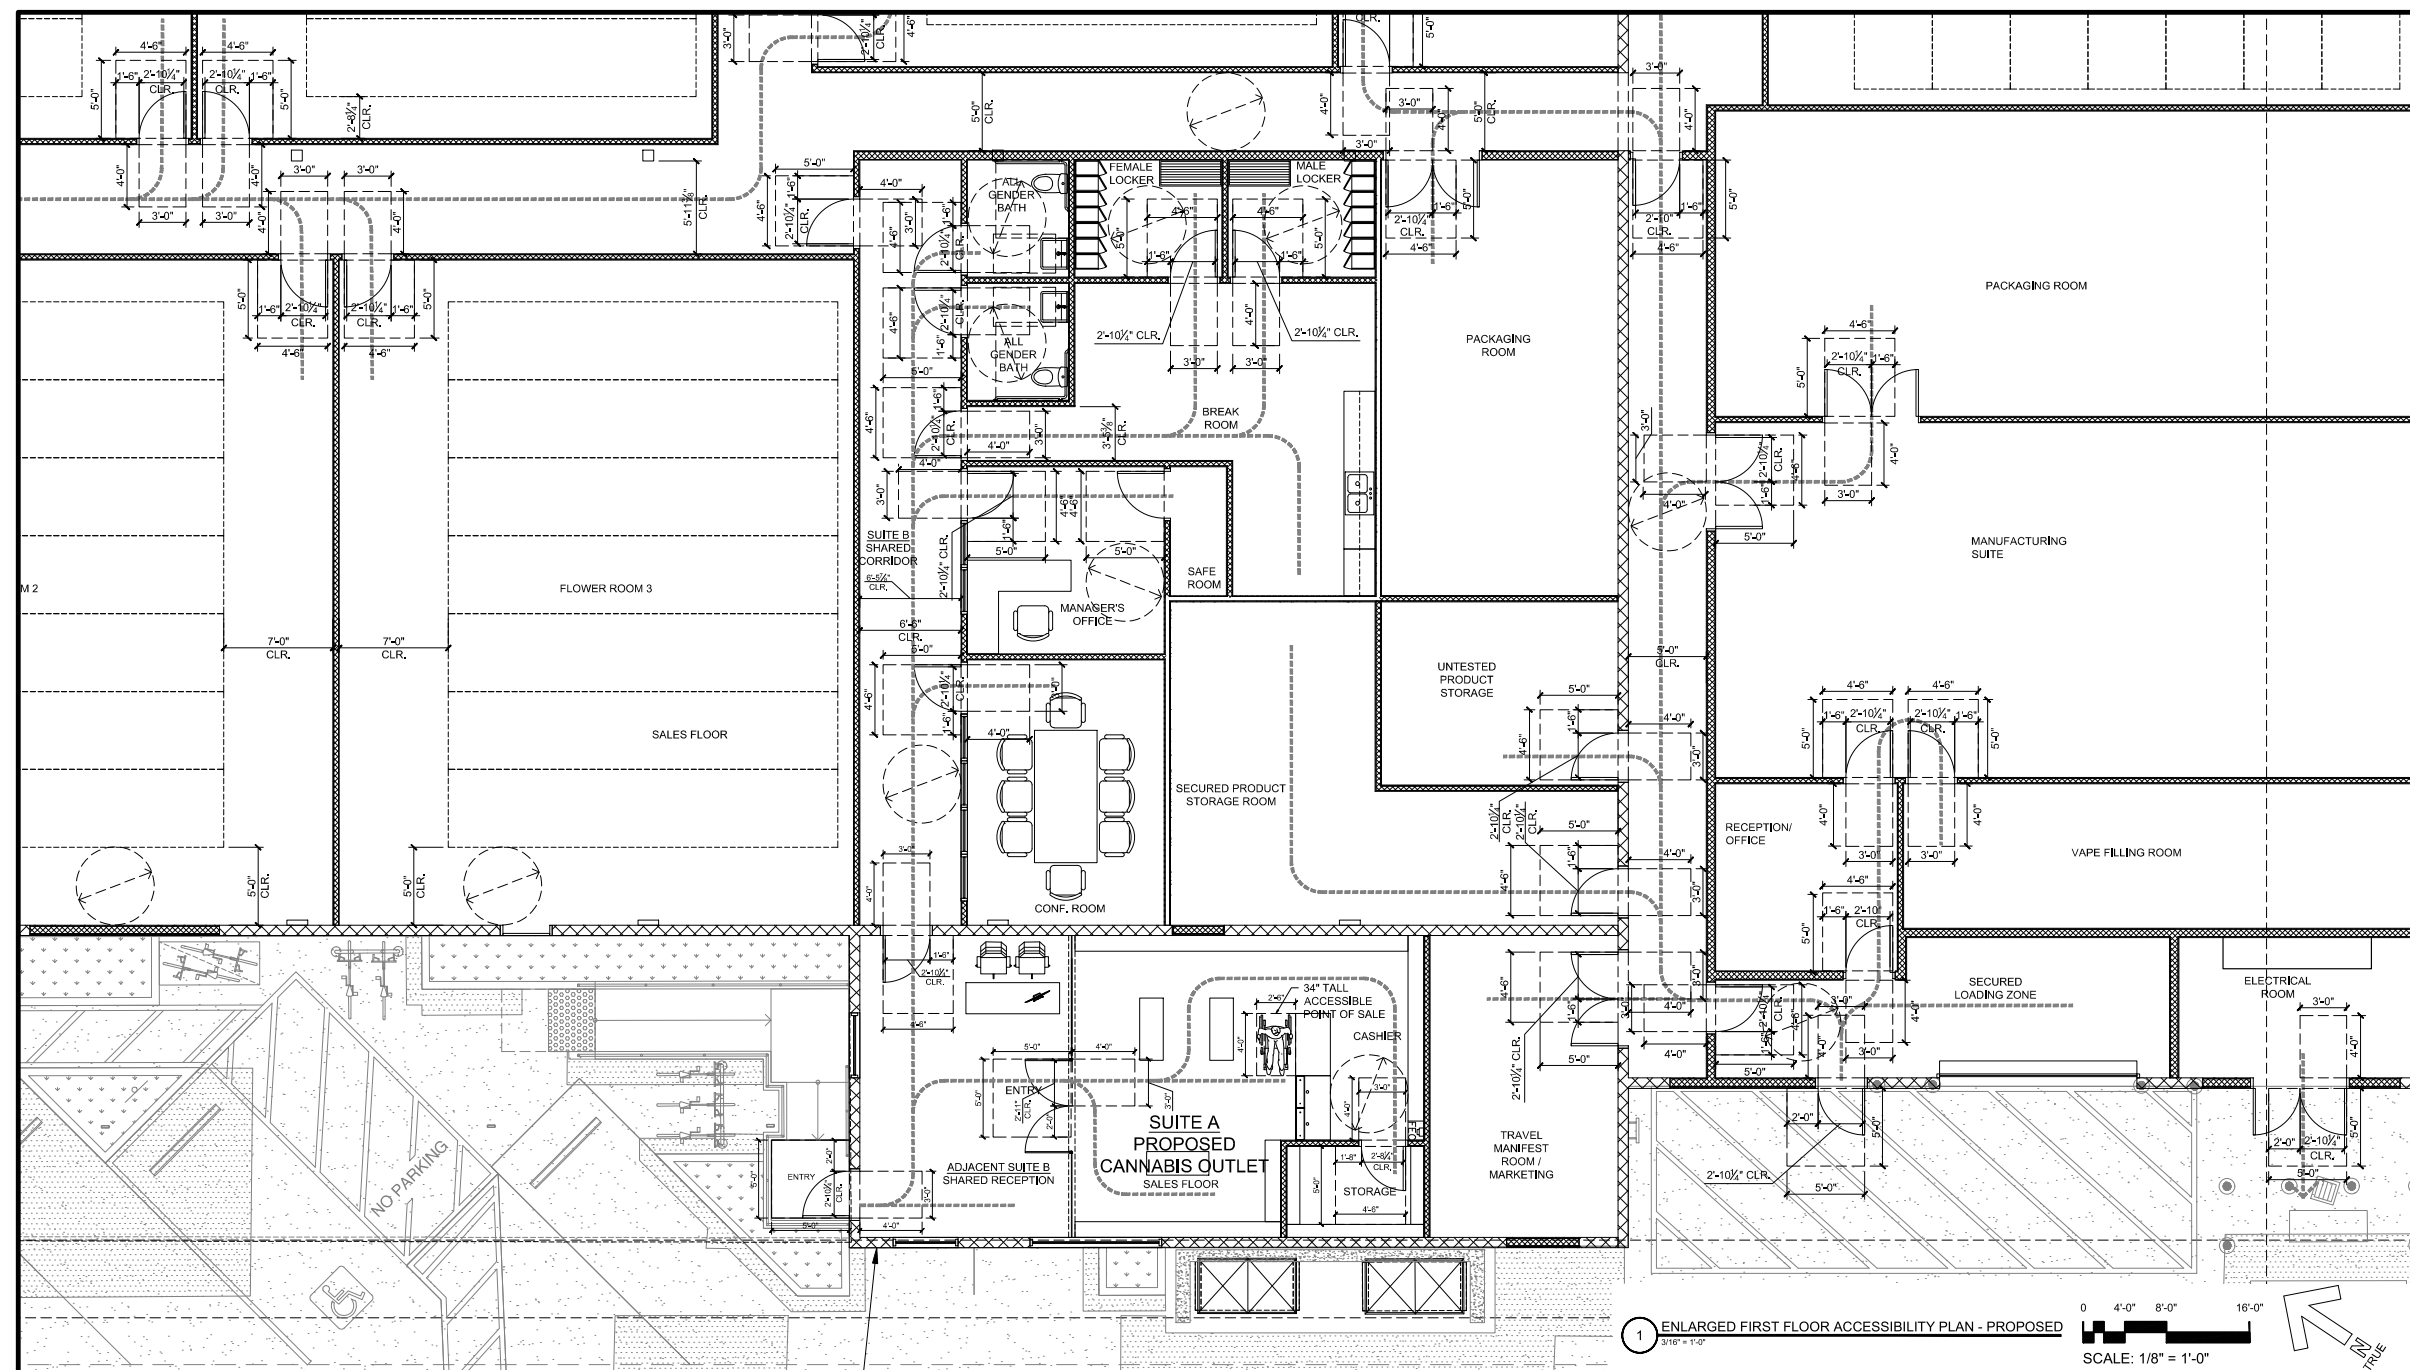ACCESSIBILITY PLAN LEGEND



ACCESSIBILITY NOTES

- At least one accessible route shall be provided within the site from accessible parking spaces and accessible passenger drop-off and loading zones; public streets and sidewalks; and public transportation stops to the accessible building or facility entrance they serve. Where more than one route is provided, all routes must be accessible. (CBC Sec. 11B-206.2.1)
- At least one accessible route shall connect accessible buildings, accessible facilities, accessible elements, and accessible spaces that are on the same site. (CBC Sec. 11B-206.2.2)
- At least one accessible route shall connect accessible building or facility entrances with all accessible spaces and elements within the building or facility, including mezzanines, which are otherwise connected by a circulation path unless exempted by CBC 2019 Section 11B-206.2.3 Exception 1 through 7. (CBC Sec. 11B-206.2.4)
- Handles, pulls, latches, locks, and other operable parts on doors and gates shall comply with CBC Section 11B-309.4. Operable parts of such hardware shall be 34 inches (864 mm) minimum and 44 inches (1118 mm) maximum above the finish floor or ground. Where sliding doors are in the fully open position, operating hardware shall be exposed and usable from both sides. (CBC Sec. 11B-404.2.7)
- Operable parts shall be operable with one hand and shall not require tight grasping, pinching, or twisting of the wrist. The force required to activate operable parts shall be 5 pounds (22.2 N) maximum. (CBC Sec. 11B-309.4)
- Door openings shall provide a clear width of 32 inches (813 mm) minimum. Clear openings of doorways with swinging doors shall be measured between the face of the door and the stop, with the door open 90 degrees. Openings more than 24 inches (610 mm) deep shall provide a clear opening of 36 inches (914 mm) minimum. There shall be no projections into the required clear opening width lower than 34 inches (864 mm) above the finish floor or ground. Projections into the clear opening width between 34 inches (864 mm) and 80 inches (2032 mm) above the finish floor or ground shall not exceed 4 inches (102 mm). (CBC Sec. 11B-404.2.3)
- Minimum maneuvering clearances at doors and gates shall comply with CBC Section 11B-404.2.4, Figure 11B-404.2.4.1 and Table 11B-404.2.4.1. Maneuvering clearances shall extend the full width of the doorway and the required latch side or hinge side clearance. (CBC Sec. 11B-404.2.4)
- Floor or ground surface within required maneuvering clearances shall be stable, firm, and slip resistant in compliance with CBC Section 11B-302. Changes in level are not permitted. (CBC Sec. 11B-404.2.4.4)
- Maneuvering clearances for forward approach shall be provided when any obstruction within 18 inches (457 mm) of the latch side of an interior doorway, or within 24 inches (610 mm) of the latch side of an exterior doorway, projects more than 8 inches (203 mm) beyond the face of the door, measured perpendicular to the face of the door or gate. (CBC Sec. 11B-404.2.4.3 and Fig. 11B-404.2.4.3)
- Thresholds, if provided at doorways, shall be as follows: Changes in level of 1/4 inch (6.4 mm) high maximum shall be permitted to be vertical and without edge treatment (CBC Sec. 11B-303.2) and changes in level between 1/4 inch (6.4 mm) high minimum and 1/2 inch (12.7 mm) high maximum shall be beveled with a slope not steeper than 1:2 (CBC Sec. 11B-303.3)
- Swinging door and gate surfaces within 10 inches (254 mm) of the finish floor or ground measured vertically shall have a smooth surface on the push side extending the full width of the door or gate. Parts creating horizontal or vertical joints in these surfaces shall be within 1/16 inch (1.6 mm) of the same plane as the other and be free of sharp or abrasive edges. Cavities created by added kick plates shall be capped. (CBC Sec. 11B-404.2.10)
- The force for pushing or pulling open a door or gate shall be as follows: Interior hinged doors and gates: 5 pounds (22.2 N) maximum; Sliding or folding doors: 5 pounds (22.2 N) maximum; Required fire doors: the minimum opening force allowable by the appropriate administrative authority, not to exceed 15 pounds (66.7 N); Exterior hinged doors: 5 pounds (22.2 N) maximum. These forces do not apply to the force required to retract latch bolts or disengage other devices that hold the door or gate in a closed position. (CBC Sec. 11B-404.2.9)
- Except as provided in CBC Sections 11B-403.5.2 and 11B-403.5.3, the clear width of walking surfaces shall be 36 inches (914 mm) minimum. (CBC Sec. 11B-403.5.1)
- Employee workstations shall be on an accessible route complying with Division 4. Spaces and elements within employee workstations shall only be required to comply with CBC Sections 11B-207.1, 11B-215.3, 11B-206.2.8, (CBC Sec. 11B-303.9)
- The clear width shall be permitted to be reduced to 32 inches (813 mm) minimum for a length of 24 inches (610 mm) maximum provided that reduced width segments are separated by segments that are 48 inches (1219 mm) long minimum and 36 inches (914 mm) wide minimum. (CBC Sec. 11B-403.5.1, exception 1)
- Exterior Exit doors shall have a sign posted above stating: THIS DOOR TO REMAIN UNLOCKED WHILE BUSINESS IS OCCUPYING.
- PROVIDE PANIC HARDWARE AT EXIT DOORS WHERE NOTED.
- Means of egress doors shall be readily distinguishable from the adjacent construction & finishes such that the doors are easily recognized. Mirrors or similar reflecting materials shall not be used on means of egress doors. Means of egress doors shall not be concealed by curtains, drapes, decorations or similar materials. (CBC Sec. 1010.1)
- Gates used as a component in a means of egress shall conform to the applicable requirements for doors. (CBC Sec. 1010.2)
- Door closers and gate closers shall be adjusted so that from an open position of 90 degrees, the time required to move the door to a position of 12 degrees from the latch is 5 seconds minimum. (CBC Sec. 11B-404.2.8.1)

ACCESSIBLE REACH RANGES NOTES

- Reach ranges shall comply with CBC Sec 11B-308
- Unobstructed forward reach:
 - High forward reach shall be a maximum of 48 inches and low forward reach shall be a minimum of 15 inches above finished floor.
- Obstructed high reach:
 - Where reach depth is a maximum 20 inches, high forward reach shall be a maximum of 48 inches above finished floor.
 - Where reach depth exceeds 20 inches, high forward reach maximum shall be 44 inches and reach depth maximum shall be 25 inches.
- Clear floor space extending underneath obstruction elements for a distance not less than required reach depth over obstruction.
- Where a parallel approach is allowed, unobstructed side reach shall be per CBC figure 11B-308.3.1
- High side reach shall be a maximum of 48 inches and minimum of 15 inches above finished floor.
- Where parallel approach is allowed, obstructed side reach shall be per CBC Figure 11B-308.3.2
- Height of obstruction 34 inches maximum.
- Depth of obstruction 24 inches maximum.
- Where reach depth is a maximum of 20 inches, high side reach maximum shall be 48 inches.
- Where reach depth exceeds 20 inches, high side reach maximum shall be 46 inches and reach depth maximum shall be 24 inches.

EGRESS & ACCESSIBILITY NOTES

- ACCESSIBLE ROUTE - Accessible routes shall comply with CBC Section 11B-402. Walking surfaces shall provide clearances complying with CBC Section 11B-403.5. The running slope of walking surfaces shall not be steeper than 1:20. The cross slope of walking surfaces shall not be steeper than 1:48 per CBC Section 11B-403.3. Except as provided in CBC Sections 11B-403.5.2 and 11B-403.5.3, the clear width of walking surfaces shall be 36 inches (914 mm) minimum. The clear width for walking surfaces in corridors serving an occupant load of 10 or more shall be 44 inches (1118 mm) minimum. The clear width for sidewalks and walks shall be 48 inches (1219 mm) minimum.
- MEANS OF EGRESS - A continuous and unobstructed path of vertical and horizontal egress travel from any occupied portion of a building or structure to a public way. A means of egress consists of three separate and distinct parts: the exit access, the exit and the exit discharge. Means of Egress shall comply with CBC Chapter 10.
- DESIGN OCCUPANT LOAD - The number of occupants whom means egress facilities shall be provided. Where occupants from accessory area egress through a primary space, the calculated occupant load for the primary space shall include the total occupant load of the primary space plus the number of occupants egressing through it from the accessory area.
- MINIMUM EGRESS WIDTH - The total width of means of egress in inches (mm) shall not be less than the total occupant load served by the means of egress multiplied by 0.3 inches (7.62 mm) per occupant for stairways and by 0.2 inches (5.08 mm) per occupant for other egress components. Multiple means of egress shall be sized such that the loss of any one means of egress shall not reduce the available capacity to less than 50 percent of the required capacity. The maximum capacity required from any story of a building shall be maintained to the termination of the means of egress. (CBC Sec. 1005.1)
- DOOR ENCROACHMENT - Doors, when fully opened, and handrails shall not reduce the required means of egress width by more than 7 inches (178 mm). Doors in any position shall not reduce the required width by more than one-half. Other nonstructural projections such as trim and similar decorative features shall be permitted to project into the required width a maximum of 1 1/2 inches (38 mm) on each side. (CBC Sec. 1005.7)
- EGRESS - Egress doors must be readily openable from egress side without use of a key or any special knowledge or effort. (CBC Sec. 1010.1.9) Unlatching any door or leaf shall not require more than one operation. (CBC Sec. 1010.1.9.6)
- EXIT SIGNS - Exit signs shall be internally and externally illuminated at all times. Externally illuminated exit signs shall be connected to an emergency power system (batteries, unit equipment or an on-site generator) that will automatically illuminate the exit signs for a duration of not less than 90 minutes in case of primary loss. (CBC Sec. 1013.1, 1013.3, 1013.6.3)
- EGRESS ILLUMINATION - The means of egress, including the exit discharge, shall be illuminated to a level of not less than 1 footcandle (11 lux) at the walking surface at all times the building space served by the means of egress is occupied. (CBC Sec 1008.2.1)
- ILLUMINATION EMERGENCY POWER - The power supply for means of egress illumination shall normally be provided by the premises' electrical supply. (CBC Sec 1008.3)
- In the event of power supply failure in buildings that require two or more means of egress, an emergency electrical system shall automatically illuminate all of the following areas:
 - Interior exit access stairways and ramps.
 - Interior and exterior exit stairways and ramps.
 - Exit passageways.
 - Vestibules and areas on the level of discharge used for exit discharge in accordance with CBC Section 1028.1.
 - Exterior landings as required by CBC Section 1010.1.6 for exit doorways that lead directly to the exit discharge. (CBC Sec. 1008.3.2)
- The emergency power system shall provide power for a duration of not less than 90 minutes and shall consist of storage batteries, unit equipment or an on-site generator. The installation of the emergency power system shall be in accordance with CBC Section 2702. (CBC Sec 1008.3.4)
- Illumination level under emergency power. Emergency lighting facilities shall be arranged to provide initial illumination that is at least an average of 1 footcandle (11 lux) and a minimum at any point of 0.1 footcandle (1.1 lux) measured along the path of egress at floor level. Illumination levels shall be permitted to decline to 0.6 footcandle (6 lux) average and a minimum at any point of 0.06 footcandle (0.6 lux) at the end of the emergency lighting time duration. A maximum-to-minimum illumination uniformity ratio of 40 to 1 shall not be exceeded. (CBC Sec. 1008.3.5)
- This facility will not utilize delayed egress components or systems.

01	09.06.22	Completeness Review Submittal
02	12.13.22	Conditional Use Permit - 2nd Submittal
03	01.11.23	Conditional Use Permit - 3rd Submittal

MARK	DATE	DESCRIPTION
PROJECT NO:	2206	
CAD DWG FILE:	A105-A108 FIRST FLOOR EGRESS, ACCESSIBILITY PLAN - PROPOSED.rvt	
DRAWN BY:	ABHAY SCHWEITZER, C.G., S.V., D.V., J.A.	
CHK'D BY:	ABHAY SCHWEITZER, MICHAEL R. MORTON	

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ENL. 1ST FLOOR ACCESSIBILITY PLAN - PROPOSED
A106
SHEET 8 OF 22

CONSULTANTS


01-11-2023



4909 Pacific Highway,
San Diego, CA 92110

OWNER

RAP Holdings, LLC & United Partners,
LLC

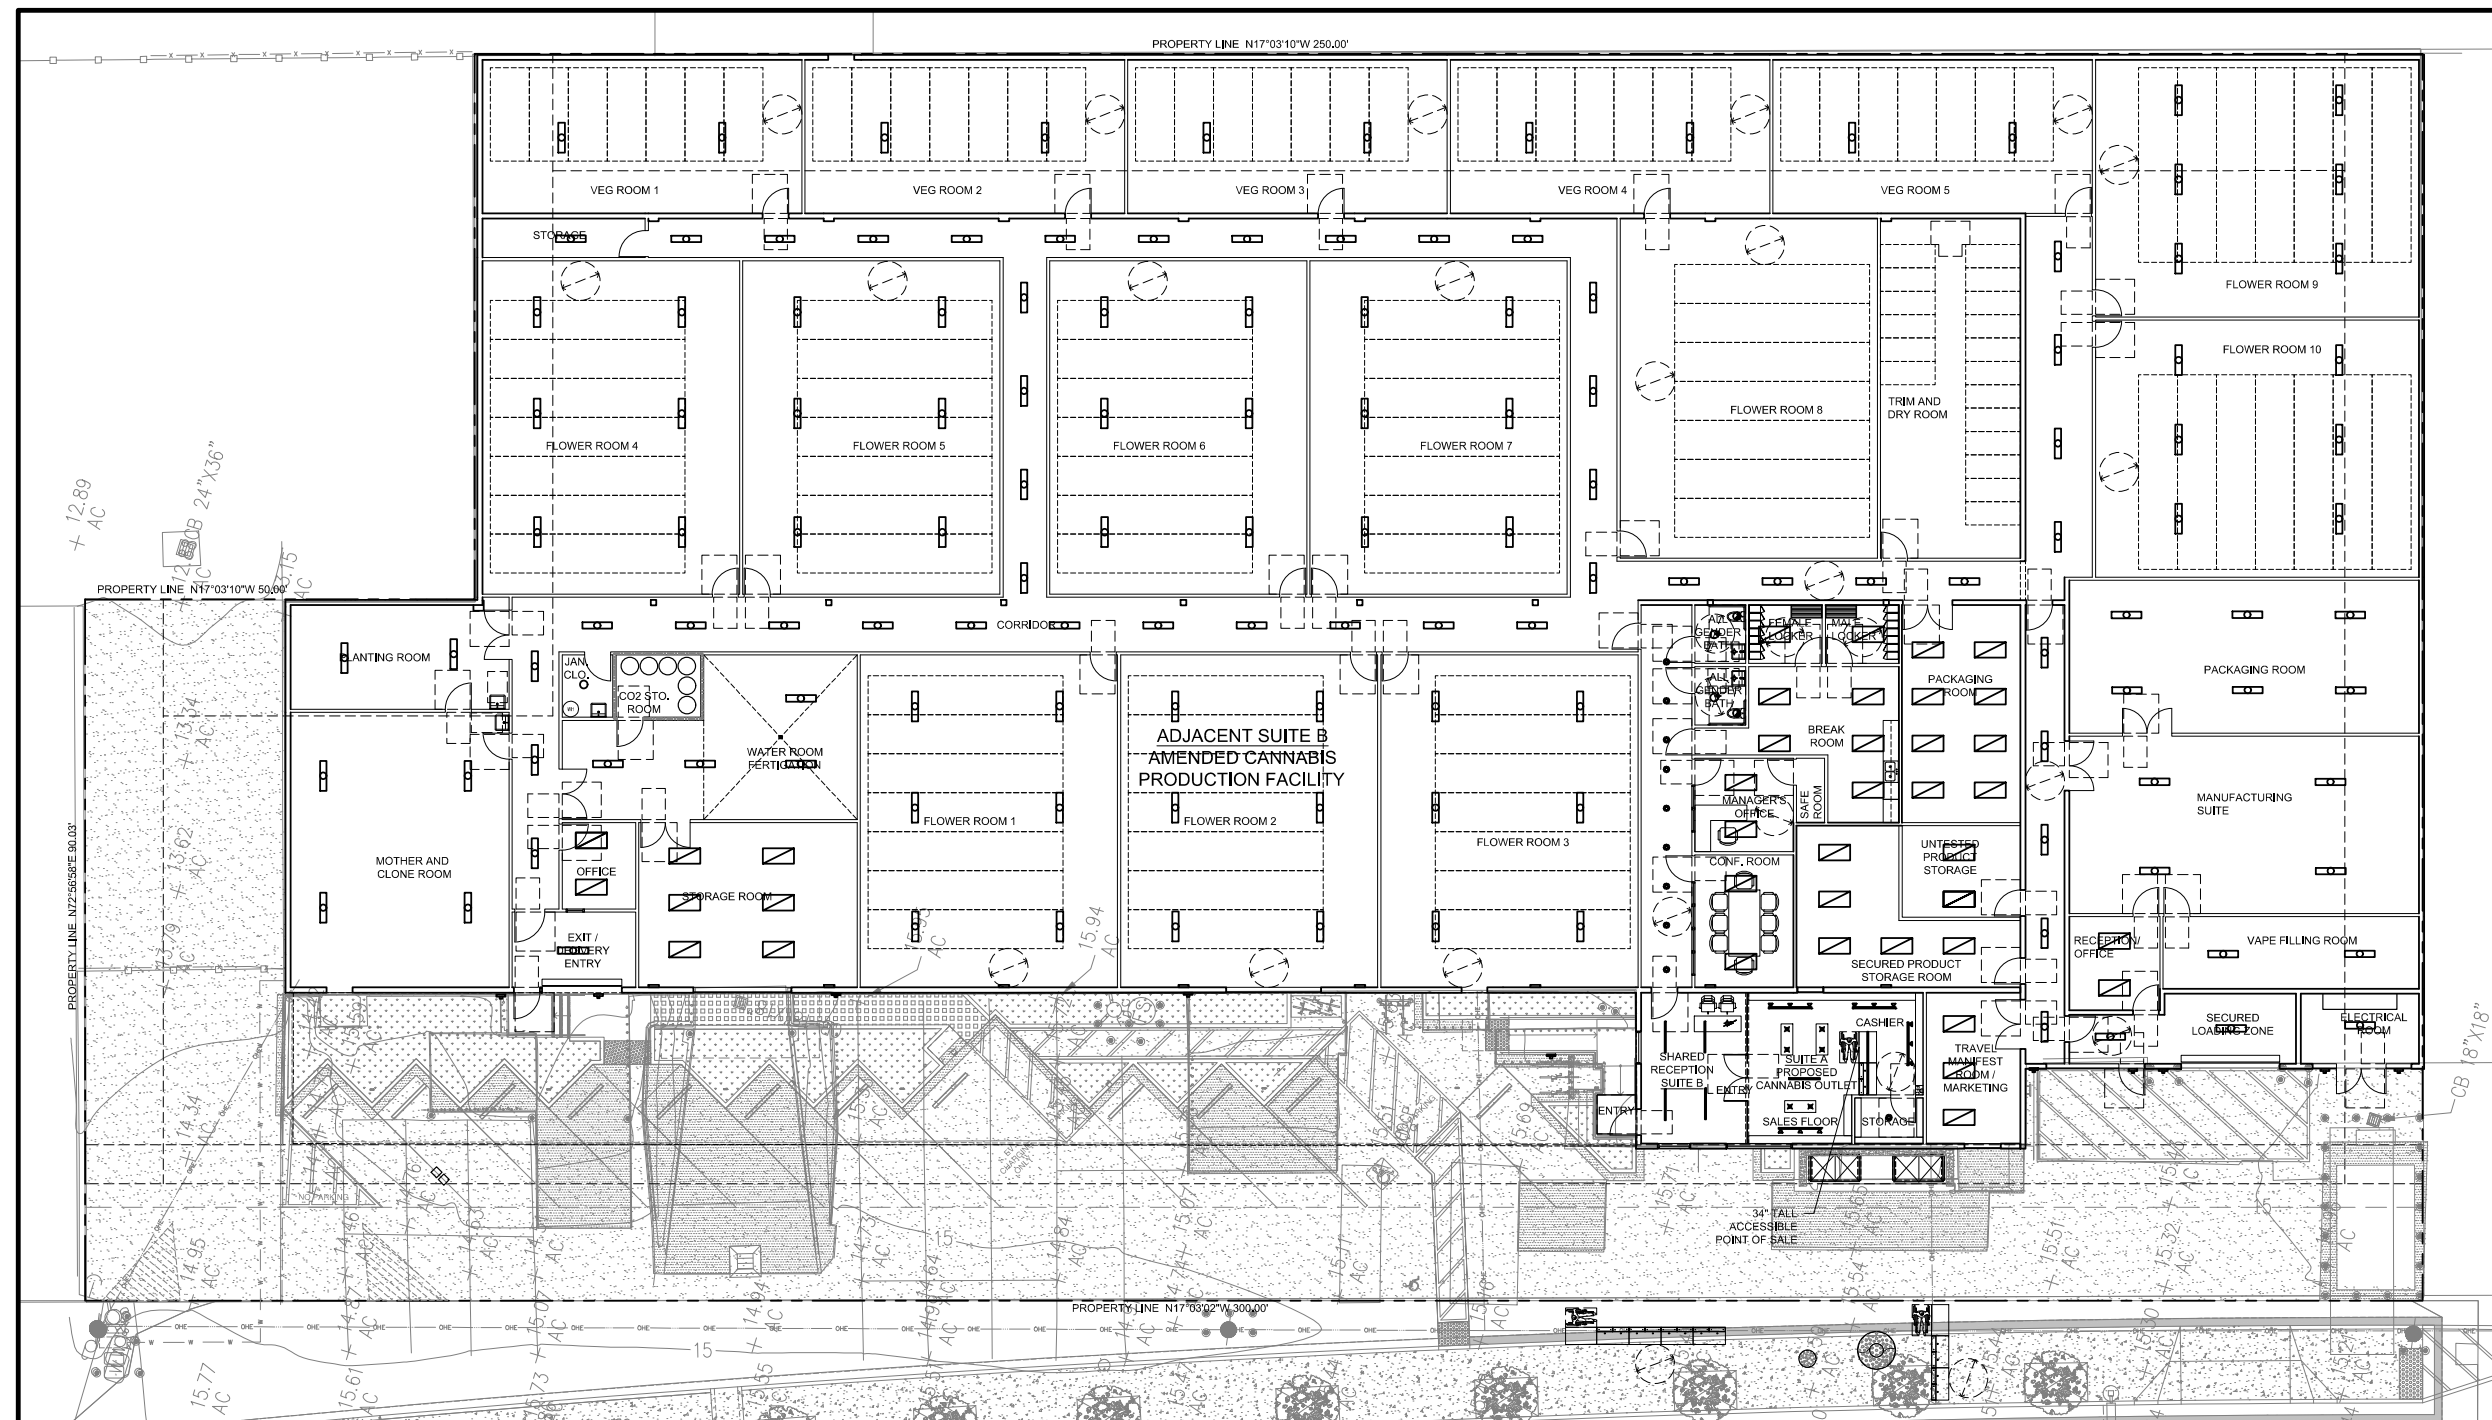

LIGHTING PLAN LEGEND

- EXHAUST FAN COMBO
- 4" DIAMETER RECESSED LED DOWNLIGHT
- 4" DIAMETER DECORATIVE / SEMI RECESSED LED LIGHT
- PENDANT LIGHT
- 2" x 48" SURFACE / SUSPENDED LINEAR LED
- TRACK LIGHTING / LED SPOTS
- 6" LED COMMERCIAL DOWNLIGHT
- 4" EXPLOSION PROOF LED
- RECESSED LED - EMERGENCY BATTERY
- LED LOW PROFILE WRAP
- ▼ FLOOD LIGHT

LIGHTING PLAN NOTES

- A. ALL PARKING AREAS SHALL BE ILLUMINATED
- B. ALL AREAS AROUND THE BUILDING SHALL BE ILLUMINATED
- C. LIGHTING SHALL BE SHIELD SO AS TO NOT ILLUMINATE ADJACENT PROPERTIES

01	09.06.23	Completeness Review Submittal
02	12.13.23	Conditional Use Permit - 2nd Submittal
03	01.11.23	Conditional Use Permit - 3rd Submittal

MARK DATE DESCRIPTION

PROJECT NO:	2206
CAD DWG FILE:	A107 FIRST FLOOR LIGHTING PLAN - PROPOSED-B.DWG
DRAWN BY:	ABHAY SCHWEITZER, C.G., S.V., D.V., J.A.
CHK'D BY:	ABHAY SCHWEITZER, MICHAEL R. MORTON


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SHEET TITLE

FIRST FLOOR
LIGHTING PLAN -
PROPOSED

A107

1 FIRST FLOOR LIGHTING PLAN - PROPOSED
SCALE: 3/32" = 1'-0"

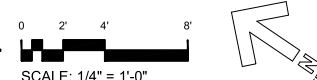


CONSULTANTS


01-11-2023



4909 Pacific Highway,
San Diego, CA 92110
OWNER
RAP Holdings, LLC & United Partners,
LLC

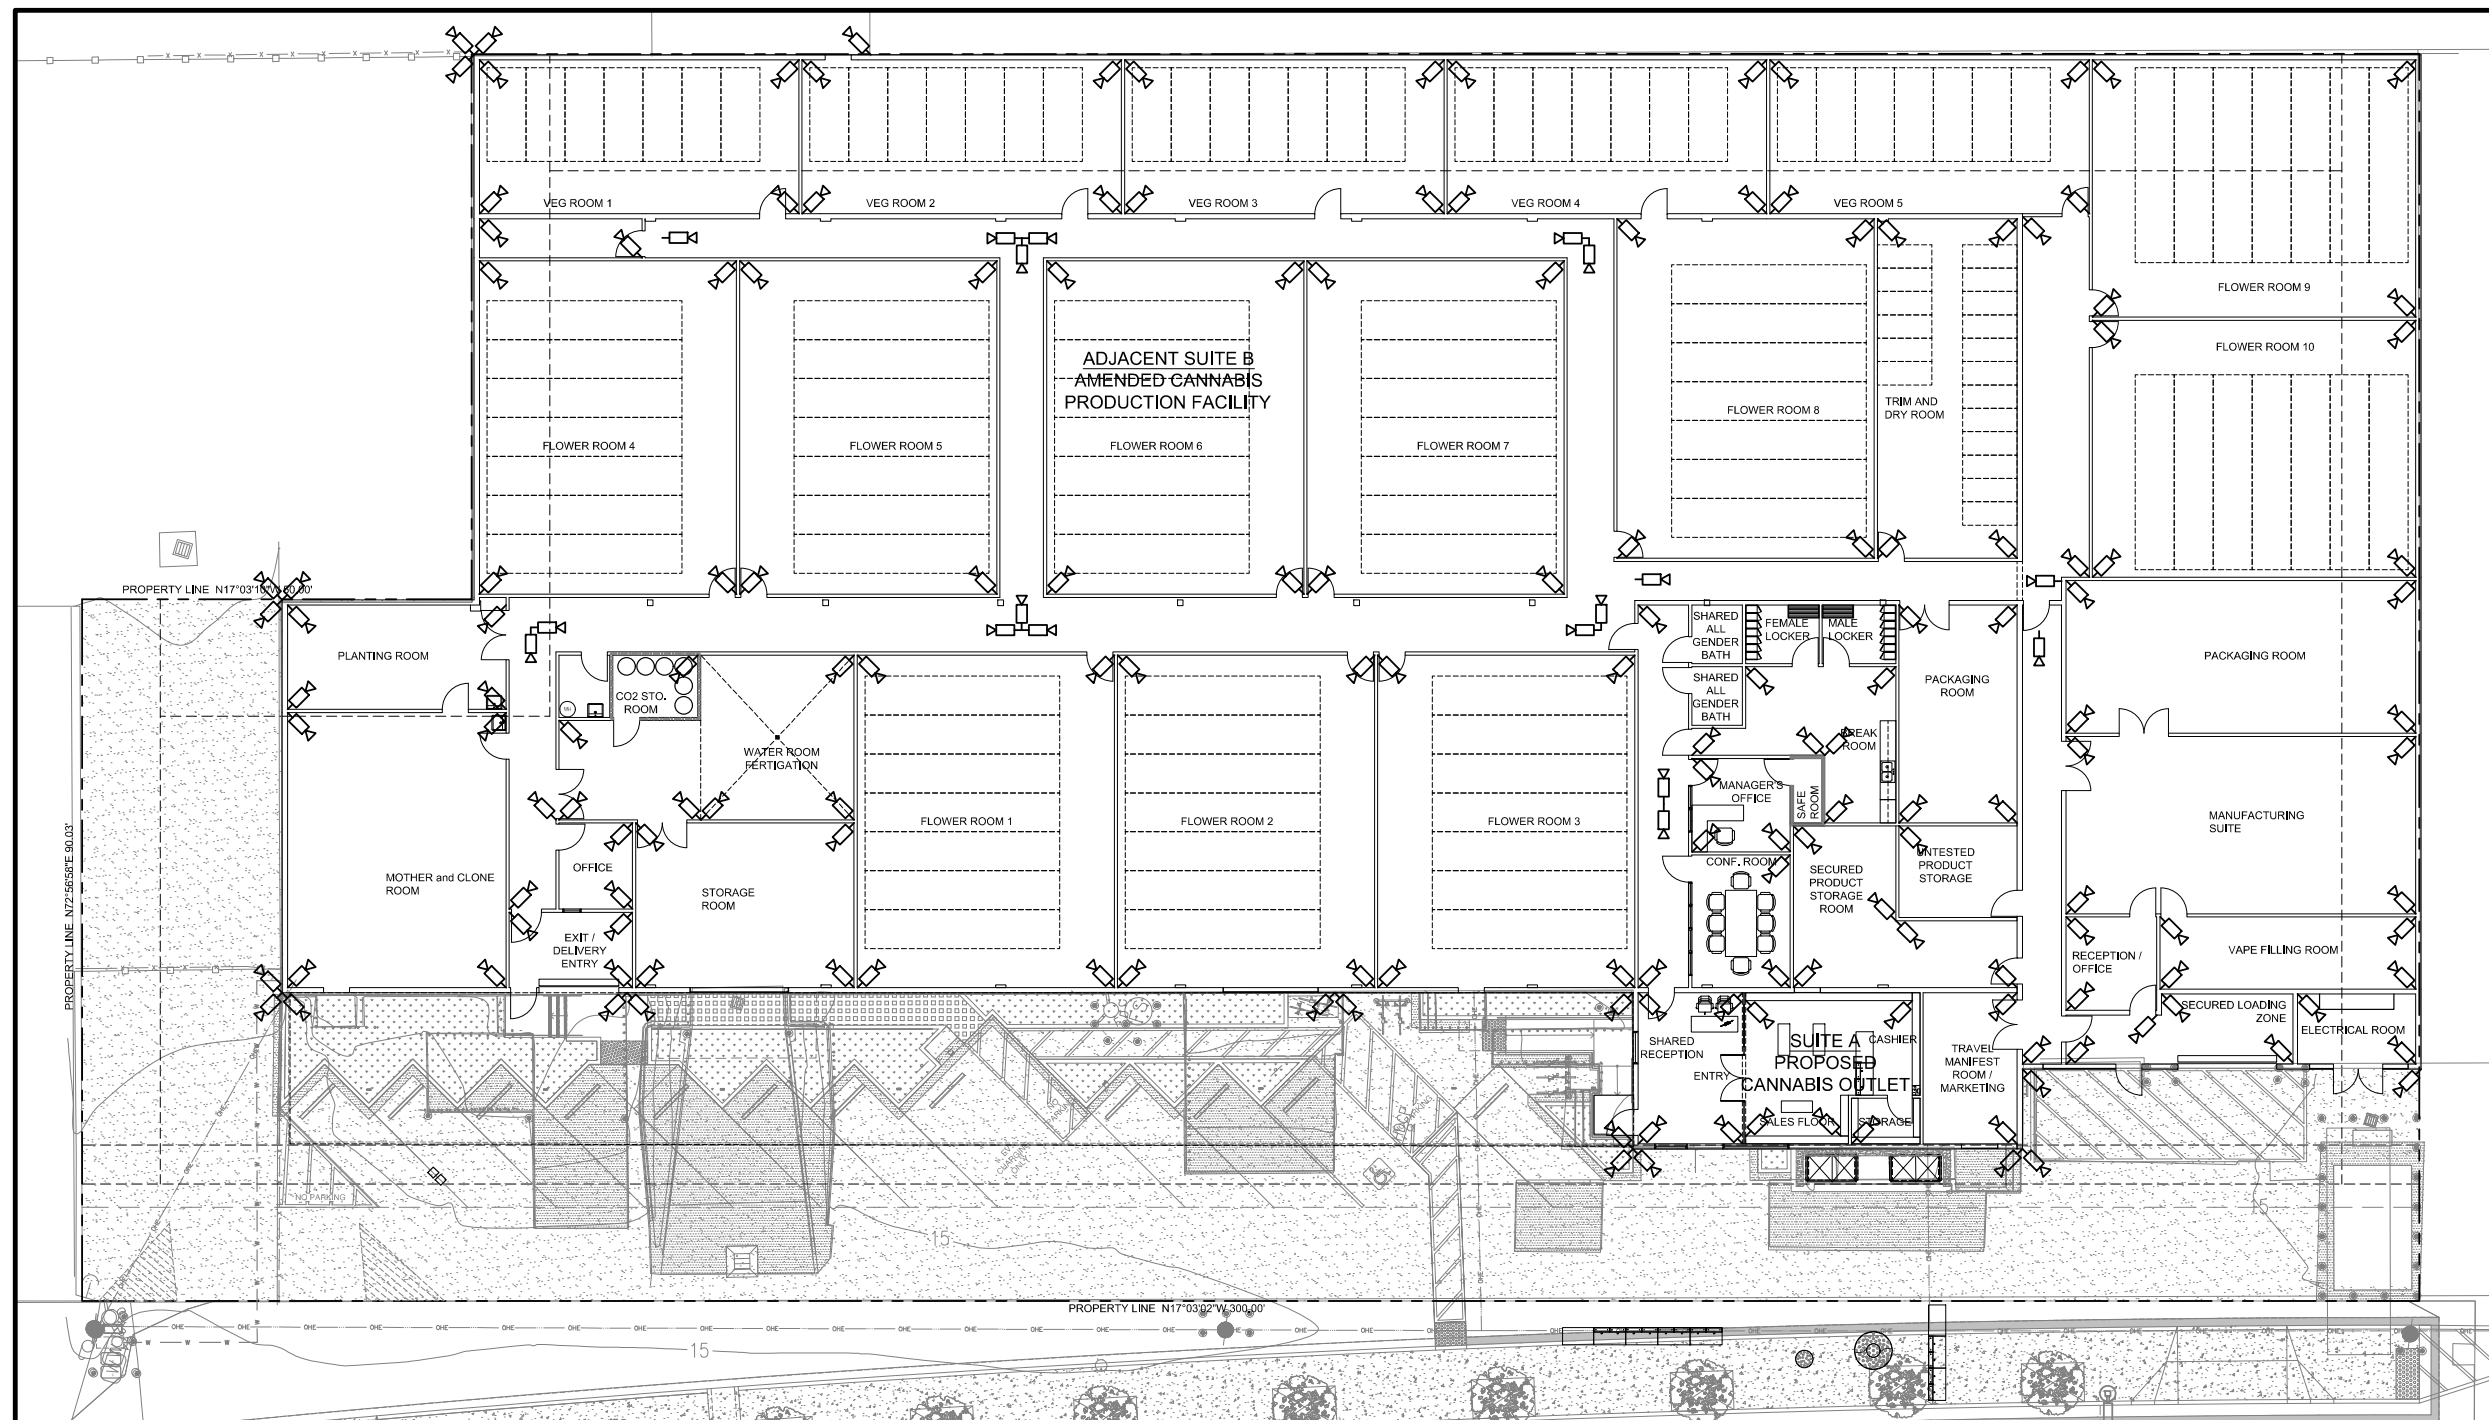

1 FIRST FLOOR SECURITY PLAN - PROPOSED
SCALE: 3/32" = 1'-0"

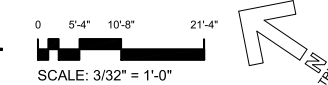

SECURITY PLAN LEGEND

- SECURITY CAMERA
- 167 - INTERIOR SECURITY CAMERAS
- 22 - EXTERIOR SECURITY CAMERAS
- LEVEL 1 BULLET RESISTANT WALL

SECURITY MEASURES

- THIS PROJECT PROPOSES TO IMPLEMENT THE FOLLOWING SECURITY MEASURES:
1. OPERABLE CAMERAS (On-site and off-site monitoring with remote backup)
 2. ALARMS
 3. LICENSED SECURITY GUARD DURING BUSINESS HOURS
 4. BULLET RESISTANT ASSEMBLIES TO PROTECT EMPLOYEES
 5. METAL DETECTORS
 6. "MAN TRAP" TYPE EXIT
 7. BULLET RESISTANT BARRIERS AROUND BUILDING, IN PARKING AREAS AND IN ADJACENT SIDEWALKS.
 8. SECURITY SHALL INCLUDE OPERABLE CAMERAS, ALARMS, AND A SECURITY GUARD. THE SECURITY GUARD SHALL BE LICENSED BY THE STATE OF CALIFORNIA AND BE PRESENT ON THE PREMISES DURING BUSINESS HOURS. THE SECURITY GUARD SHALL ONLY BE ENGAGED IN ACTIVITIES RELATED TO PROVIDING SECURITY FOR THE FACILITY, EXCEPT ON AN INCIDENTAL BASIS.

MARK	DATE	DESCRIPTION
01	09.06.22	Completeness Review Submittal
02	12.13.22	Conditional Use Permit - 2nd Submittal
03	01.11.23	Conditional Use Permit - 3rd Submittal

PROJECT NO: 2206
CAD DWG FILE: A108 FIRST FLOOR SECURITY PLAN - PROPOSED DWG
DRAWN BY: ABHAY SCHWEITZER, C.G., S.V., D.V., J.A.
CHK'D BY: ABHAY SCHWEITZER, MICHAEL R. MORTON

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SHEET TITLE
FIRST FLOOR SECURITY PLAN - PROPOSED

CONSULTANTS


01-11-2023




4909 Pacific Highway,
San Diego, CA 92110

OWNER

RAP Holdings, LLC & United Partners,
LLC

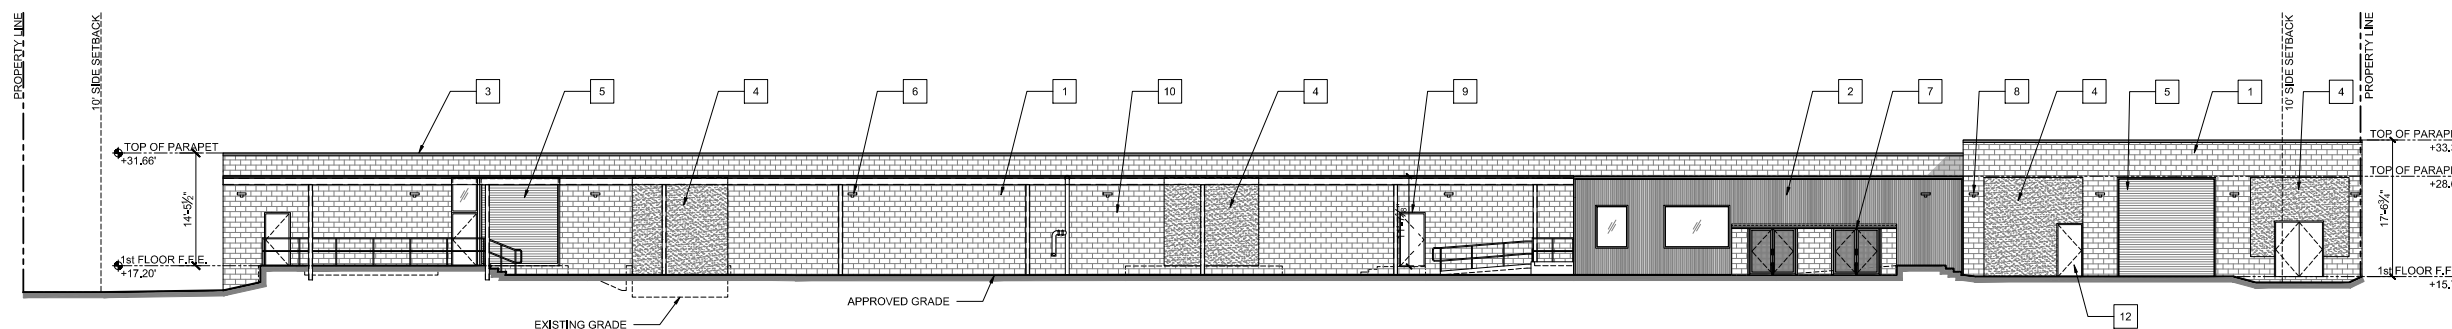

1 WEST ELEVATION - APPROVED
SCALE: 3/32"=1'-0"

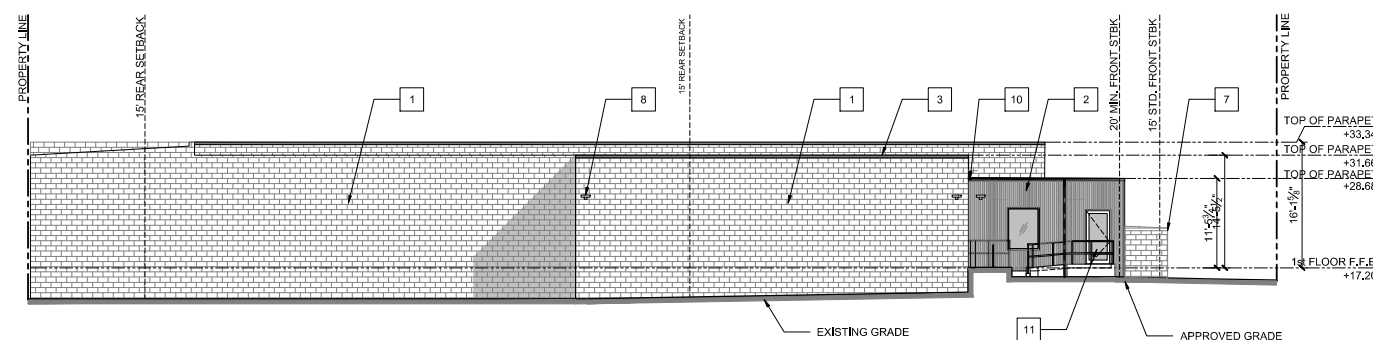

2 NORTH ELEVATION - APPROVED
SCALE: 3/32"=1'-0"

ELEVATION KEYNOTES

1. Existing CMU wall; Painted white.
2. Approved corrugated metal; dark charcoal gray.
3. Approved metal framed sunshade; black.
4. Approved stucco finish; white matching the existing CMU Block wall.
5. Existing roll up door; dark charcoal gray
6. Approved commercial flood lights; Black
7. Approved trash enclosure
8. Approved security light
9. Existing door to remain. Door to be remain locked at all times.
10. Approved carport supports.
11. Approved door to be used as common entry.
12. Approved door to be used as staff entry.

ELEVATION NOTES

Elevations shown are relative to sea level.

01	09.06.23	Completeness Review Submittal
02	12.13.23	Conditional Use Permit - 2nd Submittal
03	01.11.23	Conditional Use Permit - 3rd Submittal

MARK	DATE	DESCRIPTION
01	09.06.23	01

PROJECT NO: 2206

CAD DWG FILE: A201-A202 EXTERIOR ELEVATIONS - APPROVED EXTERIOR ELEVATIONS

DRAWN BY: ABHAY SCHWEITZER, C.G., S.V., D.V., J.A.

CHK'D BY: ABHAY SCHWEITZER, MICHAEL R. MORTON

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SHEET TITLE

EXTERIOR
ELEVATIONS -
APPROVED

A201




2934 Lincoln Ave., San Diego, CA 92104
 techne-us.com sustainablearchitecture.org
 619-940-5814 313-595-5814

CONSULTANTS



4909 Pacific Highway,
 San Diego, CA 92110
 OWNER
 RAP Holdings, LLC & United Partners,
 LLC

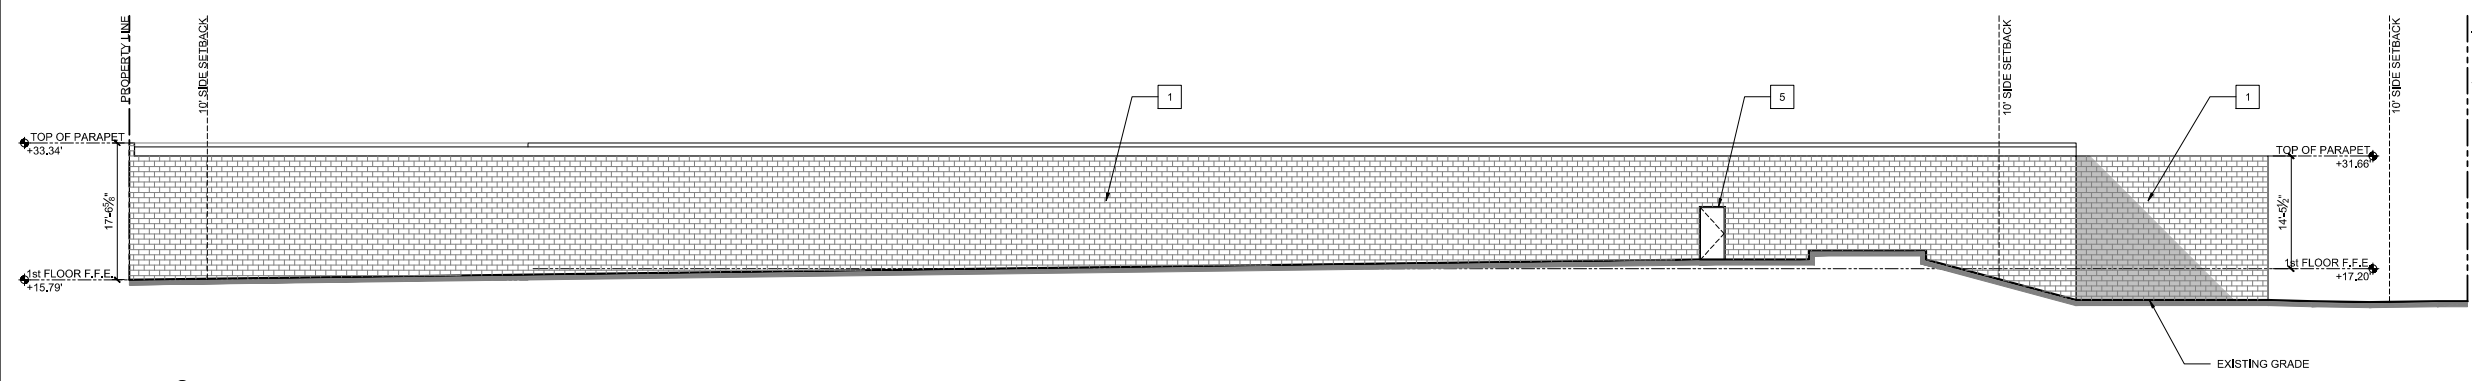

1 EAST ELEVATION - APPROVED
 SCALE: 3/32"=1'-0"

ELEVATION KEYNOTES

1. Existing CMU wall; Painted White
2. Not Used
3. Not Used
4. Not Used
5. Existing door to remain. Door to be remain locked at all times.

01	09.06.22	Completeness Review Submittal
02	12.13.22	Conditional Use Permit - 2nd Submittal
03	01.11.23	Conditional Use Permit - 3rd Submittal

MARK	DATE	DESCRIPTION

PROJECT NO: 2206
 CAD DWG FILE: A201-A202 EXTERIOR ELEVATIONS - APPROVED EXTERIOR ELEVATIONS
 DRAWN BY: ABHAY SCHWEITZER, C.G., S.V., D.V., J.A.
 CHK'D BY: ABHAY SCHWEITZER, MICHAEL R. MORTON

ELEVATION NOTES

Elevations shown are relative to sea level.

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SHEET TITLE
**EXTERIOR
 ELEVATIONS -
 APPROVED**

A202

GRADING AND DRAINAGE NOTES

- TRENCH BACKFILL SHALL BE IN ACCORDANCE WITH THE STANDARD SPECIFICATIONS FOR PUBLIC WORKS CONSTRUCTION (2012 EDITION) FOR MECHANICALLY COMPACTED BACKFILL. HAND DIRECTED MECHANICAL TAMPERS SHALL BE THE PREFERRED METHOD OF COMPACTION.
- SITE GRADING SHALL BE PERFORMED IN ACCORDANCE WITH THE STANDARD SPECIFICATIONS FOR PUBLIC WORKS CONSTRUCTION (2012 EDITION) AND THESE PLANS.
- ALL FILLS IN EXCESS OF 12" IN DEPTH SHALL BE COMPACTED AND TESTED TO 90% RELATIVE COMPACTION.
- FINISH GRADE SHALL BE INSPECTED BY THE ENGINEER OF WORK AND VERIFIED THAT THE ACTUAL GRADING IS REPRESENTATIVE OF THE PROPOSED GRADING AND THAT THE MINIMUM SLOPE GRADIENTS EXIST.
- THE MINIMUM GRADIENT FOR GRADED SWALES SHALL BE 1.0%, UNLESS OTHERWISE NOTED.
- THE MINIMUM GRADIENT OF FINISH GRADE AWAY FROM STRUCTURES SHALL BE 2% UNLESS OTHERWISE NOTED ON PLANS.
- FINISH GRADE SHALL BE DETERMINED AS THE ELEVATION OF ANY LANDSCAPE MATERIAL PLACED ON GRADE. IT IS THE CONTRACTOR'S RESPONSIBILITY TO UNDER CUT GRADE TO ALLOW FOR PLACEMENT OF LANDSCAPE MATERIALS.
- IT SHALL BE THE RESPONSIBILITY OF THE CONTRACTOR TO HANDLE ANY EXPORT OF EXCESS MATERIAL FOR THE SITE. RESPONSIBILITY TO INCLUDE ALL PERMITS AND APPROVALS BY THE APPROPRIATE AGENCIES, THE OWNER AND ENGINEER OF WORK WILL NOT ASSUME ANY RESPONSIBILITY FOR THE REMOVAL, TRANSPORTATION OR PLACEMENT OF EXCESS MATERIAL.
- THE CONTRACTOR SHALL BE RESPONSIBLE TO VERIFY LOCATION OF EXISTING UTILITIES AND TAKE PRECAUTIONS TO PROTECT UTILITIES AS NECESSARY.
- LOCATIONS AND ELEVATIONS OF EXISTING IMPROVEMENTS TO BE JOINED BY PROPOSED CONSTRUCTION SHALL BE VERIFIED BY FIELD MEASUREMENT PRIOR TO BEGINNING NEW CONSTRUCTION.
- NO LANDSCAPING SHALL BE PLACED AS TO INTERFERE WITH THE POSITIVE DRAINAGE OF SWALES TO CATCH BASINS OR AREA DRAINS.
- AFTER COMPLETION OF CONSTRUCTION AND ACCEPTANCE FROM THE OWNER, ALL DRAINAGE FACILITIES SHALL BE CONTINUALLY MAINTAINED BY THE OWNER WITH MONTHLY INSPECTIONS OF CATCH BASINS, DRAIN LINES, EARTH SWALES, AND CONCRETE DITCHES BEING MADE TO INSURE THE DRAIN SYSTEM IS IN WORKING ORDER AND FREE FROM OBSTRUCTIONS AND SILTATION.
- ALL DRAINAGE FACILITIES SHALL BE INSTALLED PRIOR TO THE INSTALLATION OF ANY SURFACE IMPROVEMENTS, I.E., CONCRETE FLAT WORK.
- REMOVE AND REPLACE TURF AND LANDSCAPE AREAS IN KIND, REGRADE AREA TO DRAIN. DO NOT DISTURB TREES AND SHRUBS WHERE POSSIBLE.
- ANY IRRIGATION LINES IN CONFLICT WITH THE PROPOSED IMPROVEMENTS SHALL BE RELOCATED OR RESTORED BY THE CONTRACTOR.
- IF SLOPE TO BE REGRADED IS TO BE REPLANTED, PLANT MATERIAL TO BE PLANTED TO OWNER'S STANDARDS.
- REGARDLESS OF ELEVATIONS INDICATED ON THESE PLANS, THE CONTRACTOR SHALL MAINTAIN POSITIVE FLOWS AT THE MINIMUM SLOPE GRADIENTS OF THE EXISTING SURFACE.

GENERAL NOTES

- EXISTING UNDERGROUND FACILITIES AND UTILITIES ARE PLOTTED FROM RECORD DRAWINGS. THE EXACT LOCATION OF EXISTING FACILITIES WITHIN THE CONSTRUCTION AREA SHALL BE VERIFIED AND CONFIRMED BY THE CONTRACTOR. NEITHER THE ENGINEER OF WORK, NOR THE OWNER ASSUME RESPONSIBILITY FOR THE ACCURACY OF THE RECORD DRAWINGS. CONTRACTOR SHALL BE RESPONSIBLE TO PROTECT EXISTING UTILITIES AS NECESSARY.
- CONTRACTOR SHALL REQUEST AND / OR PROVIDE MARK-OUT OF ALL EXISTING FACILITIES PRIOR TO ANY EXCAVATION.
- IF IN THE EVENT OF A CONFLICT WITH ANY EXISTING FACILITIES, CONTRACTOR SHALL DISCONTINUE WORK AND IMMEDIATELY NOTIFY THE ENGINEER OF WORK OF THE CONFLICT. THE ENGINEER OF WORK SHALL, IN A TIMELY MANNER, REVIEW THE CONFLICT AND MAKE RECOMMENDATIONS FOR RESOLUTION.
- THE ENGINEER OF WORK ASSUMES NO LIABILITY FOR JOB SAFETY.
- ALL UNDERGROUND UTILITIES SHALL BE CONSTRUCTED, CONNECTED AND TESTED PRIOR TO CONSTRUCTION OF BERM, CURB, CROSS GUTTER AND PAVING.
- LOCATION AND ELEVATION OF IMPROVEMENTS TO BE MET BY WORK TO BE DONE SHALL BE CONFIRMED BY FIELD MEASUREMENTS PRIOR TO CONSTRUCTION OF NEW WORK. CONTRACTOR SHALL HIRE A UTILITY DETECTION SERVICE, MAKE EXPLORATORY EXCAVATIONS AND LOCATE EXISTING UNDERGROUND FACILITIES SUFFICIENTLY AHEAD OF CONSTRUCTION TO PERMIT REVISIONS TO PLANS IF REVISIONS ARE NECESSARY BECAUSE OF ACTUAL LOCATION OF EXISTING FACILITIES.
- THE CONTRACTOR SHALL NOTIFY THE SAN DIEGO GAS AND ELECTRIC COMPANY PRIOR TO STARTING WORK NEAR COMPANY FACILITIES AND SHALL COORDINATE HIS WORK WITH COMPANY REPRESENTATIVES.
- THE CONTRACTOR SHALL NOTIFY AT&T COMPANY PRIOR TO STARTING WORK NEAR COMPANY FACILITIES AND SHALL COORDINATE HIS WORK WITH COMPANY REPRESENTATIVES.
- THE CONTRACTOR SHALL NOTIFY CABLE COMMUNICATIONS PRIOR TO STARTING WORK NEAR COMPANY FACILITIES AND SHALL COORDINATE HIS WORK WITH COMPANY REPRESENTATIVES.
- IT SHALL BE THE RESPONSIBILITY OF THE OWNER TO CONTACT THE UTILITY AGENCIES, ADVISE THEM OF THE PROPOSED IMPROVEMENTS AND BEAR THE COST OF RELOCATIONS, IF NEEDED.

ABBREVIATIONS

APN	INDICATES ASSESSORS PARCEL NUMBER	PVT.	INDICATES PRIVATE
CB	INDICATES CATCH BASIN	S	INDICATES SEWER
CONC.	INDICATES CONCRETE	SD	INDICATES STORM DRAIN
C	INDICATES CENTERLINE	R/W	INDICATES RIGHT-OF-WAY
ELEV.	INDICATES ELEVATION	TF	INDICATES TOP OF FOOTING
EXIST.	INDICATES EXISTING	TG	INDICATES TOP OF GRATE
FF	INDICATES FINISH FLOOR	TW	INDICATES TOP OF WALL
FS	INDICATES FIRE SERVICE	W	INDICATES WATER
HP	INDICATES HIGH POINT	W/	INDICATES WITH
IE	INDICATES INVERT ELEVATION	(TYP)	INDICATES TYPICAL
R	INDICATES PROPERTY LINE		

SITE ADDRESS

4909 PACIFIC HIGHWAY, SAN DIEGO, CA 92110
A.P.N.
 436-440-22

TOPOGRAPHIC SOURCE

FIELD SURVEY PREPARED BY LG LAND SURVEYING, INC.
 30355 CALLEJO PELIZ TER, VALLEY CENTER, CA 92082
 (619) 535-1172
 DATED OCTOBER 25, 2017
 SUPPLEMENTAL FIELD SURVEY PREPARED BY SNIPES-DYE ASSOCIATES
 8348 CENTER DRIVE, SUITE G, LA MESA, CA 91942
 (619) 697-9234
 DATED FEBRUARY 5, 2020

BENCHMARK

THE BENCHMARK FOR THIS SURVEY IS THE CITY OF SAN DIEGO BRASS PIN IN THE WEST BRIDGE ABUTMENT ON NORTH END OF BRIDGE ON PACIFIC HWY, ELEVATION = 28.177, M.S.L. DATUM OF 1929.

BASIS OF BEARINGS

THE BASIS OF BEARINGS FOR THIS SURVEY IS THE SIDELINE OF PACIFIC HWY PER R.O.S. 22021, I.E. N7°03'02"W.

LEGAL DESCRIPTION

PORTION OF PUEBLO LOT 272 OF M.M. 36.

SPECIAL NOTES

- IT SHALL BE THE CONTRACTOR'S RESPONSIBILITY TO SECURE ANY AND ALL PERMITS REQUIRED IN ORDER TO PERFORM WORK SHOWN ON THESE PLANS.
- IMPORTANT NOTICE TO CONTRACTOR: SECTION 4216/4217 OF THE GOVERNMENT CODE REQUIRES A DIG ALERT IDENTIFICATION NUMBER TO BE ISSUED BEFORE A PERMIT TO EXCAVATE WILL BE VALID. FOR YOUR DIG ALERT ID NUMBER, CALL UNDERGROUND SERVICE ALERT TOLL FREE 1 (800) 422-4133 TWO DAYS BEFORE YOU DIG.
- NEITHER THE OWNER NOR THE ENGINEER OF WORK WILL ENFORCE SAFETY MEASURES OR REGULATIONS. THE CONTRACTOR SHALL DESIGN, CONSTRUCT, AND MAINTAIN ALL SAFETY DEVICES INCLUDING SHORING, AND SHALL BE SOLELY RESPONSIBLE FOR CONFORMING TO ALL LOCAL, STATE, AND FEDERAL SAFETY AND HEALTH STANDARDS, LAWS, AND REGULATIONS.

NEW/REPLACED IMPERVIOUS AREA

NEW IMPERVIOUS AREA:	ON-SITE: 324 SF. (0.01 AC)	
	OFF-SITE: 0 SF. (0.00 AC)	
	TOTAL: 324 SF. (0.01 AC)	
REPLACED IMPERVIOUS AREA:	ON-SITE: 2,659 SF. (0.06 AC)	
	OFF-SITE: 4,955 SF. (0.11 AC)	
	TOTAL: 7,614 SF. (0.18 AC)	
TOTAL IMPERVIOUS AREA:	TOTAL: 7,938 SF. (0.18 AC)	

TOTAL DISTURBED AREA

ON-SITE: 3,739 SF. (0.09 AC)
OFF-SITE: 4,955 SF. (0.11 AC)
TOTAL: 8,694 SF. (0.20 AC)

EARTHWORK QUANTITIES

GRADED AREA:	0.20 ACRES	MAX. CUT DEPTH:	N/A
CUT QUANTITIES:	0 CY	MAX. CUT SLOPE RATIO:	N/A
FILL QUANTITIES:	0 CY	MAX. FILL DEPTH:	N/A
EXPORT:	0 CY	MAX. FILL SLOPE RATIO:	N/A

THIS PROJECT PROPOSES TO EXPORT 0 CUBIC YARDS OF MATERIAL FROM THIS SITE. ALL EXPORT MATERIAL SHALL BE DISCHARGED TO A LEGAL DISPOSAL SITE. THE APPROVAL OF THIS PROJECT DOES NOT ALLOW PROCESSING AND SALE OF THE MATERIAL. ALL SUCH ACTIVITIES REQUIRE A SEPARATE CONDITIONAL USE PERMIT.

FOR WORK WITHIN PUBLIC RIGHT-OF-WAY, SEE IMPROVEMENT PLAN DWG. 42029-D, P.T.S. 669821.

SPECIFICATIONS


- STANDARD SPECIFICATIONS FOR PUBLIC WORKS CONSTRUCTION (CURRENT EDITION).
- CITY OF SAN DIEGO STANDARD DRAWINGS (CURRENT EDITION).
- MANUFACTURER'S STANDARDS AND SPECIFICATIONS FOR APPROVED PRODUCTS.
- CALTRANS - STANDARD SPECIFICATIONS, (CURRENT EDITION).
- CALTRANS - MANUAL OF TESTS, LATEST REVISION.
- CALIFORNIA BUILDING CODE (2016).

LEGEND

EXISTING	EXISTING SPOT ELEVATION	14.34
	EXISTING CONTOUR	16
	EXISTING CONCRETE SURFACE	
	EXISTING ASPHALT SURFACE	
	EXISTING WATER LINE	W
	EXISTING SEWER LINE	S
	EXISTING OVER-HEAD ELECTRIC UTILITIES	OH
	EXISTING GAS LINE	G
	EXISTING GAS P.O.C.	G (6)
	EXISTING WATER P.O.C.	W (W)
	EXISTING FIRE P.O.C.	FS (F)
	EXISTING SEWER P.O.C.	S (S)
PROPOSED	PROPOSED SPOT ELEVATION	16.27
	PROPOSED CONTOUR	15
	PROPOSED A.C. PAVEMENT	DETAIL 1, SHT. C10
	PROPOSED A.C. GRIND & OVERLAY	DETAIL 1, SHT. C10
	PROPOSED CONC. PAVEMENT	DETAIL 2, SHT. C10
	PROPOSED LANDSCAPE	
	PROPOSED PAVEMENT WALKWAY	
	PROPOSED PVT. BUILDING WALL	
	PROPOSED PVT. 6" CONC. CURB	SDG-150
	PROPOSED PVT. 18" CATCH BASIN	DETAIL 3, SHT. C10
	PROPOSED PVT. PVC SDR-35 STORM DRAIN (SIZE & TYPE INDICATED ON PLAN)	SD
	PROPOSED IRRIGATION P.O.C.	W (R)
	DIRECTION OF DRAINAGE	

SHEET INDEX


NO.	DESCRIPTION
C10	TITLE / NOTE SHEET
C20	DRAINAGE PLAN
C3.0	EROSION CONTROL PLAN
C4.0	STANDARD DEVELOPMENT BMP PLAN (FORM I-4 & I-5)

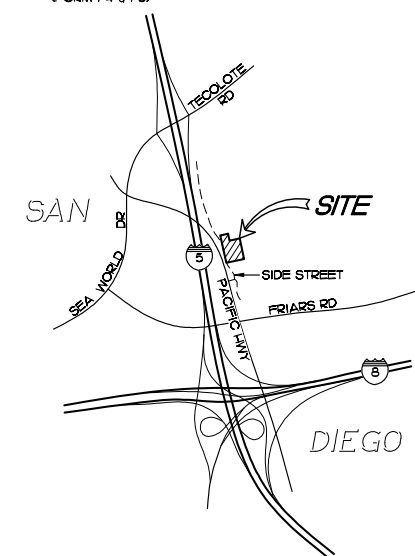

VICINITY MAP
NO SCALE



ENGINEER OF WORK
Snipes-Dye associates
civil engineers and land surveyors
 8348 CENTER DRIVE, STE. G, LA MESA, CA 91942
 TELEPHONE (619) 697-9234 FAX (619) 460-2033
San P. Nguyen 4/15/21
 SON P. NGUYEN R.C.E. 86249
 EXPIRES 03-31-23

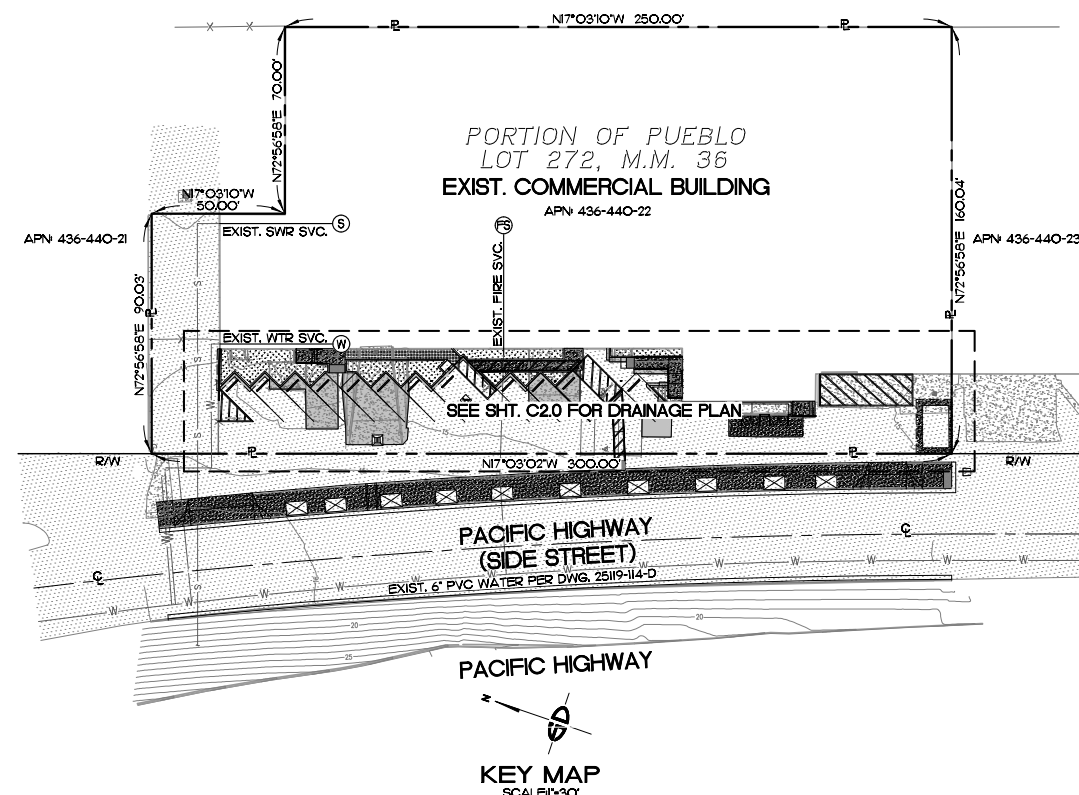

KEY MAP
SCALE=30'

DRAINAGE PLAN

4909 PACIFIC HIGHWAY
 SAN DIEGO, CA 92110

REVISION DESCRIPTION

NO.	DATE	REVISION DESCRIPTION
1	4-15-2021	REVISED PER 2. HAS-COMMINT & TO LUP-ENG BUILDING REVIEW

BY: [Signature]


DATE: 6-17-2020

DESIGNER: SPN
 DRAWN: JGF
 CHECKED: SPN

C10

1 OF 4 SHEETS
 SD3111 (C-D)

SNIPES-DYE ASSOCIATES 8348 CENTER DRIVE, SUITE G, LA MESA, CA 91942-2910 (619) 697-9234, FAX (619) 460-2033

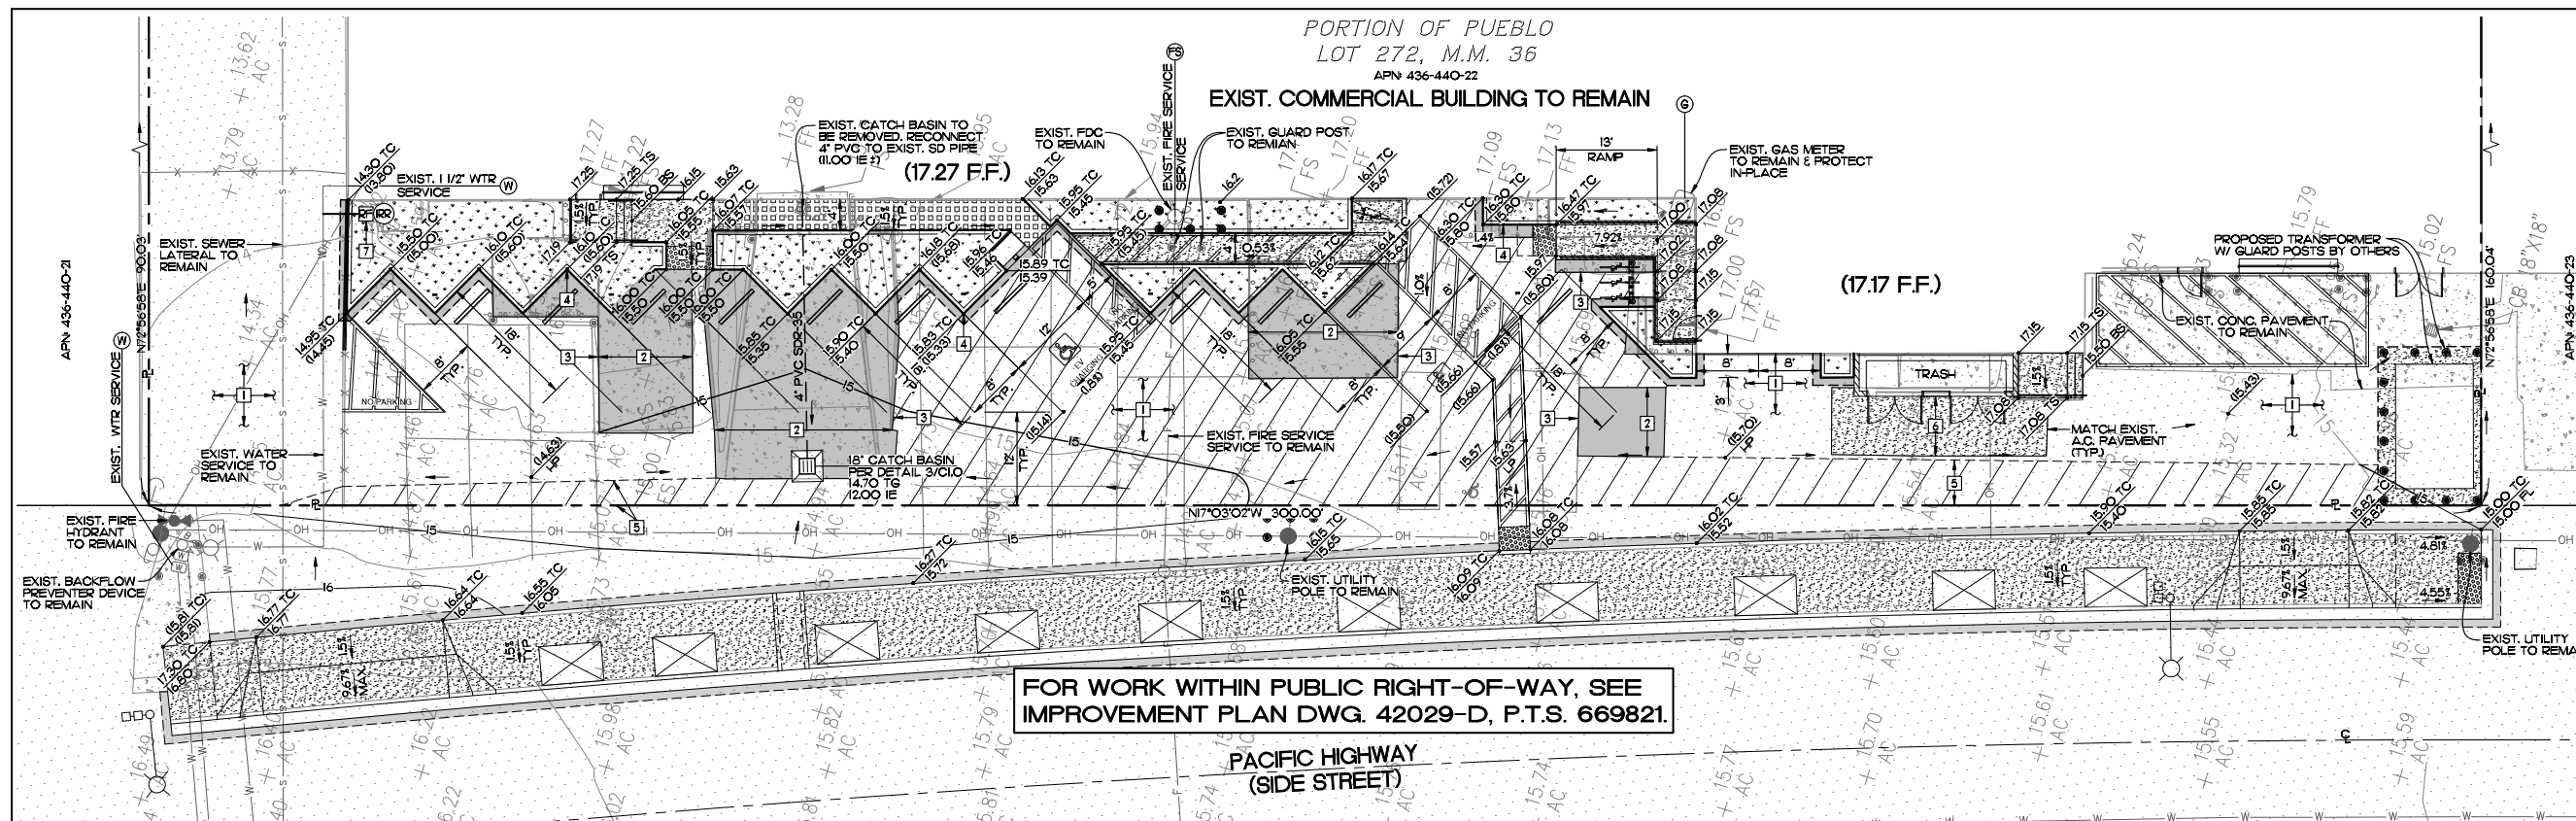


NOTE

ALL STORM WATER RUNOFF FROM PROPOSED AND/OR REPLACED IMPERVIOUS AREAS SHALL BE ROUTED TO PERVIOUS SURFACES OR LANDSCAPING PRIOR TO REACHING THE PUBLIC DRAIN SYSTEM.


KEY NOTES

- 1 EXIST. A.C. PAVEMENT TO REMAIN AND TO BE SLURRY TYPICAL.
- 2 EXIST. CONC. PAVEMENT TO BE REMOVED & REPLACED WITH A.C. PAVEMENT PER DETAIL 2/C2.0.
- 3 SAWCUT & MATCH TO EXIST. A.C. PAVEMENT PER DETAIL 1/C2.0.
- 4 PROPOSED P.V.T. 6" CONC. CURB PER SDG-150, TYPICAL.
- 5 PROPOSED A.C. GRIND & OVERLAY TO FINISH SURFACE PER DETAIL 1/C2.0.
- 6 PROPOSED 7 1/2" (560-C-3250) CONCRETE W/ #4 REBARS @ 12" O.C. BOTH WAYS.
- 7 PROPOSED P.V.T. 3/4" IRRIGATION BACKFLOW PREVENTER DEVICE PER SDW-155 (WILKING MODEL 975XJ) OR APPROVED EQUAL SEE IRRIGATION DETAIL G, SHT. L-4.

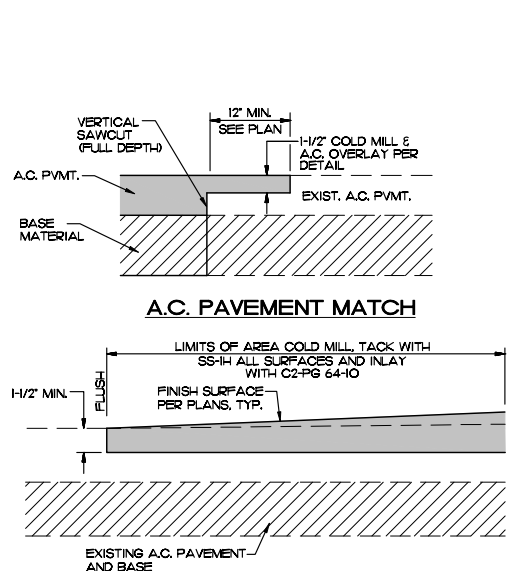


A.C. PAVEMENT COLD MILL / OVERLAY

NOTE: SEE PLANS FOR THE FINISH SURFACE ELEVATIONS.
1 DETAIL
 NO SCALE

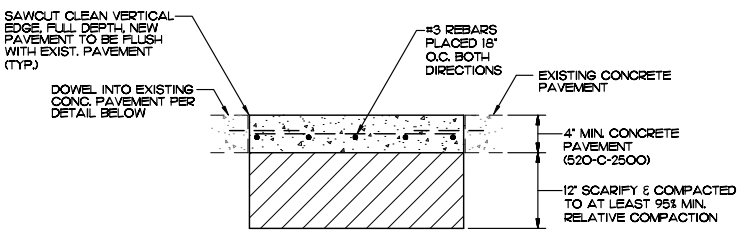


CONC. PAVEMENT (WALKWAYS)

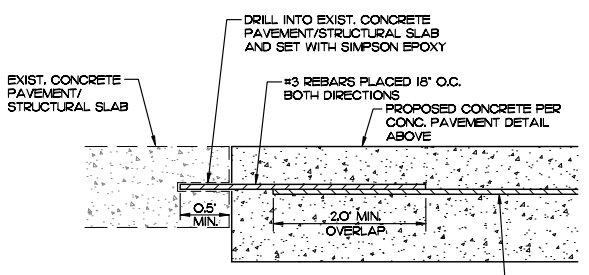


CONC. PAVEMENT DOWEL

2 DETAIL
 NO SCALE

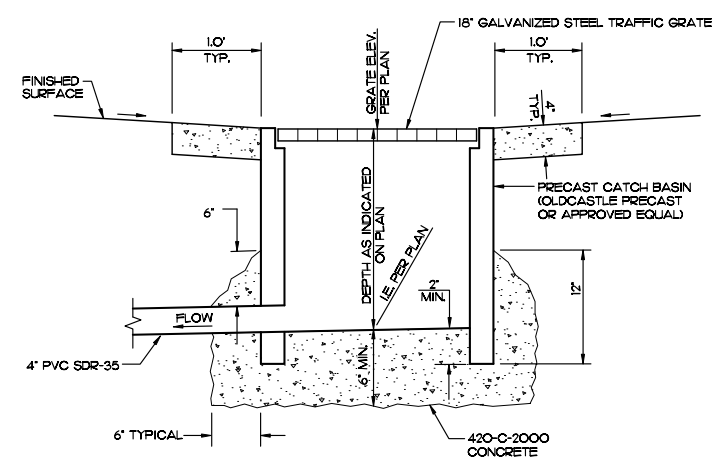

18" CATCH BASIN W/ CONC. APRON (P.V.T.)


3 DETAIL
 NO SCALE

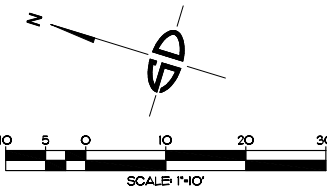

ENGINEER OF WORK
Snipes-Dye associates
 civil engineers and land surveyors
 8348 CENTER DRIVE, STE. G, LA MESA, CA 91942
 TELEPHONE (619) 923-9234 FAX (619) 460-2033
Don P. Munn 4/15/21
 SON P. HUGHEN R.C.E. 86249
 EXPIRES 03-31-23



	
DRAINAGE PLAN 4909 PACIFIC HIGHWAY SAN DIEGO, CA 92110	
SHEET NO. C2.0	SHEET TITLE 6-17-2020
DESIGNER JGF	JOB NAME 6-17-2020
DRAWN SPN	CHECKED SPN
DATE 6-17-2020	DATE 6-17-2020
BY: _____ REVISION DESCRIPTION: _____ NO. _____ DATE _____ SIA _____ REVISED PER 2 INS-COMBINED & 10 LUP-ENG BUILDING REVIEW	
SNIPES-DYE ASSOCIATES 8348 CENTER DRIVE, SUITE G, LA MESA, CA 91942-2910 (619) 923-9234, FAX (619) 460-2033	
2 OF 4 SHEETS SHEET NO. C02011 (O-1)	

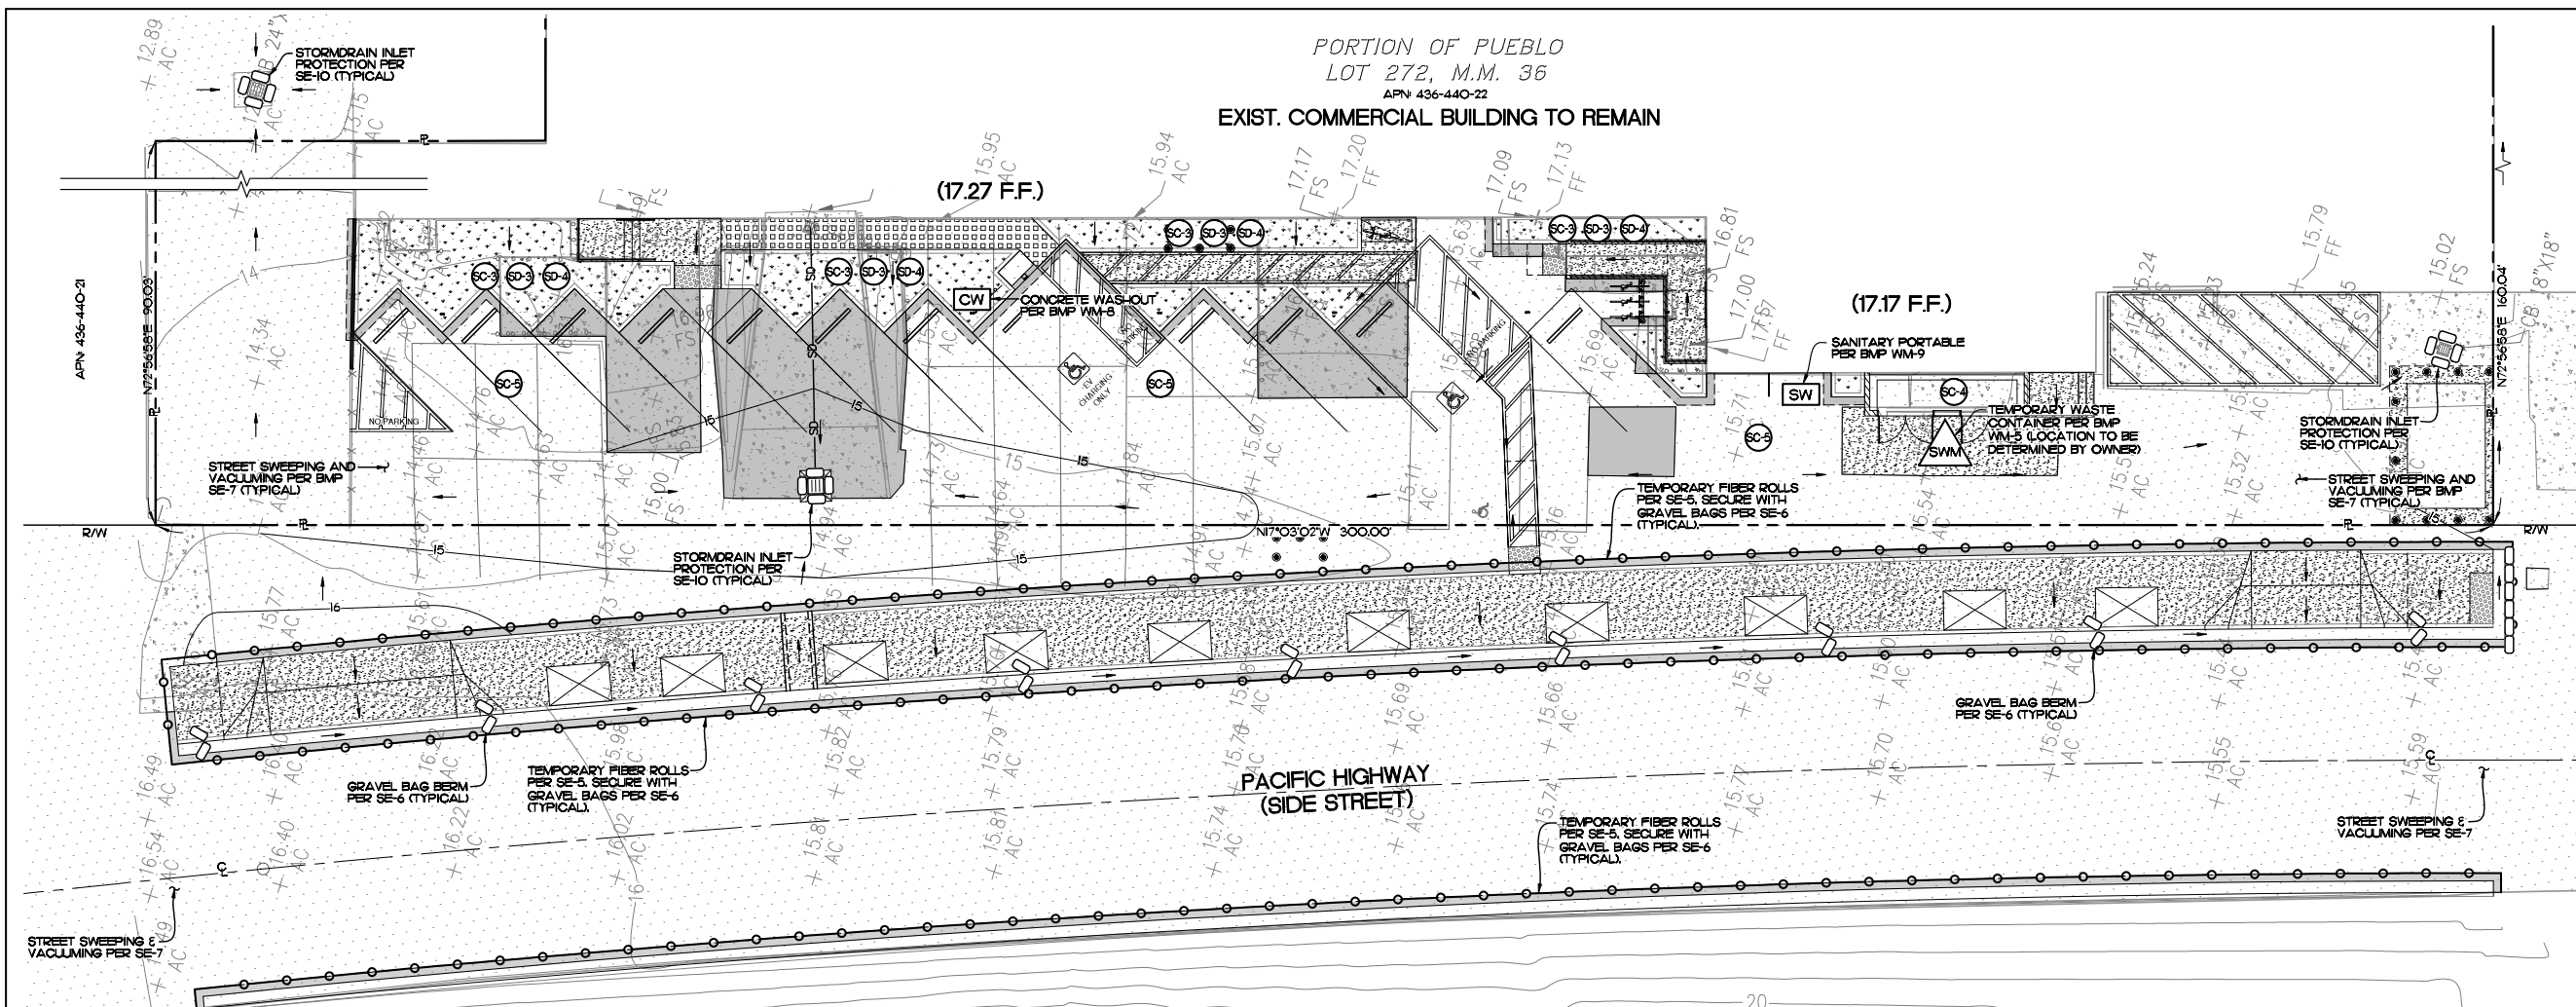

STORM WATER QUALITY NOTES CONSTRUCTION BMP'S

THIS PROJECT SHALL COMPLY WITH ALL CURRENT REQUIREMENTS OF THE STATE PERMIT, CALIFORNIA REGIONAL WATER QUALITY CONTROL BOARD (SDRWQCB), SAN DIEGO MUNICIPAL STORM WATER PERMIT, THE CITY OF SAN DIEGO LAND DEVELOPMENT CODE, AND THE STORM WATER STANDARDS MANUAL. PRIOR TO ANY SOIL DISTURBANCE, TEMPORARY SEDIMENT CONTROLS SHALL BE INSTALLED BY THE CONTRACTOR OR QUALIFIED PERSON(S) AS INDICATED BELOW:

- ALL REQUIREMENTS OF THE CITY OF SAN DIEGO 'STORM WATER STANDARDS MANUAL' MUST BE INCORPORATED INTO THE DESIGN AND CONSTRUCTION OF THE PROPOSED GRADING/IMPROVEMENTS CONSISTENT WITH THE APPROVED STORM WATER POLLUTION PREVENTION PLAN (SWPPP) AND/OR WATER POLLUTION CONTROL PLAN (WPCP) FOR CONSTRUCTION LEVEL BMP'S AND, IF APPLICABLE, THE STORM WATER QUALITY MANAGEMENT PLAN (SWQMP) FOR POST-CONSTRUCTION BMP'S.
- THE CONTRACTOR SHALL INSTALL AND MAINTAIN ALL STORM DRAIN INLET PROTECTION INLET PROTECTION IN THE PUBLIC RIGHT-OF-WAY MUST BE TEMPORARILY REMOVED PRIOR TO A RAIN EVENT TO ENSURE NO FLOODING OCCURS AND REINSTALLED AFTER RAIN IS OVER.
- ALL CONSTRUCTION BMP'S SHALL BE INSTALLED AND PROPERLY MAINTAINED THROUGHOUT THE DURATION OF CONSTRUCTION.
- THE CONTRACTOR SHALL ONLY GRADE, INCLUDING CLEARING AND GRUBBING, AREAS WHICH THE CONTRACTOR OR QUALIFIED CONTACT PERSON CAN PROVIDE EROSION AND SEDIMENT CONTROL MEASURES.
- THE CONTRACTOR IS RESPONSIBLE FOR ENSURING THAT ALL SUB-CONTRACTORS AND SUPPLIERS ARE AWARE OF ALL STORM WATER BMP'S AND IMPLEMENT SUCH MEASURES. FAILURE TO COMPLY WITH THE APPROVED SWPPP/WPCP WILL RESULT IN THE ISSUANCE OF CORRECTION NOTICES, CITATIONS, CIVIL PENALTIES, AND/OR STOP WORK NOTICES.
- THE CONTRACTOR OR QUALIFIED CONTACT PERSON SHALL BE RESPONSIBLE FOR CLEANUP OF ALL SILT, DEBRIS, AND MUD IN AFFECTED STREETS(S) AND WITHIN STORM DRAIN SYSTEM DUE TO CONSTRUCTION VEHICLE/EQUIPMENT AND CONSTRUCTION ACTIVITY AT THE END OF EACH WORK DAY.
- THE CONTRACTOR SHALL PROTECT NEW AND EXISTING STORM WATER CONVEYANCE SYSTEMS FROM SEDIMENTATION, CONCRETE RINSE, OR OTHER CONSTRUCTION-RELATED DEBRIS AND DISCHARGES WITH THE APPROPRIATE BMP'S THAT ARE ACCEPTABLE TO THE CITY RESIDENT ENGINEER AND AS INDICATED IN THE SWPPP/WPCP.
- THE CONTRACTOR OR QUALIFIED CONTACT PERSON SHALL CLEAR DEBRIS, SILT, AND MUD FROM ALL DITCHES AND SWALES PRIOR TO AND WITHIN 3 BUSINESS DAYS AFTER EACH RAIN EVENT OR PRIOR TO THE NEXT RAIN EVENT, WHICHEVER IS SOONER.
- IN A NON-STORM WATER DISCHARGE LEAVES THE SITE, THE CONTRACTOR SHALL IMMEDIATELY STOP THE ACTIVITY AND REPAIR THE DAMAGES. THE CONTRACTOR SHALL NOTIFY THE CITY RESIDENT ENGINEER OF THE DISCHARGE, PRIOR TO RESUMING CONSTRUCTION ACTIVITY. ANY AND ALL WASTE MATERIAL, SEDIMENT, AND DEBRIS FROM EACH NON-STORM WATER DISCHARGE SHALL BE REMOVED FROM THE STORM DRAIN CONVEYANCE SYSTEM AND PROPERLY DISPOSED OF BY THE CONTRACTOR.
- EQUIPMENT AND WORKERS FOR EMERGENCY WORK SHALL BE MADE AVAILABLE AT ALL TIMES. ALL NECESSARY MATERIALS SHALL BE STOCKPILED ONSITE AT CONVENIENT LOCATIONS TO FACILITATE RAPID DEPLOYMENT OF CONSTRUCTION BMP'S WHEN RAINS IS IMMINENT.
- THE CONTRACTOR SHALL RESTORE AND MAINTAIN ALL EROSION AND SEDIMENT CONTROL BMP'S TO WORKING ORDER YEAR-ROUND.
- THE CONTRACTOR SHALL INSTALL ADDITIONAL EROSION AND SEDIMENT CONTROL MEASURES DUE TO UNFORESEEN CIRCUMSTANCES TO PREVENT NON-STORM WATER AND SEDIMENT-LADEN DISCHARGES.
- THE CONTRACTOR SHALL BE RESPONSIBLE AND SHALL TAKE NECESSARY PRECAUTIONS TO PREVENT PUBLIC TRESPASS ONTO AREAS WHERE IMPOUNDED WATERS CREATE A HAZARDOUS CONDITION.
- ALL EROSION AND SEDIMENT CONTROL MEASURES PROVIDED PER THE APPROVED SWPPP/WPCP SHALL BE INSTALLED AND MAINTAINED. ALL EROSION AND SEDIMENT CONTROLS FOR INTERIM CONDITIONS SHALL BE PROPERLY DOCUMENTED AND INSTALLED TO THE SATISFACTION OF THE CITY RESIDENT ENGINEER.
- AS NECESSARY, THE CITY RESIDENT ENGINEER SHALL SCHEDULE MEETINGS FOR THE PROJECT TEAM (GENERAL CONTRACTOR, QUALIFIED CONTACT PERSON, EROSION CONTROL SUBCONTRACTOR IF ANY, ENGINEER OF WORK, OWNER/DEVELOPER, AND THE CITY RESIDENT ENGINEER) TO EVALUATE THE ADEQUACY OF THE EROSION AND SEDIMENT CONTROL MEASURES AND OTHER BMP'S RELATIVE TO ANTICIPATED CONSTRUCTION ACTIVITIES.
- THE CONTRACTOR OR QUALIFIED CONTACT PERSON SHALL CONDUCT VISUAL INSPECTIONS AND MAINTAIN ALL BMP'S DAILY AND AS NEEDED. VISUAL INSPECTIONS AND MAINTENANCE OF ALL BMP'S SHALL BE CONDUCTED BEFORE, DURING, AND AFTER EVERY RAIN EVENT AND EVERY 24 HOURS DURING ANY PROLONGED RAIN EVENT. THE CONTRACTOR SHALL MAINTAIN AND REPAIR ALL BMP'S AS SOON AS POSSIBLE AS SAFETY ALLOWS.
- CONSTRUCTION ENTRANCE AND EXIT AREA. TEMPORARY CONSTRUCTION ENTRANCE AND EXITS SHALL BE CONSTRUCTED IN ACCORDANCE WITH CASQA FACT SHEET TC-1 OR CALTRANS FACT SHEET TC-01 TO PREVENT TRACKING OF SEDIMENT AND OTHER POTENTIAL POLLUTANTS ONTO PAVED SURFACES AND TRAVELED WAYS. WIDTH SHALL BE 10' OR THE MINIMUM NECESSARY TO ACCOMMODATE VEHICLES AND EQUIPMENT WITHOUT BY-PASSING THE ENTRANCE. (A) NON-STORM WATER DISCHARGES SHALL BE EFFECTIVELY MANAGED PER THE SAN DIEGO MUNICIPAL CODE CHAPTER 4, ARTICLE 3, DIVISION 3 'STORM WATER MANAGEMENT AND DISCHARGE CONTROL.'



PROJECT PERMANENT BMP'S

- 1. SOURCE CONTROL BMP'S**
- SC-1 PREVENTION OF ILLICIT DISCHARGES INTO THE MS4.
 - SC-2 LANDSCAPE/OUTDOOR PESTICIDE USE.
 - SC-3 REFUSE AREAS, TRASH ENCLOSURE WITH CONCRETE SLAB, SCREENED WALLS, AND DUMPSTERS WITH LIDS.
 - SC-4 PLAZAS, SIDEWALKS & PARKING LOTS MUST BE SWEEPED REGULARLY.
- 2. SITE DESIGN BMP'S**
- SD-1 MINIMIZE SOIL COMPACTION.
 - SD-2 IMPERVIOUS AREA DISPERSION.
 - SD-3 LANDSCAPE WITH NATIVE OR DROUGHT TOLERANT SPECIES.


LEGEND

REFER TO 'CALIFORNIA STORMWATER BMP HANDBOOK' FOR BEST MANAGEMENT PRACTICES (BMP'S)

1. SCHEDULING/PHASING CONSTRUCTION	EC-1	
2. WATER CONSERVATION PRACTICES	NS-1	
3. PAVING & GRINDING OPERATIONS	NS-3	
4. ILLICIT CONNECTION/DISCHARGE CONTROL	NS-6	
5. POTABLE WATER/IRRIGATION	NS-7	
6. CONCRETE CURING	NS-12	
7. CONCRETE FINISHING	NS-13	
8. STABILIZED CONSTRUCTION ENTRANCE	TC-1	
9. FIBER ROLLS	SE-5	
10. GRAVEL BAG BERM	SE-6	
11. STREET SWEEPING & VACUUMING	SE-7	
12. STORM DRAIN INLET PROTECTION	SE-10	
13. WIND EROSION CONTROL	WE-1	
14. MATERIAL STORAGE	WM-1	
15. MATERIAL USE	WM-2	
16. STOCKPILE MANAGEMENT	WM-3	
17. SPILL PREVENTION & CONTROL	WM-4	
18. TEMPORARY WASTE CONTAINER	WM-5	
19. HAZARDOUS WASTE	WM-3	
20. CONTAMINATED SOILS MANAGEMENT	WM-4	
21. TEMPORARY CONCRETE WASH-OUT	WM-8	
22. SANITARY/SEPTIC WASTE	WM-9	
23. LIQUID WASTE MANAGEMENT	WM-10	
24. DIRECTION OF FLOW		

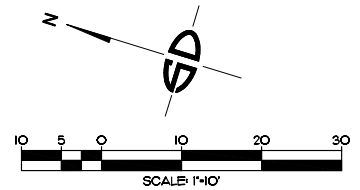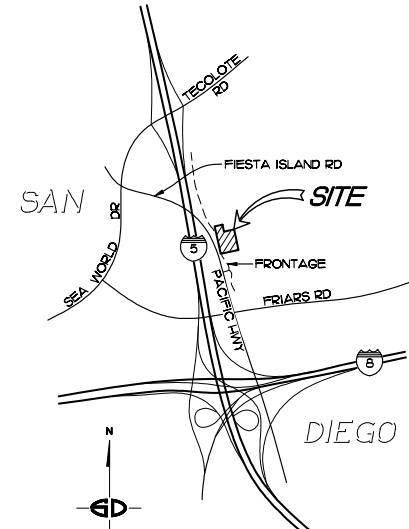

ENGINEER OF WORK
Snipes-Dye associates
civil engineers and land surveyors
 8348 CENTER DRIVE, STE. G, LA MESA, CA 91942
 TELEPHONE (619) 460-2033 FAX (619) 460-2033
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 EXPIRES 03-31-23

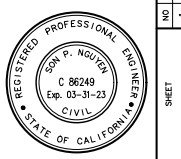

DRAINAGE PLAN
 4909 PACIFIC HIGHWAY
 SAN DIEGO, CA 92110

APN 436-440-21
 APN 436-440-22
 APN 436-440-23

SHEET NO. **C30**
 3 OF 4 SHEETS
 JOB NO. SD3111 (0-1)

DESIGNER: SPN
 DRAWN: JGF
 CHECKED: SPN
 DATE: 6-17-2020

BY: _____ DATE: _____
 NO. _____ DATE: _____
 REVISION DESCRIPTION: _____

REVISION 1: 4-15-2021
 REVISION 2: AS-COMBINED & TO LUP-ENG BUILDING REVIEW

SNIPES-DYE ASSOCIATES 8348 CENTER DRIVE, SUITE G, LA MESA, CA 91942-2910 (619) 697-9234, FAX (619) 460-2033

City of San Diego Development Services Storm Water Requirements Applicability Checklist FORM DS-560 November 2018

Project Address: 4909 Pacific Highway, San Diego, CA 92110 Project Number: 609821

SECTION 1. Construction Storm Water BMP Requirements:
All construction sites are required to implement construction BMPs in accordance with the performance standards in the Storm Water Standards Manual. Some sites are additionally required to obtain coverage under the State Construction General Permit (CGP), which is administered by the State Regional Water Quality Control Board.

For all projects complete PART A. If project is required to submit a SWPPP or WPCP, continue to PART B.

PART A: Determine Construction Phase Storm Water Requirements.

1. Is the project subject to California's statewide General NPDES permit for Storm Water Discharges Associated with Construction Activities, also known as the State Construction General Permit (CGP)? (Typically projects with land disturbance greater than or equal to 1 acre.)
 Yes; SWPPP required, skip questions 2-4 No; next question

2. Does the project propose construction or demolition activity, including but not limited to, clearing, grading, grubbing, excavation, or any other activity resulting in ground disturbance and/or contact with storm water?
 Yes; WPCP required, skip questions 3-4 No; next question

3. Does the project propose routine maintenance to maintain original line and grade, hydraulic capacity, or original purpose of the facility? (Projects such as pipeline/utility replacement)
 Yes; WPCP required, skip question 4 No; next question

4. Does the project only include the following Permit types listed below?
• Electrical Permit, Fire Alarm Permit, Fire Sprinkler Permit, Plumbing Permit, Sign Permit, Mechanical Permit, Spa Permit.
• Individual Right of Way Permits that exclusively include only ONE of the following activities: water service, sewer lateral, or utility service.
• Right of Way Permits with a project footprint less than 150 linear feet that exclusively include only ONE of the following activities: curb ramp, sidewalk and driveway apron replacement, pot hole, curb and gutter replacement, and retaining wall encroachments.
 Yes; no document required

Check one of the boxes below, and continue to PART B:
 If you checked "Yes" for question 1, a SWPPP IS REQUIRED. Continue to PART B.
 If you checked "No" for question 1, and checked "Yes" for question 2 or 3, a WPCP IS REQUIRED. If the project proposes less than 5,000 square feet of ground disturbance AND has less than a 5-foot elevation change over the entire project area, a Minor WPCP may be required. Continue to PART B.
 If you checked "No" for all questions 1-3, and checked "Yes" for question 4, PART B does not apply and no document is required. Continue to Section 2.

1. More information on the CGP is available at www.sandag.ca.gov/StormWater/CGP.
2. More information on the WPCP is available at www.sandag.ca.gov/StormWater/WPCP.
3. More information on the SWPPP is available at www.sandag.ca.gov/StormWater/SWPPP.
4. More information on the Minor WPCP is available at www.sandag.ca.gov/StormWater/MinorWPCP.

Printed on recycled paper. Visit our web site at www.sandag.ca.gov/StormWater.
Upon request, this information is available in alternative formats for people with disabilities.
DS-560 (11-18)

Clear Page 1

Page 2 of 4 City of San Diego • Development Services • Storm Water Requirements Applicability Checklist

PART B: Determine Construction Site Priority
This prioritization must be completed within this form, noted on the plans, and included in the SWPPP or WPCP. The city reserves the right to adjust the priority of projects both before and after construction. Construction projects are assigned an inspection frequency based on if the project has a "high threat to water quality." The City has aligned the local definition of "high threat to water quality" to the risk determination approach of the State Construction General Permit (CGP). The CGP determines risk level based on project specific sediment risk and receiving water risk. Additional inspection is required for projects within the Areas of Special Biological Significance (ASBS) watershed. NOTE: The construction priority does NOT change construction BMP requirements that apply to projects; rather, it determines the frequency of inspections that will be conducted by city staff.

Complete PART B and continued to section 2

1. ASBS
a. Projects located in the ASBS watershed.

2. High Priority
a. Projects that qualify as Risk Level 2 or Risk Level 3 per the Construction General Permit (CGP) and not located in the ASBS watershed.
b. Projects that qualify as LUP Type 2 or LUP Type 3 per the CGP and not located in the ASBS watershed.

3. Medium Priority
a. Projects that are not located in an ASBS watershed or designated as a High priority site.
b. Projects that qualify as Risk Level 1 or LUP Type 1 per the CGP and not located in an ASBS watershed.
c. WPCP projects (>5,000sf of ground disturbance) located within the Los Penasquitos watershed management area.

4. Low Priority
a. Projects not subject to a Medium or High site priority designation and are not located in an ASBS watershed.

SECTION 2. Permanent Storm Water BMP Requirements.
Additional information for determining the requirements is found in the Storm Water Standards Manual.

PART C: Determine if Not Subject to Permanent Storm Water Requirements.
Projects that are considered maintenance, or otherwise not categorized as "new development projects" or "redevelopment projects" according to the Storm Water Standards Manual are not subject to Permanent Storm Water BMPs.

If "yes" is checked for any number in Part C, proceed to Part F and check "Not Subject to Permanent Storm Water BMP Requirements".
If "no" is checked for all of the numbers in Part C continue to Part D.

1. Does the project only include interior remodels and/or is the project entirely within an existing enclosed structure and does not have the potential to contact storm water? Yes No

2. Does the project only include the construction of overhead or underground utilities without creating new impervious surfaces? Yes No

3. Does the project fall under routine maintenance? Examples include, but are not limited to: roof or exterior structure surface replacement, resurfacing or reconfiguring surface parking lots or existing roadways without replacing the impervious footprint, and routine replacement of damaged pavement (grinding, overlay, and pothole repair). Yes No

Clear Page 2

Page 3 of 4 City of San Diego • Development Services • Storm Water Requirements Applicability Checklist

PART D: PDP Exempt Requirements.
PDP Exempt projects are required to implement site design and source control BMPs.

If "yes" was checked for any questions in Part D, continue to Part F and check the box labeled "PDP Exempt".
If "no" was checked for all questions in Part D, continue to Part E.

1. Does the project ONLY include new or retrofit sidewalks, bicycle lanes, or trails that:
• Are designed and constructed to direct storm water runoff to adjacent vegetated areas, or other non-erodible permeable areas? Or;
• Are designed and constructed to be hydraulically disconnected from paved streets and roads? Or;
• Are designed and constructed with permeable pavements or surfaces in accordance with the Green Streets guidance in the City's Storm Water Standards Manual?
 Yes; PDP exempt requirements apply No; next question

2. Does the project ONLY include retrofitting or redeveloping existing paved alleys, streets or roads designed and constructed in accordance with the Green Streets guidance in the City's Storm Water Standards Manual?
 Yes; PDP exempt requirements apply No; project not exempt.

PART E: Determine if Project is a Priority Development Project (PDF).
Projects that match one of the definitions below are subject to additional requirements including preparation of a Storm Water Quality Management Plan (SWQMP).

If "yes" is checked for any number in PART E, continue to PART F and check the box labeled "Priority Development Project".
If "no" is checked for every number in PART E, continue to PART F and check the box labeled "Standard Development Project".

1. New Development that creates 10,000 square feet or more of impervious surfaces collectively over the project site. This includes commercial, industrial, residential, mixed-use, and public development projects on public or private land. Yes No

2. Redevelopment project that creates and/or replaces 5,000 square feet or more of impervious surfaces on an existing site of 10,000 square feet or more of impervious surfaces. This includes commercial, industrial, residential, mixed-use, and public development projects on public or private land. Yes No

3. New development or redevelopment of a restaurant. Facilities that sell prepared foods and drinks for consumption, including stationary lunch counters and refreshment stands selling prepared foods and drinks for immediate consumption (SIC 5812), and where the land development creates and/or replaces 5,000 square feet or more of impervious surface. Yes No

4. New development or redevelopment on a hillside. The project creates and/or replaces 5,000 square feet or more of impervious surface (collectively over the project site) and where the development will grade on any natural slope that is twenty-five percent or greater. Yes No

5. New development or redevelopment of a parking lot that creates and/or replaces 5,000 square feet or more of impervious surface (collectively over the project site). Yes No

6. New development or redevelopment of streets, roads, highways, freeways, and driveways. The project creates and/or replaces 5,000 square feet or more of impervious surface (collectively over the project site). Yes No

Clear Page 3

Page 4 of 4 City of San Diego • Development Services • Storm Water Requirements Applicability Checklist

7. New development or redevelopment discharging directly to an Environmentally Sensitive Area. The project creates and/or replaces 2,500 square feet of impervious surface (collectively over project site), and discharges directly to an Environmentally Sensitive Area (ESA). Discharging directly or conveying flow that is conveyed overland a distance of 200 feet or less from the project to the ESA or conveyed in a pipe or open channel any distance as an isolated flow from the project to the ESA (i.e. not commingled with flows from adjacent lands). Yes No

8. New development or redevelopment projects of a retail gasoline outlet (RGO) that create and/or replaces 5,000 square feet of impervious surface. The development project meets the following criteria: (a) 5,000 square feet or more or (b) has a projected Average Daily Traffic (ADT) of 100 or more vehicles per day. Yes No

9. New development or redevelopment projects of an automotive repair shops that create and/or replaces 5,000 square feet or more of impervious surface. Development projects categorized in any one of Standard Industrial Classification (SIC) codes 5013, 5014, 5041, 7532, 7534, or 7536-7539. Yes No

10. Other Pollutant Generating Project. The project is not covered in the categories above, results in the disturbance of one or more acres of land and is expected to generate pollutants post construction, such as fertilizers and pesticides. This does not include projects creating less than 5,000 sf of impervious surface and where active landscaping does not require regular use of pesticides and fertilizers, such as slope stabilization using native plants. Calculation of the square footage of impervious surface need not include linear pathways that are for infrequent vehicle use, such as emergency maintenance access or bicycle pedestrian use, if they are built with pervious surfaces of if they sheet flow to surrounding pervious surfaces. Yes No

PART F: Select the appropriate category based on the outcomes of PART C through PART E.

1. The project is NOT SUBJECT TO PERMANENT STORM WATER REQUIREMENTS.

2. The project is a STANDARD DEVELOPMENT PROJECT. Site design and source control BMP requirements apply. See the Storm Water Standards Manual for guidance.

3. The project is PDP EXEMPT. Site design and source control BMP requirements apply. See the Storm Water Standards Manual for guidance.

4. The project is a PRIORITY DEVELOPMENT PROJECT. Site design, source control, and structural pollutant control BMP requirements apply. See the Storm Water Standards Manual for guidance on determining if project requires a hydromodification plan management.

Juan Flores / Snipes-Dye Associates CAD Tech
Name of Owner or Agent (Please Print) Title

Signature: *Juan Flores* Date: 06/15/2020

DESIGNER: SPN SPN
DRAWN: JGF JGF
RECORDED: SPN SPN
DATE: 6-17-2020

NO. DATE BY NO. DATE BY NO. DATE BY NO. DATE BY
1 4-15-2021 REVISION DESCRIPTION
REVISION PER 2 HAS-COMMENT & TO LUP-ENG BUILDING REVIEW

ENGINEER OF WORK
Snipes-Dye associates
civil engineers and land surveyors
8348 CENTER DRIVE, STE. G, LA MESA, CA 91942
TELEPHONE (619) 923-4 FAX (619) 460-2033
SON P. Nguyen 4/15/21
SON P. Nguyen R.C.E. 86249
EXPIRES 03-31-23

REGISTERED PROFESSIONAL ENGINEER
SON P. NGUYEN
C 86249
Exp. 03-31-23
CIVIL
STATE OF CALIFORNIA

SHEET C4.0
4 OF 4 SHEETS
SD5811 (0-1)

STANDARD DEVELOPMENT BMP PLAN
(FORM I-4 AND I-5)
4909 PACIFIC HIGHWAY
SAN DIEGO, CA 92110
SNIPES-DYE ASSOCIATES 8348 CENTER DRIVE, SUITE G, LA MESA, CA 91942-2910 (619) 697-9234, FAX (619) 460-2033

Source Control BMP Checklist Form I-4A
All development projects must implement source control BMPs. Refer to Chapter 4 and Appendix E of the BMP Design Manual for information to implement BMPs shown in this checklist.
Note: All selected BMPs must be shown on the construction plans.

Source Control Requirement	Applied?
4.2.1 Diversion of Storm Discharges into the BSE	<input checked="" type="checkbox"/> Yes <input type="checkbox"/> No <input type="checkbox"/> N/A
4.2.2 Storm Drain Stenciling or Signage	<input checked="" type="checkbox"/> Yes <input type="checkbox"/> No <input type="checkbox"/> N/A
4.2.3 Protect Outdoor Materials Storage Areas from Rainfall, Run-On, Runoff, and Wind Dispersal	<input type="checkbox"/> Yes <input type="checkbox"/> No <input checked="" type="checkbox"/> N/A
4.2.4 Protect Materials Stored in Outdoor Work Areas from Rainfall, Run-On, Runoff, and Wind Dispersal	<input type="checkbox"/> Yes <input type="checkbox"/> No <input checked="" type="checkbox"/> N/A
4.2.5 Protect Trash Storage Areas from Rainfall, Run-On, Runoff, and Wind Dispersal	<input checked="" type="checkbox"/> Yes <input type="checkbox"/> No <input type="checkbox"/> N/A
4.2.6 BMPs based on Potential Sources of Runoff Pollutants	
On-site storm drain inlets	<input checked="" type="checkbox"/> Yes <input type="checkbox"/> No <input type="checkbox"/> N/A
Interior floor drains and elevator shaft sump pumps	<input checked="" type="checkbox"/> Yes <input type="checkbox"/> No <input type="checkbox"/> N/A
Interior parking garages	<input checked="" type="checkbox"/> Yes <input type="checkbox"/> No <input type="checkbox"/> N/A
Need for future indoor & structural pest control	<input checked="" type="checkbox"/> Yes <input type="checkbox"/> No <input type="checkbox"/> N/A
Landscape/Outdoor Pesticide Use	<input checked="" type="checkbox"/> Yes <input type="checkbox"/> No <input type="checkbox"/> N/A
Pools, spas, ponds, decorative fountains, and other water features	<input checked="" type="checkbox"/> Yes <input type="checkbox"/> No <input type="checkbox"/> N/A
Food service	<input checked="" type="checkbox"/> Yes <input type="checkbox"/> No <input type="checkbox"/> N/A
Refuse areas	<input checked="" type="checkbox"/> Yes <input type="checkbox"/> No <input type="checkbox"/> N/A
Industrial processes	<input checked="" type="checkbox"/> Yes <input type="checkbox"/> No <input type="checkbox"/> N/A
Outdoor storage of equipment or materials	<input checked="" type="checkbox"/> Yes <input type="checkbox"/> No <input type="checkbox"/> N/A
Vehicle/Equipment Repair and Maintenance	<input checked="" type="checkbox"/> Yes <input type="checkbox"/> No <input type="checkbox"/> N/A
Fuel Dispensing Areas	<input checked="" type="checkbox"/> Yes <input type="checkbox"/> No <input type="checkbox"/> N/A
Loading Docks	<input checked="" type="checkbox"/> Yes <input type="checkbox"/> No <input type="checkbox"/> N/A
Fire sprinkler test water	<input checked="" type="checkbox"/> Yes <input type="checkbox"/> No <input type="checkbox"/> N/A
Miscellaneous Drain or Wash Water	<input checked="" type="checkbox"/> Yes <input type="checkbox"/> No <input type="checkbox"/> N/A
Plazas, sidewalks, and parking lots	<input checked="" type="checkbox"/> Yes <input type="checkbox"/> No <input type="checkbox"/> N/A
SC-6A: Large Trash Generating Facilities	<input checked="" type="checkbox"/> Yes <input type="checkbox"/> No <input type="checkbox"/> N/A
SC-6B: Animal Facilities	<input checked="" type="checkbox"/> Yes <input type="checkbox"/> No <input type="checkbox"/> N/A
SC-6C: Plant Nurseries and Garden Centers	<input checked="" type="checkbox"/> Yes <input type="checkbox"/> No <input type="checkbox"/> N/A
SC-6D: Automotive Facilities	<input checked="" type="checkbox"/> Yes <input type="checkbox"/> No <input type="checkbox"/> N/A

Discussion / justification for all "No" answers shown above:

Site Design BMP Checklist Form I-5A
All development projects must implement site design BMPs. Refer to Chapter 4 and Appendix E of the BMP Design Manual for information to implement BMPs shown in this checklist.
Note: All selected BMPs must be shown on the construction plans.

Site Design Requirement	Applied?
4.3.1 Maintain Natural Drainage Pathways and Hydrologic Features	<input type="checkbox"/> Yes <input type="checkbox"/> No <input checked="" type="checkbox"/> N/A
4.3.2 Conserve Natural Areas, Soils, and Vegetation	<input type="checkbox"/> Yes <input type="checkbox"/> No <input checked="" type="checkbox"/> N/A
4.3.3 Minimize Impervious Area	<input checked="" type="checkbox"/> Yes <input type="checkbox"/> No <input type="checkbox"/> N/A
4.3.4 Minimize Soil Compaction	<input checked="" type="checkbox"/> Yes <input type="checkbox"/> No <input type="checkbox"/> N/A
4.3.5 Impervious Area Dispersion	<input type="checkbox"/> Yes <input type="checkbox"/> No <input checked="" type="checkbox"/> N/A
4.3.6 Runoff Collection	<input type="checkbox"/> Yes <input type="checkbox"/> No <input checked="" type="checkbox"/> N/A
4.3.7 Landscaping with Native or Drought Tolerant Species	<input checked="" type="checkbox"/> Yes <input type="checkbox"/> No <input type="checkbox"/> N/A
4.3.8 Harvest and Use Precipitation	<input type="checkbox"/> Yes <input type="checkbox"/> No <input checked="" type="checkbox"/> N/A

Discussion / justification for all "No" answers shown above:
⁽¹⁾ Answer for each source control and site design category shall be pursuant to the following:
• "Yes" means the project will implement the BMP as described in Chapter 4 and/or Appendix E of the BMP Design Manual. Discussion / justification is not required.
• "No" means the BMP is applicable to the project but it is not feasible to implement. Discussion / justification must be provided.
• "N/A" means the BMP is not applicable at the project site because the project does not include the feature that is addressed by the BMP (e.g., the project has no outdoor materials storage areas). Discussion / justification may be provided.



ENGINEER OF WORK
Snipes-Dye associates
civil engineers and land surveyors
8348 CENTER DRIVE, STE. G, LA MESA, CA 91942
TELEPHONE (619) 923-4 FAX (619) 460-2033
SON P. Nguyen 4/15/21
SON P. Nguyen R.C.E. 86249
EXPIRES 03-31-23



SHEET C4.0
4 OF 4 SHEETS
SD5811 (0-1)



2934 Lincoln Ave., San Diego, CA 92104
 techne-us.com sustainable@techne.org
 619-940-5814 m 313-595-5814

CONSULTANTS



SAM WADE

Landscape Architect

2304 Garnet Ave, Suite 205
 San Diego, CA 92109

Tel: 658-278-8688

sam@samwadelandscape.com

www.samwadelandscape.com

AZ LIC. #74705 | CA LIC. #3703

4909 Pacific Highway,
 San Diego, CA 92110

OWNER

RAP Holdings, LLC & United Partners,
 LLC

PLANTING LEGEND

SYMBOL	BOTANICAL NAME	COMMON NAME	HT.	SPRD.	SIZE	QTY.	REMARKS	WUCOLS	POINTS
Street Trees									
ST-1	Tristania laurina	Little Leaf Myrtle	18'	14'	24" box	10	Standard Form w/ Root Barriers	M	-
Trees									
T-1	Archontophoenix cunninghamiana	King Palm	18'	14'	24" box	1	Double trunk 10', 6"	M	20
T-2	Ficus lyrata	Fiddleleaf Fig	12'	10'	24" box	2	Multi-trunk, Low branch	M	40
Shrubs									
S-1	Cordylina f. 'Xerox'	Xerox Cordylina	6'	3'	15 gal.	7		M	70
S-2	Cycas revoluta	Sago Palm	3'	5'	15 gal.	4		M	40
S-3	Liriope gigantea	Giant Liriope	2'	2'	5 gal.	15		M	30
S-4	Philodendron xanadu	Dwarf Philodendron	2'	3'	5 gal.	19		M	38
S-5	Rhapis excelsa	Slender Lady Palm	6'	3'	15 gal.	7		M	70
S-6	Westringia r. 'Morning Light'	Morning Light Rosemary	1.5'	2'	5 gal.	78		L	156 464

Note: Street Tree selected from the Linda Vista Community Plan dated February, 2020.

PLANTING MATERIALS AND PROCESSES
 Refer To Planting Details and Notes, Sheet L-2

PLANT MATERIAL SOURCES

Code	Source Name	Contact	Address	Contact
NN	Norman's Nursery, Inc.	Kevin	Rancho Soledad Nursery	Jesse
	1-626-237-0641		1-760-555-1212	

Note: Nursery sources suggested.

Note: Refer to the following Planting and Installation Details on Sheet L-2
 Detail A - Tree Planting
 Detail B - Root Barrier
 Detail C - Shrub Planting
 Detail D - Groundcover Planting

Key

T-1 10 Plant Symbol
 24" Box Plant Quantity
 24" Box Plant Size, Remarks

Bark Mulch

For all site planting areas, use "Walk On Bark", applied in a continuous 3" layer; do not apply in tree, shrub or groundcover watering basins (refer to planting detail for specific mulch application in watering basins). Available from: Hansen A-1 Soils, Ph. 658-715-5600

LONG-TERM SITE LANDSCAPE MAINTENANCE

ALL REQUIRED LANDSCAPE AREAS SHALL BE MAINTAINED BY THE PROPERTY OWNER. LANDSCAPE AND IRRIGATION AREAS IN THE PUBLIC RIGHT-OF-WAY SHALL ALSO BE MAINTAINED BY THE PROPERTY OWNER. THE LANDSCAPE AREAS SHALL BE MAINTAINED FREE OF DEBRIS AND LITTER, AND ALL PLANT MATERIAL SHALL BE MAINTAINED IN A HEALTHY GROWING CONDITION. DISEASED OR DEAD PLANT MATERIAL SHALL BE SATISFACTORILY TREATED OR REPLACED PER THE CONDITIONS OF THE PERMIT.

ROOT BARRIERS


NON-BIODEGRADABLE ROOT BARRIERS SHALL BE INSTALLED AROUND ALL NEW STREET TREES. ROOT BARRIERS MAY BE ELIMINATED WHERE THE COMBINATION OF TREE SPECIES, SOIL TYPE, SOIL AREA AND DRAINAGE CONDITIONS CAN BE SHOWN TO AFFORD EQUIVALENT PROTECTION AGAINST TREE ROOT DAMAGE TO PUBLIC IMPROVEMENTS. (LDC 142.0403)

MINIMUM TREE SEPARATION DISTANCE
 IMPROVEMENT / MINIMUM DISTANCE TO STREET TREE:


TRAFFIC SIGNALS / STOP SIGNS - 20 FEET
 UNDERGROUND UTILITY LINES - 5 FEET (10 FEET FOR SEWER)
 ABOVE GROUND UTILITY STRUCTURES - 10 FEET
 DRIVEWAY (ENTRIES) - 10 FEET
 INTERSECTIONS (INTERSECTING CURB LINES OF TWO STREETS) - 25 FEET

DIG ALERT


BEFORE EXCAVATING, CONTRACTOR SHALL VERIFY THE LOCATION OF ALL UTILITIES AT LEAST TWO (2) WORKING DAYS PRIOR TO EXCAVATION BY CALLING UNDERGROUND SERVICE ALERT @ 1-800-227-2600. CONTRACTOR SHALL REQUEST THE MARK-OUT OF UNDERGROUND UTILITIES INCLUDING BUT NOT LIMITED TO: GAS, ELECTRIC, TELEPHONE, WATER, SEWER, LIGHTING, TELEVISION. CONTRACTOR SHALL BE RESPONSIBLE TO POTHOLE TO VERIFY EXACT LOCATION OF UTILITIES FOLLOWING MARK-OUT.

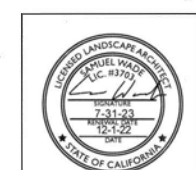

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- CITY OF SAN DIEGO NOTES**
- ALL LANDSCAPE AND IRRIGATION SHALL CONFORM TO THE STANDARDS OF THE CITY-WIDE LANDSCAPE REGULATIONS AND THE CITY OF SAN DIEGO LAND DEVELOPMENT MANUAL LANDSCAPE STANDARDS AND ALL OTHER LANDSCAPE RELATED CITY AND REGIONAL STANDARDS.
 - IRRIGATION: AN AUTOMATIC, ELECTRICALLY CONTROLLED DRIP IRRIGATION SYSTEM SHALL BE PROVIDED AS REQUIRED BY LDC §142.0403(c) FOR PROPER IRRIGATION, DEVELOPMENT, AND MAINTENANCE OF THE VEGETATION IN A HEALTHY, DISEASE-RESISTANT CONDITION. THE DESIGN OF THE SYSTEM SHALL PROVIDE ADEQUATE SUPPORT FOR THE VEGETATION SELECTED.
 - A MINIMUM ROOT ZONE OF 40 SQUARE FEET (S.F.) IN AREA SHALL BE PROVIDED FOR ALL TREES. THE MINIMUM DIMENSION FOR THIS AREA SHALL BE 5 FEET, PER SDMC 142.0403(b)(5).
 - TREES SHALL BE MAINTAINED SO THAT ALL BRANCHES OVER PEDESTRIAN WALKWAYS ARE 6 FEET ABOVE THE WALKWAY GRADE AND BRANCHES OVER VEHICULAR TRAVEL WAYS ARE 16 FEET ABOVE THE TRAVEL WAY PER SDMC 142.0403(b)(10).
 - TREE ROOT BARRIERS SHALL BE INSTALLED WHERE TREES ARE PLACED WITHIN 5 FEET OF PUBLIC IMPROVEMENTS INCLUDING WALKS, CURBS, OR STREET PAVEMENTS OR WHERE NEW PUBLIC IMPROVEMENTS ARE PLACED ADJACENT TO EXISTING TREES. THE ROOT BARRIER WILL NOT WRAP AROUND THE ROOT BALL, ALL PER SDMC 142.0403(b).
 - MULCH: ALL REQUIRED PLANTING AREAS AND EXPOSED SOIL AREAS WITHOUT VEGETATION SHALL BE COVERED WITH MULCH TO A MINIMUM DEPTH OF 3 INCHES, EXCLUDING SLOPES REQUIRING REVEGETATION PER SDMC 142.0411.
 - IF ANY REQUIRED LANDSCAPE INDICATED ON THE APPROVED CONSTRUCTION DOCUMENT PLANS IS DAMAGED OR REMOVED DURING DEMOLITION OR CONSTRUCTION, IT SHALL BE REPAIRED AND/OR REPLACED IN KIND AND EQUIVALENT SIZE PER THE APPROVED DOCUMENTS TO THE SATISFACTION OF THE DEVELOPMENT SERVICES DEPARTMENT WITHIN 30 DAYS OF DAMAGE.
 - THE APPLICANT AGREES TO COMPLY WITH THE REQUIREMENTS OF THE PRESCRIPTIVE COMPLIANCE OPTION TO THE MODEL WATER EFFICIENT LANDSCAPE ORDINANCE (MWELO) IN ACCORDANCE WITH STATE LAW AND LAND DEVELOPMENT CODE SECTION 142.0413(b) AND WILL PROVIDE THE RECORD OWNER AT THE TIME OF FINAL INSPECTION WITH A CERTIFICATE OF COMPLETION, CERTIFICATE OF INSTALLATION, IRRIGATION SCHEDULE, AND SCHEDULE OF LANDSCAPE AND IRRIGATION MAINTENANCE.
 - ALL PRUNING SHALL COMPLY WITH THE STANDARDS OF THE AMERICAN NATIONAL STANDARDS INSTITUTE (ANSI) FOR TREE CARE OPERATIONS AND THE INTERNATIONAL SOCIETY OF ARBORICULTURE (ISA) FOR TREE PRUNING. TOPPING OF TREES IS NOT PERMITTED.

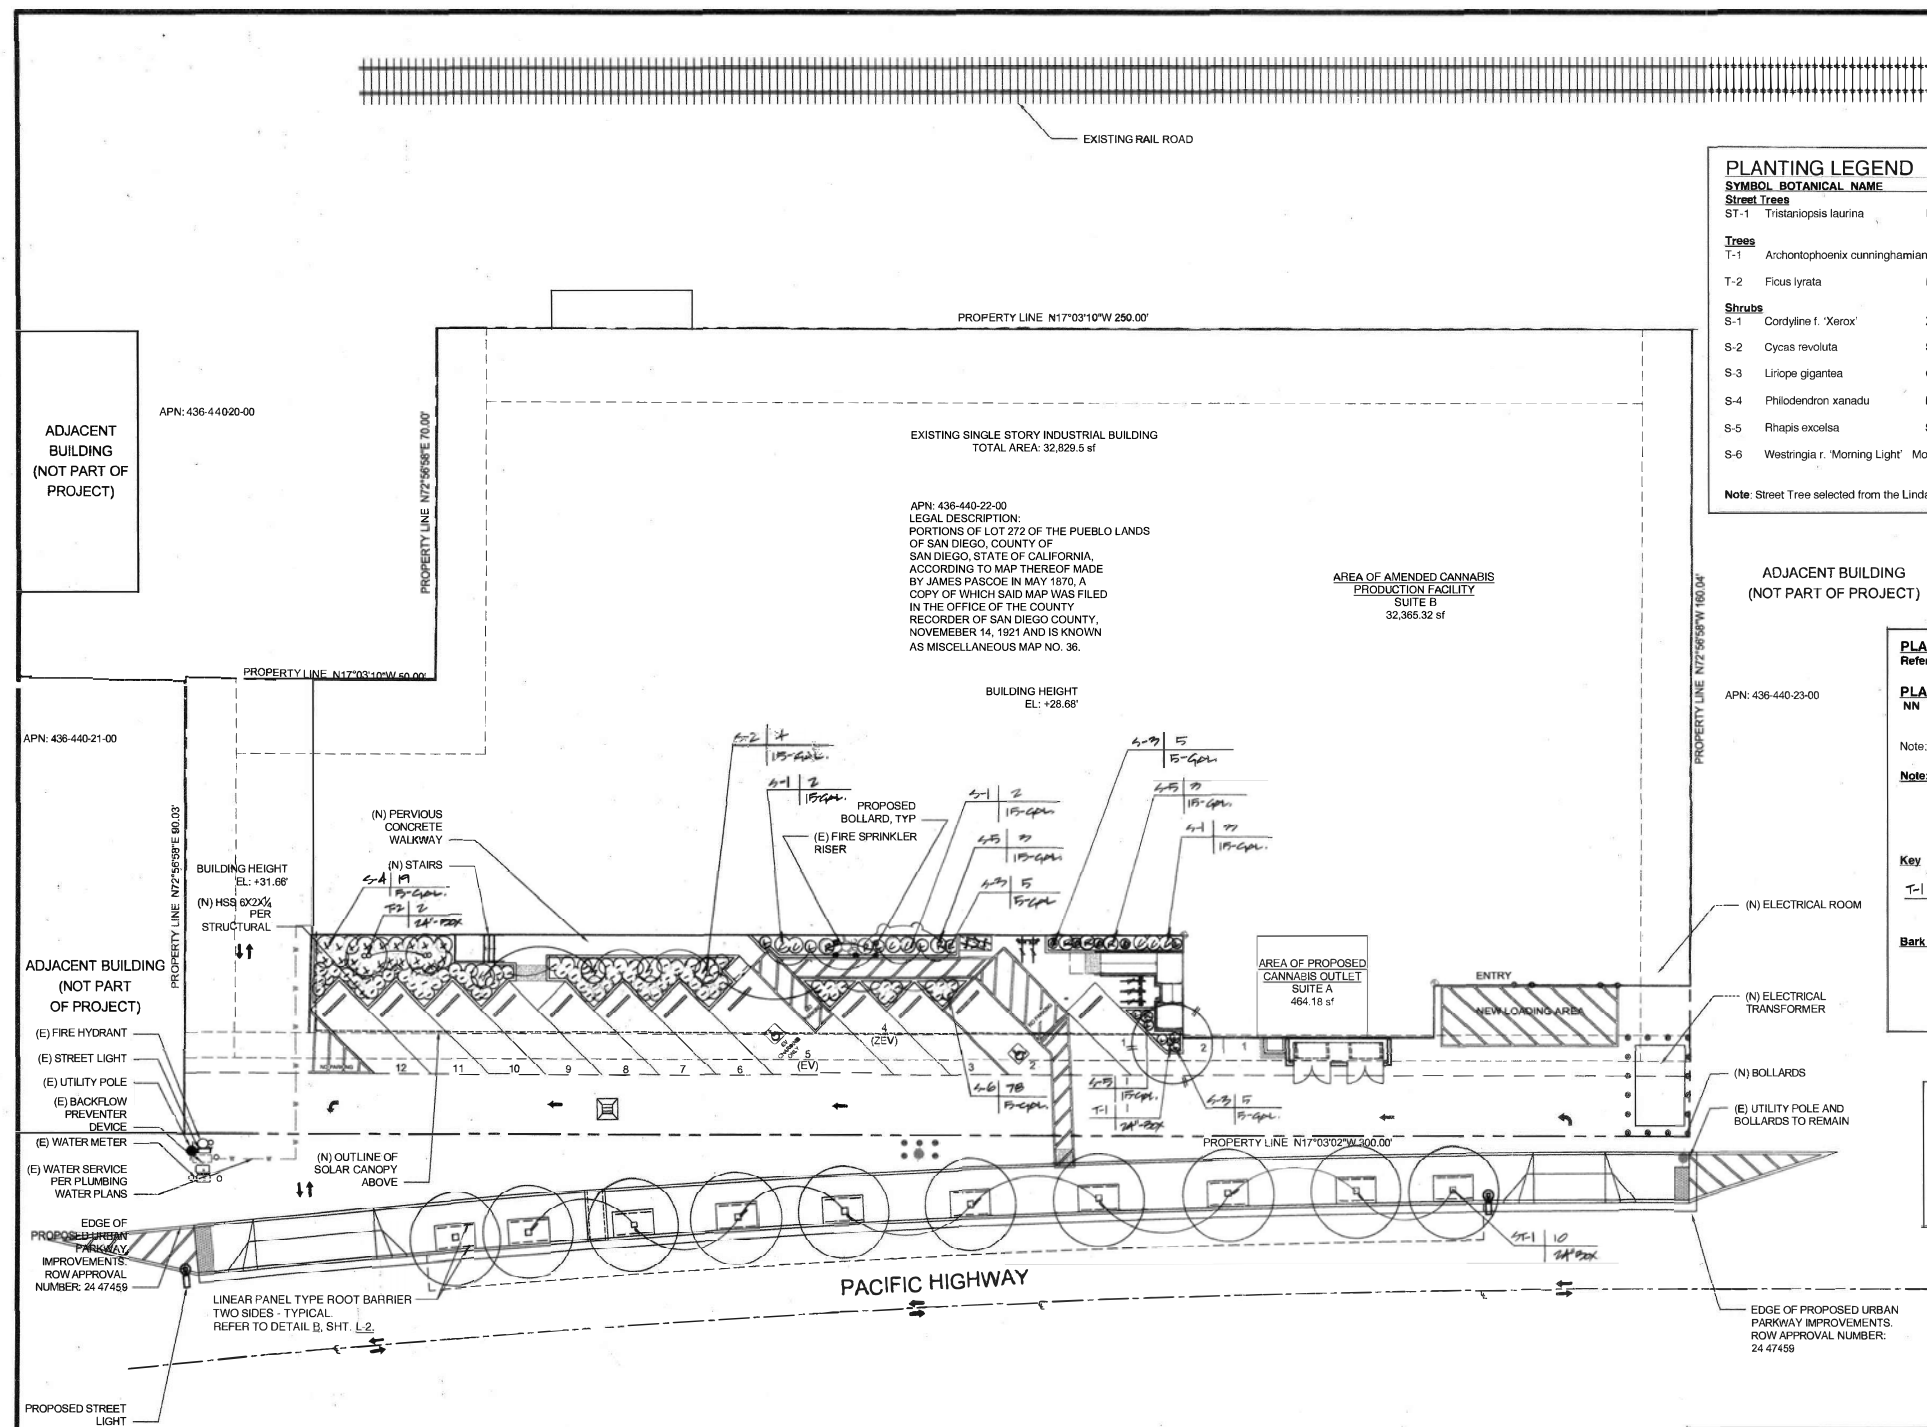

01	11.06.20 Building Permit - Submittal 1
02	12.00.20 Building Permit - Submittal 2
MARK DATE DESCRIPTION	
PROJECT NO: 2016	
CAD DWG FILE:	
DRAWN BY: SW	
CHK'D BY: SW	
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SHEET TITLE	
PLANTING PLAN	
L-1	
SHEET	OF

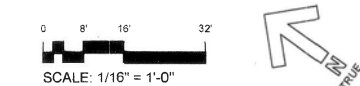PLANTING NOTES

1. THE CONTRACTOR SHALL MAINTAIN A QUALIFIED ENGLISH SPEAKING SUPERVISOR ON THE SITE AT ALL TIMES DURING CONSTRUCTION THROUGH COMPLETION OF PICK-UP WORK.
2. THE CONTRACTOR SHALL VERIFY ALL PLANT MATERIAL QUANTITIES PRIOR TO INSTALLATION. PLANT MATERIAL QUANTITIES ARE LISTED FOR THE CONVENIENCE OF CONTRACTOR. ACTUAL NUMBER OF SYMBOLS SHALL HAVE PRIORITY OVER QUANTITY DESIGNATED.
3. THE CONTRACTOR SHALL FURNISH AND PAY FOR ALL CONTAINER GROWN TREES, SHRUBS AND GROUND COVER. THE CONTRACTOR SHALL ALSO BE RESPONSIBLE AND PAY FOR PLANTING OF ALL PLANT MATERIALS, GUARANTEE OF ALL PLANT MATERIAL THROUGH THE MAINTENANCE PERIOD, THE STAKING AND GUYING OF TREES AND THE CONTINUOUS PROTECTION OF ALL PLANT MATERIALS UPON THEIR ARRIVAL AT THE SITE.
4. GROUND COVER MASSING SHALL BE CONTINUOUS AS SHOWN ON PLANTING PLAN.
5. ALL PLANT MATERIAL SHALL BE SUBJECT TO APPROVAL BY THE LANDSCAPE ARCHITECT AND / OR OWNER PRIOR TO INSTALLATION.
6. ALL PLANT MATERIAL SHALL BE SPOTTED BY THE LANDSCAPE ARCHITECT. PROVIDE FOR LIMITED FINE PRUNING OF ALL TREES AFTER PLANTING AND ONLY AS REQUESTED BY THE LANDSCAPE ARCHITECT.
7. ALL SOIL PREPARATION SHALL BE INSTALLED AS PER THE SOIL PREPARATION NOTES ON THIS SHEET.
8. FOR TREES AND GROUND COVER USE THE FOLLOWING BACKFILL PER CUBIC YARD OF MATERIAL. EXCAVATE THE PLANTING PITS FOR TREES, SHRUBS AND GROUND COVER TWICE THE WIDTH AND TO THE SAME DEPTH OF THE ROOTBALL. USE THE FOLLOWING BACKFILL MIX AROUND THE ROOTBALL WITH ALL ROCK AND DEBRIS LARGER THAN TWO (2) INCHES IN DIAMETER REMOVED.

- 2% NATIVE SOIL
- 1% NITROGEN FERTILIZED ORGANIC MATERIAL
- 8-8-4 COMMERCIAL FERTILIZER 1 POUND / CU. YD.
- IRON 2 OZ. / CU. YD.
- ZINC 1 OZ. / CU. YD.
- MANGANESE 1 OZ. / CU. YD.

SET PLANT IN CENTER OF PIT SO THAT WHEN SETTLED THE PLANT GROWN WILL BE SLIGHTLY ABOVE SURROUNDING GRADE. BACKFILL WITH PREPARED SOIL, TAMP AND WATER THOROUGHLY.

9. FOR GROUND COVER AREAS (EXCLUDING PLANTING AREAS STEEPER THAN 10% OR 10:1) APPLY THE FOLLOWING MATERIALS PER EACH 1,000 SQUARE FEET OF PLANTING AREA. CROSS RIP ALL GROUND COVER AREAS. DO NOT DISTURB OR RIP SLOPE AREAS. SEE ABOVE) TO A DEPTH OF TWELVE (12) INCHES AND BLEND THE FOLLOWING AMENDMENTS INTO THE TILLED SOIL TO A DEPTH OF EIGHT (8) INCHES:

- 4.0 CU. YD. NITROLIZED REDWOOD COMPOST
- 1.0 LBS. NITROGEN
- 1.0 LBS. PHOSPHOROUS (P205)
- 1.0 LBS. POTASSIUM (K2O)
- .01 LBS. BORON


RECOMPACT AND ROLL FLAT PLANTING AREAS UPON COMPLETION OF SOIL PREPARATION.

10. FERTILIZER TABLETS SHALL BE AGRIFORM, 21 GRAM TABLETS (20-10-5) IN QUANTITIES AS FOLLOWS:


- 1 GALLON SHRUB 1
- 5 GALLON SHRUB AND TREE 3
- 15 GALLON SHRUB 4
- 15 GALLON TREE 5
- BOX MATERIALS 1 PER 4' OF BOX SIZE

PLACE TABLETS AT HALF THE DEPTH OF THE ROOTBALL FOR ALL CONTAINER MATERIAL PER PLANTING DETAILS.

11. INSTALL A THREE (3) INCH LAYER OF MEDIUM GRIND REDWOOD BARK OR CEDAR BARK AS SPECIFIED ON PLANTING PLAN IN ALL SHRUB AND GROUND COVER AREAS FOLLOWING COMPLETION OF PLANTING AND FINE GRADING.
12. FALLOW AREAS SHALL BE RAKED CLEAN OF ALL WEEDS AND DEBRIS AND THE FINISH GRADED 1" OR 1" OF DRAINAGE. BROOM AND WASH ALL PAVEMENT AREAS CLEAN UPON COMPLETION.
13. CONTRACTOR SHALL ALLOW IN HIS BID FOR DOUBLE STAKING OF ALL SINGLE TRUNK TREES. USE MINIMUM 1" DIAMETER LOGGERS AND TWO (2) 7/16" TWIST TIRES FOR EACH SINGLE TRUNK TREE. CONTRACTOR TO PROVIDE FOR GUYING OF MULTI TRUNK AND LOW BRANCHING TREES IF ON-SITE USING MATERIALS AND METHODS AS APPROVED BY THE LANDSCAPE ARCHITECT.
14. CONTRACTOR SHALL GUARANTEE ALL NEW PLANT MATERIAL FOR A PERIOD OF ONE (1) YEAR UPON ACCEPTANCE OF PROJECT BY OWNER. A ONE (1) YEAR GUARANTEE SHALL APPLY TO ANY NECESSARY REPLACEMENT PLANT MATERIAL FROM THE DATE OF REPLACEMENT INSTALLATION.

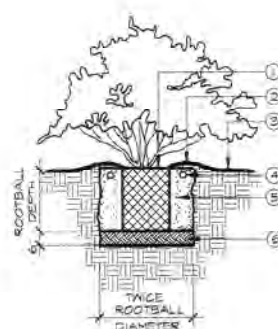

SHRUB PLANTING

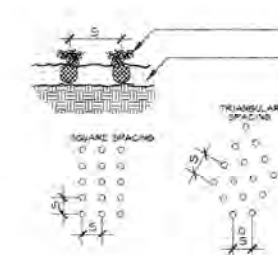

GROUND COVER PLANTING


1. ROOTBALL CROWN SHALL BE FLUSH WITH FINISH GRADE. AVOID PLANTING SHRUBS DIRECTLY IN FRONT OF IRRIGATION SPRAY HEADS. PROVIDE CLEARANCE WHEN POSSIBLE.
2. 3" HIGH WATER RETENTION BASIN FORM FROM PLANT PIT EXCAVATION MAY BE WORK AS DIRECTED BY LANDSCAPE ARCHITECT.
3. FINISH GRADE.
4. FERTILIZER TABLETS PER PLANTING NOTES.
5. PREPARED BACKFILL PER PLANTING NOTES.
6. 6" ZONE OF OVER-EXCAVATED AND RE-COMPACTED NATIVE SOIL.

C L-2

1. GROUND COVER TO BE PLANTED IN PLAYS, CUTTINGS, LINES OR GAL. CONTAINERS PER PLANS.
 2. SOIL PREP - REFER TO PLANTING NOTES.
- REFER TO PLANTING NOTES FOR ADDITIONAL SPECIFICATIONS.

SPACING	50 FT PLANTS WILL COVER	64 PLANTS 100 PLANTS
4"	7 50 FT. (1) 50 FT.	
6"	10 50 FT. (2) 50 FT.	
8"	16 50 FT. (4) 50 FT.	
10"	25 50 FT. (5) 50 FT.	
12"	33 50 FT. (7) 50 FT.	
15"	44 50 FT. (9) 50 FT.	
18"	56 50 FT. (11) 50 FT.	
24"	78 50 FT. (15) 50 FT.	

5' REFERS TO SPACING

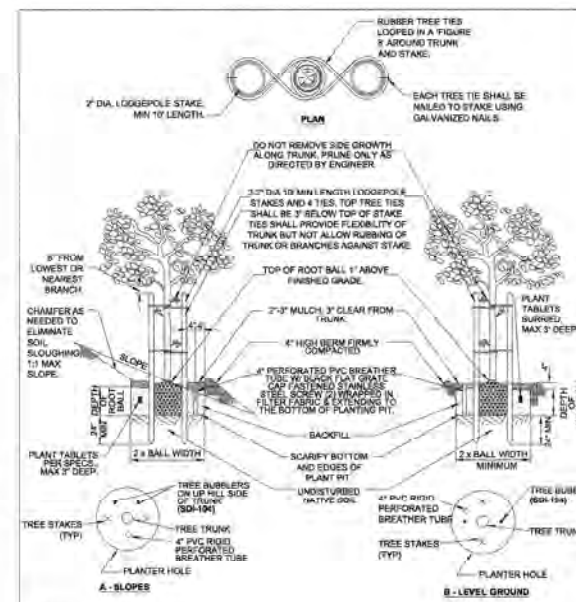

NOTES

1. DOUBLE STAKE 15 GAL. AND LARGER TREES. SINGLE STAKE TREES SMALLER THAN 15 GAL.
2. FOR SINGLE STAKED TREES, PLACE STAKE ON WINDWARD SIDE OF TREE.
3. LOCATE STAKES OUTSIDE OF ROOTBALL.
4. PROVIDE MINIMUM DISTANCE FROM OTHER OBJECTS AS FOLLOWS:
- 10' TRAFFIC SIGNALS, ST. STREET LIGHTS, 10' FIRE HYDRANTS, SEWER LINES AND SOGGERS FOR PAD MOUNTED EQUIPMENT.
- 5' UNDERGROUND SQUARE ELECTRIC AND GAS LINES.

REVISIONS: 1. DATE: 09/18
2. BY: SW
3. BY: SW

CITY OF SAN DIEGO - STANDARD DRAWING


DESIGNED BY: NICKY...
DRAWN BY: SW
CHECKED BY: SW

TREE PLANTING AND STAKING

SD-101

TREE PLANTING

A L-2

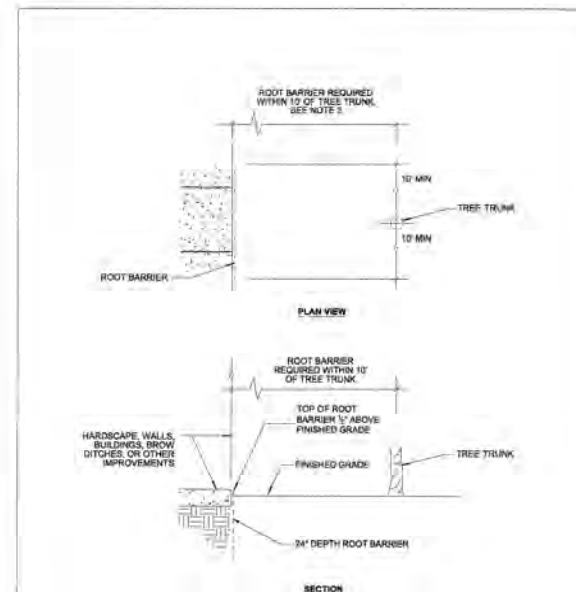

NOTE

1. ROOT BARRIER SHALL BE INSTALLED ADJACENT TO THE IMPROVEMENT AND NOT AROUND THE ROOTBALL.
2. ROOT BARRIER REQUIRED WHEN TREE TRUNK IS WITHIN 10' OF HARDSCAPE, WALLS, BUILDINGS, BROW DITCHES OR OTHER IMPROVEMENTS.
3. FOR ROOT BARRIER INSTALLATION WITH THE TREE GRATES SEE SD-104.

REVISION	BY	DATE	DESCRIPTION
1	SW	09/18	ISSUED FOR PERMIT
2	SW	09/18	ISSUED FOR PERMIT

CITY OF SAN DIEGO - STANDARD DRAWING

DESIGNED BY: NICKY...
DRAWN BY: SW
CHECKED BY: SW

ROOT CONTROL BARRIER

SD-106

LINEAR ROOT BARRIER

B L-2

TECHNE
DESIGN | DEVELOPMENT

2934 Lincoln Ave., San Diego, CA 92104
techne-us.com sustainablendesign.org
619-940-5814 m 313-595-5814

CONSULTANTS

SAM WADE
Landscape Architect

2754 Geneva Ave. Suite 202
San Diego, CA 92109
619-592-4626
sam@samwadelandscape.com
www.samwadelandscape.com
82 UC #2076 Y CA LIC #8107

4909 Pacific Highway,
San Diego, CA 92110

OWNER
RAP Holdings, LLC & United Partners, LLC

MARK	DATE	DESCRIPTION
01	10.00.19	Building Permit - 1st Submittal

PROJECT NO: 2016
CAD DWG FILE:
DRAWN BY: SW
CHK'D BY: SW

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PLANTING DETAILS, NOTES

Sam Wade Landscape Architect
7-31-23
12-7-23
STATE OF CALIFORNIA

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DESIGN | DEVELOPMENT

7934 Lincoln Ave., San Diego, CA 92104
 techne-us.com sustainablearchitecture.org
 619-940-5814 m 313-595-5814

CONSULTANTS



SAM WADE

Landscape Architect

2204 Garnet Ave, Suite 205
 San Diego, CA 92109
 Tel: 619-270-8688
 sam@samwadelandscapearchitect.com
 samwadelandscapearchitect.com
 AZ LIC #26705 | CA LIC #7201

4909 Pacific Highway,
 San Diego, CA 92110

OWNER

RAP Holdings, LLC & United Partners,
 LLC

IRRIGATION LEGEND

SYM.	MANUFACTURER	MODEL NO.	DESCRIPTION	RAD.	G.P.M.	P.S.I.	PATTERN	DETAIL/HT.
B	RAINBIRD	RWS-B-C-1401	WATERING W/ WITH RWS-SOCK	25	GPM	30	-	A/L-4
-	NETAFIM	TLCV0-12	IN-LINE EMITTER TUBING (SHRUBS)	6	GPH*	25	-	B/L-4
NOTE: CONTRACTOR TO PIN IN-LINE EMITTER TUBING ON GRADE USING GROUND STAPLES AT 12" ON CENTER, SHADE TUBING WITH BARK PER PLANTING PLAN. USE BURIED PVC SCH. 40 SOLID PIPE BETWEEN SHRUB DRIP ZONES; SIZE PER PLAN, MIN. 1/2" DIA.								
○	NETAFIM	TL050MFV-1	AUTOMATIC FLUSH VALVE	INSTALL ONE (1) FLUSH VALVE PER DRIP ZONE AT FURTHEST AND LOWEST MOST POINT IN EACH DRIP CIRCUIT				C/L-4
△	NETAFIM	TLAVR	AIR/VACUUM RELIEF VALVE	INSTALL AT HIGHEST POINT				D/L-4
⊙	RAINBIRD	KXZ-100	HEMOI-E CONTROL VALVE W/ BALL VALVE, IN-LINE FILTER AND PRESSURE REGULATOR					E/L-4
⊙	RAINBIRD	100-PEBR	1" ELECTRIC MASTER VALVE					F/L-4
⊙	WILKINS	975XL	3/4" REDUCED PRESSURE PRINCIPLE BACKFLOW PREVENTER					G/L-4
⊙	WILKINS	70	SERIES 3/4" PRESSURE REGULATING VALVE					H/L-4
⊙	NIBCO		BRASS BALL VALVE, LINE SIZE					I/L-4
⊙	APPROVED		PVC SCHEDULE 40 NON-PRESSURE LATERAL PIPE, SIZE PER PLAN					J/L-4
⊙	APPROVED		PVC SCHEDULE 40 PRESSURE LATERAL PIPE, SIZE PER PLAN					J/L-4
⊙	HUNTER		PRO C-PC-4 MODULAR IRRIGATION OUTDOOR CONTROLLER, W/ SOLAR SYNC W/ FLOW-CLICK, 4 STATION CONTROLLER MOUNTED ON EXTERIOR BUILDING WALL					K/L-4
⊙	HUNTER		FLOW-CLICK / SCT-100 HIGH FLOW SENSOR					
⊙	HUNTER		WSS-SEN-SOLAR SYNC RAIN / ET SENSOR, MOUNTED ATOP BUILDING FASCIA, REFER TO PLAN.					
⊙	PROPOSED		IRRIGATION POINT OF CONNECTION; REFER TO NOTE ON PLAN.					
⊙	PROPOSED		ELECTRICAL POINT OF CONNECTION, 120V POWER FOR IRRIGATION CONTROLLER; REFER TO NOTE ON PLAN.					
⊙	EXISTING		POTABLE WATER TUBE / PIPE TO BUILDING; PROTECT IN PLACE.					
⊙	EXISTING		POT HOLE TO VERIFY EXACT PIPE TYPE AND LOCATION IN FIELD. WATER METER IN CONCRETE METER BOX IN RIGHT-OF-WAY					

ADJACENT BUILDING (NOT PART OF PROJECT)


APN: 436-440-23-00

VALVE CALL OUT KEY

- A-1 INDICATES CONTROLLER PROGRAM* AND STATION / CONTROL VALVE NUMBER
- 1/10 INDICATES CONTROL VALVE FLOW (GALLONS PER MINUTE (GPM))
- INDICATES CONTROL VALVE SIZE


IRRIGATION CONTROL VALVE STATION PROGRAMS

*A1 DENOTES SHRUB DRIP IRRIGATION AREAS TO BE ASSIGNED TO PROGRAM A ON CONTROLLER.
 *B1 DENOTES TREE IRRIGATION TO BE ASSIGNED TO PROGRAM B ON CONTROLLER.

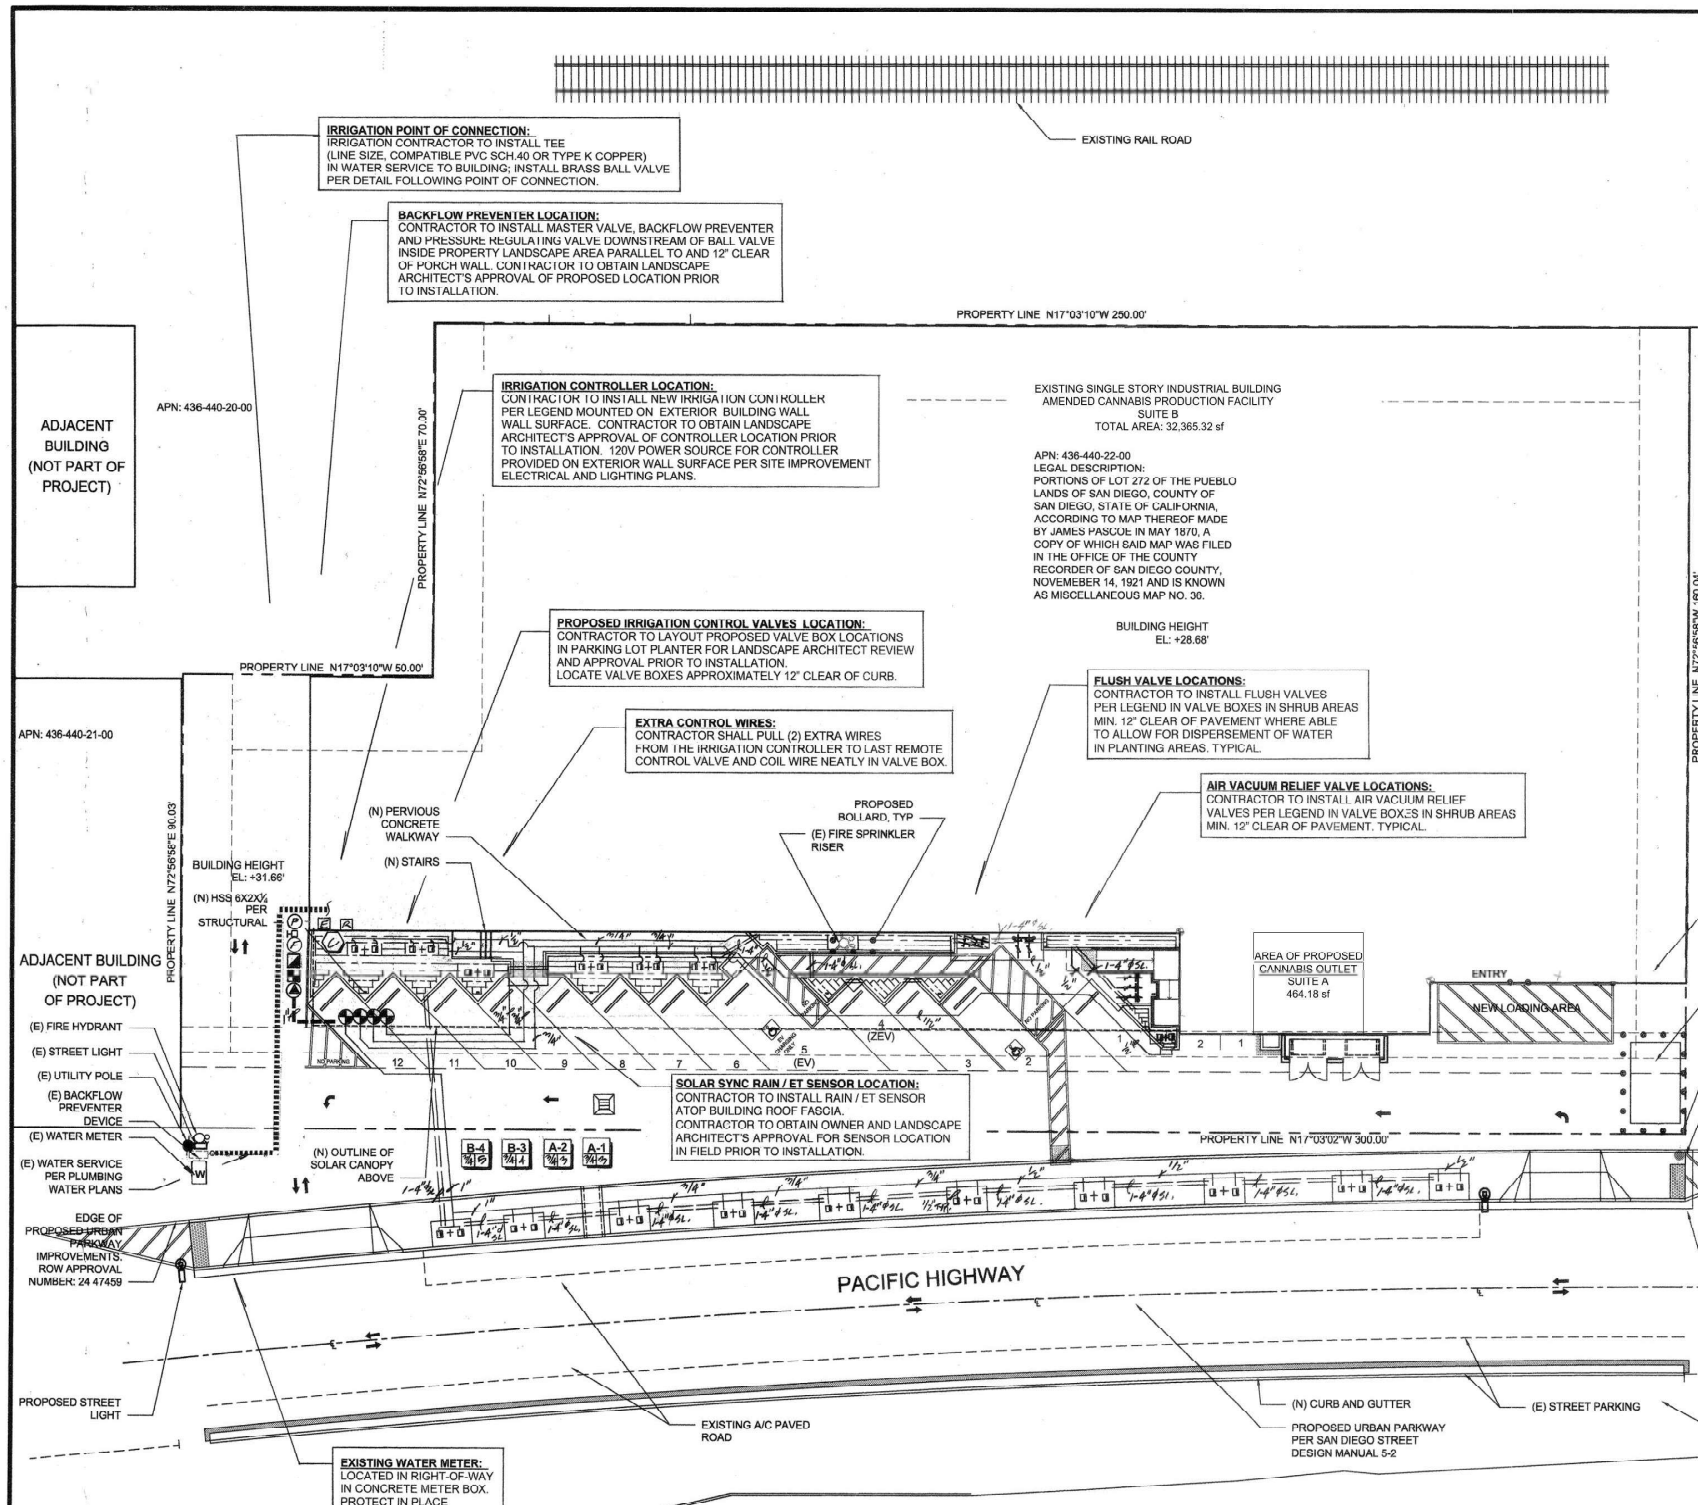

GENERAL IRRIGATION NOTES

- INSTALL ALL COMPONENTS IN CONFORMANCE WITH CURRENT CITY OF SAN DIEGO REQUIREMENTS.
- THE CONTRACTOR SHALL BRING ANY DISCREPANCIES FOUND OR ENCOUNTERED IN THE PLANS OR IN THE ACTUAL FIELD CONDITIONS TO THE ATTENTION OF THE LANDSCAPE ARCHITECT IMMEDIATELY AND PRIOR TO PROCEEDING FURTHER WITH THE WORK.
- INSTALL ALL SPRINKLER RISERS ASSEMBLIES WITH DOUBLE SWING JOINT ASSEMBLIES UTILIZING MARLEX STREET ELLS AND A MINIMUM 1/2" LONG PVC SCH. 80 NIPPLE. AHH. USE TEFLON TAPE ON ALL THREADED PIPE CONNECTIONS.
- INSTALL ALL DRIPLINE ASSEMBLIES WITH NEW BARBED FITTINGS OR COMPRESSION TYPE DRIPLINE FITTINGS AS SPECIFIED PER PLANS AND DETAILS AS MANUFACTURED BY NETAFIM.
- INSTALL ALL VALVE ASSEMBLIES, AIR VACUUM RELIEF DEVICES AND FLUSH VALVES IN NEW TAN PLASTIC VALVE BOXES AS MANUFACTURED BY NDS.
- REFER TO THE IRRIGATION NOTES FOR ADDITIONAL PROJECT REQUIREMENTS

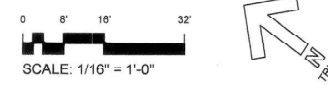

DIG ALERT

BEFORE EXCAVATING, CONTRACTOR SHALL VERIFY THE LOCATION OF ALL UTILITIES AT LEAST TWO (2) WORKING DAYS PRIOR TO EXCAVATION BY CALLING UNDERGROUND SERVICE ALERTS @ 1-800-227-2909. CONTRACTOR SHALL REQUEST THE MARK-OUT OF UNDERGROUND UTILITIES INCLUDING BUT NOT LIMITED TO: GAS, ELECTRIC, TELEPHONE, WATER, SEWER, LIGHTING, TELEVISION. CONTRACTOR SHALL BE RESPONSIBLE TO POT HOLE TO VERIFY EXACT LOCATION OF UTILITIES FOLLOWING MARK-OUT.



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01	11.06.20	Building Permit - Submittal 1
02	12.09.20	Building Permit - Submittal 2

MARK	DATE	DESCRIPTION
PROJECT NO:	2019	
CAD DWG FILE:		
DRAWN BY:	SW	
CHK'D BY:	SW	

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SHEET TITLE

IRRIGATION PLAN


L-3

SHEET OF

Pacific Highway
San Diego, CA


IRRIGATION NOTES

- ALL MAIN LINE PIPING AND CONTROL WIRES UNDER PAVING SHALL BE INSTALLED IN SEPARATE SLEEVES. MAIN LINE SLEEVE SIZE SHALL BE A MINIMUM OF TWICE (2X) THE DIAMETER OF THE PIPE TO BE SLEEVED. CONTROL WIRE SLEEVES SHALL BE OF SUFFICIENT SIZE FOR THE REQUIRED NUMBER OF WIRES UNDER PAVING OR AS IDENTIFIED ON PLAN.
- ALL LATERAL LINE PIPING UNDER PAVING SHALL BE AS CALLED FOR ON THE IRRIGATION PLAN AND SHALL BE INSTALLED PRIOR TO PAVING WHERE REQUIRED.
- PIPE SIZES SHALL CONFORM TO THOSE SHOWN ON THE DRAWINGS. NO SUBSTITUTIONS OF SMALLER PIPE SIZES SHALL BE PERMITTED, BUT SUBSTITUTIONS OF LARGER SIZES MAY BE APPROVED. ALL DAMAGED AND REJECTED PIPE SHALL BE REMOVED FROM THE SITE AT THE TIME OF SAID REJECTION.
- ALL IN-LINE EMITTER DRIP IRRIGATION TUBING AND IRRIGATION SYSTEM PVC PIPING SHALL BE SET PARALLEL TO FINISH GRADE UNLESS OTHERWISE SPECIFIED.
- THE LANDSCAPE CONTRACTOR SHALL FLUSH AND ADJUST ALL DRIP IRRIGATION SYSTEMS AND VALVES FOR OPTIMUM FLOW AND COVERAGE WITH NO OVERFLOW OR NO PAVING. COVERAGE SHALL BE CONTAINED TO THE PROJECT LIMITS AS SHOWN ON THE IRRIGATION PLAN.
- THE IRRIGATION SYSTEM DESIGN IS DIAGRAMMATIC. ALL PIPING, VALVES, ETC., SHOWN WITHIN PAVED AREAS IS FOR DESIGN CLARIFICATION ONLY AND SHALL BE INSTALLED ONLY ON THE PROJECT PREMISES AND IN PLANTING AREAS WHEREVER POSSIBLE. THE LANDSCAPE CONTRACTOR SHALL LOCATE ALL VALVES IN SHRUB AREAS. OBTAIN LANDSCAPE ARCHITECT'S APPROVAL PRIOR TO EXCAVATION FOR VALVES AND VALVE BOXES.
- CONTROL WIRE SHALL BE INSTALLED IN THE MAIN LINE TRENCH WHENEVER POSSIBLE. WIRE SHALL BE CONTINUOUS WITHOUT SPLICES EXCEPT AT CONTROL VALVES. ALL WIRE UNDER PAVING SHALL BE ENCASED IN A PVC SLEEVE.
- IT IS THE RESPONSIBILITY OF THE LANDSCAPE CONTRACTOR TO FAMILIARIZE HIMSELF WITH ALL GRADE DIFFERENCES, LOCATION OF WALLS, RETAINING WALLS, STRUCTURES AND UTILITIES. THE LANDSCAPE CONTRACTOR SHALL REPAIR OR REPLACE ALL ITEMS DAMAGED BY HIS WORK. HE SHALL COORDINATE HIS WORK WITH OTHER CONTRACTORS FOR THE LOCATION AND INSTALLATION OF PIPE SLEEVES AND LATERALS THROUGH WALLS, FOOTINGS AND BENEATH ROADWAYS AND WALKWAYS.
- THE IRRIGATION SYSTEM IS BASED ON A MINIMUM OPERATING PRESSURE OF 85 PSI AND A MAXIMUM FLOW DEMAND OF 5 GPM. LANDSCAPE CONTRACTOR SHALL VERIFY WATER PRESSURE PRIOR TO CONSTRUCTION. REPORT ANY DIFFERENCE BETWEEN THE WATER PRESSURE INDICATED ON THE DRAWINGS AND THE ACTUAL PRESSURE READING AT THE IRRIGATION POINT OF CONNECTION TO THE OWNER'S AUTHORIZED REPRESENTATIVE.
- THE CONTRACTOR SHALL NOT WILLFULLY INSTALL THE IRRIGATION SYSTEM AS SHOWN ON THE DRAWINGS WHEN IT IS OBVIOUS IN THE FIELD THAT UNKNOWN OBSTRUCTIONS, GRADE DIFFERENCES OR DIFFERENCES IN THE AREA DIMENSIONS EXIST THAT MIGHT NOT HAVE BEEN CONSIDERED IN THE DESIGN. SUCH OBSTRUCTIONS OR DIFFERENCES SHOULD BE BROUGHT TO THE ATTENTION OF THE OWNER'S AUTHORIZED REPRESENTATIVE AND THE LANDSCAPE ARCHITECT. IN THE EVENT THIS NOTIFICATION IS NOT PERFORMED, THE LANDSCAPE CONTRACTOR SHALL ASSUME FULL RESPONSIBILITY FOR ANY REVISIONS NECESSARY.
- ALL IRRIGATION SYSTEM EQUIPMENT NOT OTHERWISE DETAILED OR SPECIFIED SHALL BE INSTALLED AS PER MANUFACTURER'S RECOMMENDATIONS AND SPECIFICATIONS.
- ALL CONTROL WIRE SPLICES SHALL BE INSTALLED IN PLASTIC VALVE BOXES.
- ALL WIRE SPLICES SHALL BE MADE WITH KING TECHNOLOGY'S MODEL KING-4 WIRE CONNECTORS.
- ALL VALVES SHALL BE INSTALLED IN BROWN PLASTIC VALVE BOXES AS AVAILABLE FROM NDS.
- ALL WORK AND MATERIALS SHALL BE UNCONDITIONALLY GUARANTEED FOR ONE (1) YEAR AFTER FINAL ACCEPTANCE. VANDALIZING OR ABUSE OF MATERIALS IS NOT A PART OF THIS GUARANTEE.
- ALL WORK SHALL BE INSTALLED IN CONFORMANCE WITH CITY OF SAN DIEGO REQUIREMENTS AND IN ACCORDANCE WITH THE IRRIGATION PLAN, NOTES AND DETAILS.

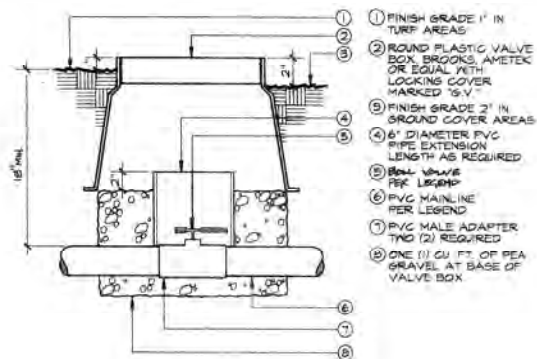


BALL VALVE

I
L-4

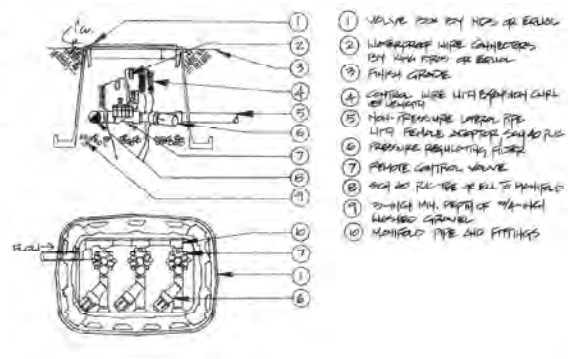


REMOTE CONTROL VALVE-DRIP

E
L-4

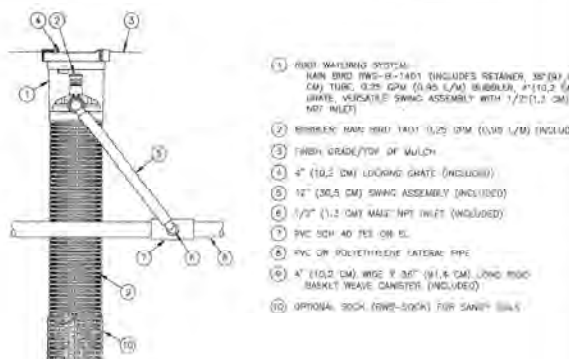


ROOT WATERING SYSTEM / TREES

A
L-4

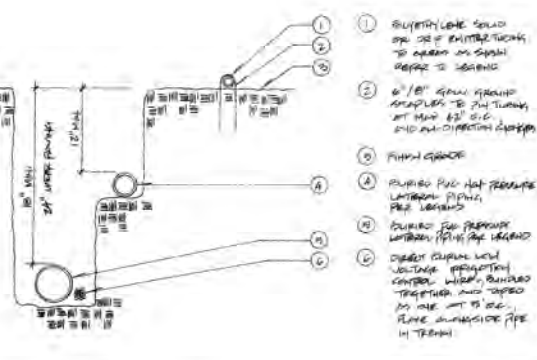


PIPING, SLEEVING

J
L-4

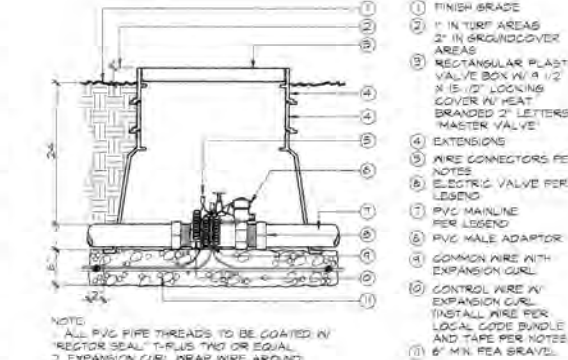


MASTER VALVE

F
L-4

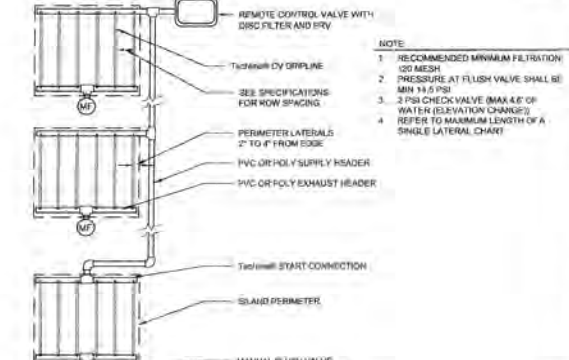


DRIP EMITTER TUBING / SHRUBS

B
L-4

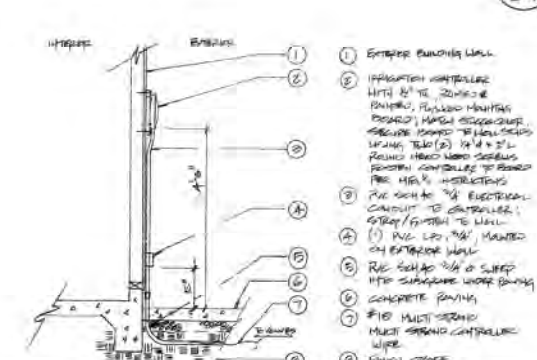


IRRIGATION CONTROLLER

K
L-4

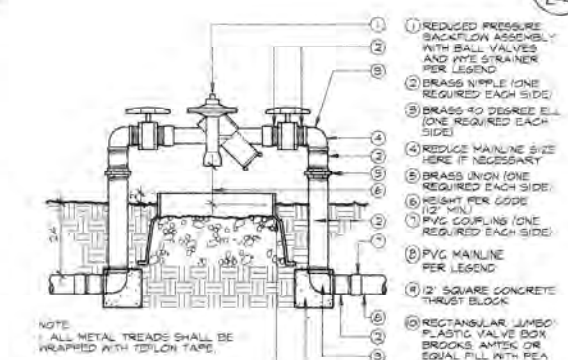


BACKFLOW PREVENTER

G
L-4

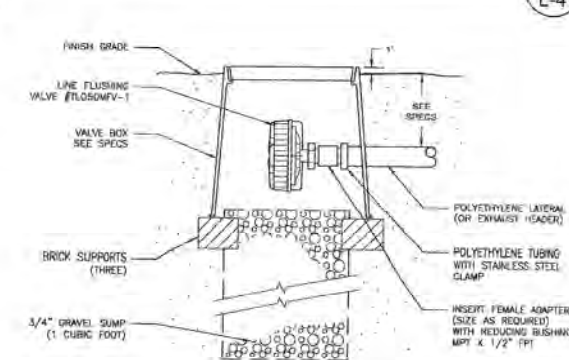

FLUSH VALVE

C
L-4

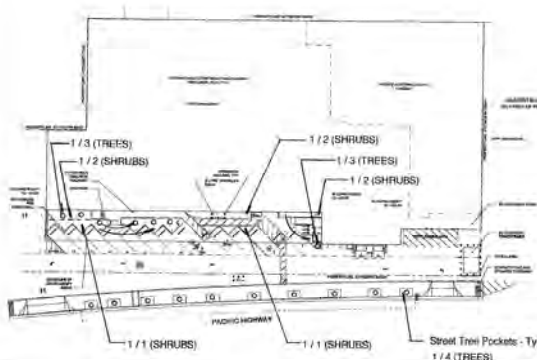

HYDROZONE DIAGRAM

SCALE: 1" = 50'
Refer to Irrigation Plan for Specific Detail of Hydrozones


KEY:
HYDROZONE - 1 (Controller) / 1 (Valve No.)



Estimated Total Landscape Water Usage Calculations


Controller No. / Valve	ETWU ((ETo)(0.62))((P x 3.6) + SLA)	Result in Gallons per Year
1/A-1	(40 x .62) x (1.81) x (528 / .81) = 0	1,995
1/A-2	(40 x .62) x (4.81) x (288 / .81) = 0	4,336
1/B-3	(40 x .62) x (4.81) x (120 / .81) = 0	1,890
1/B-4	(40 x .62) x (4.81) x (400 / .81) = 0	6,001
Total ETWU gallons per year		14,122

MAWA Budget Calculation
(40 x .62) (.45 x 1,336) + 0
24.8 x 601.2 = 14,910 gallons per year allowance
14,122 Estimated Usage (Days)

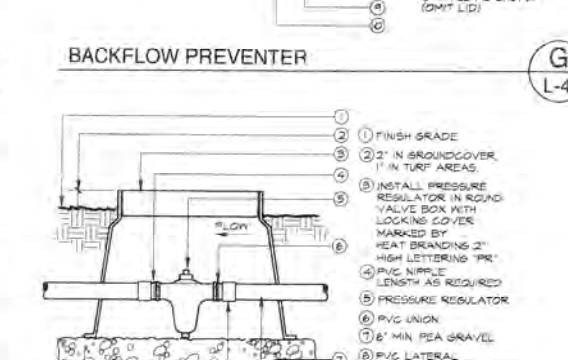

PRESSURE REGULATING VALVE

H
L-4

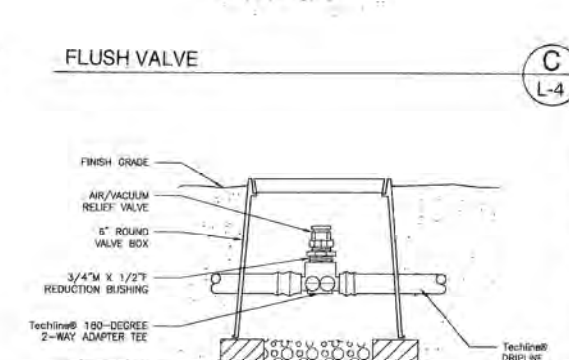

AIR VACUUM RELIEF VALVE

D
L-4



2934 Lincoln Ave., San Diego, CA 92104
techne-us.com | info@techneus.com
619-940-5814 | 619-595-5814

CONSULTANTS



3344 Carmel Ave., Suite 202
San Diego, CA 92109
Tel: 619-270-8800
www.samwadelandscape.com
sam.wade@samwadelandscape.com
REG. LIC. #26361 | CAL. LIC. #3303

4909 Pacific Highway,
San Diego, CA 92110

OWNER

RAP Holdings, LLC & United Partners,
LLC

MARK	DATE	DESCRIPTION
01	10.00	19 Building Permit - 1st Submittal

PROJECT NO: 2016
CAD DWG FILE:
DRAWN BY: SW
CHK'D BY: SW
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IRRIGATION DETAILS,
NOTES

SHEET
L-4
OF