La Jolla Shores Planned District Advisory Board (LJSPDAB) **Online Virtual Meeting**

Please provide the following information on this form to schedule your project at an upcoming La Jolla Shores Planned District Advisory Board meeting.

FOr	Actio	าท เ	ΙTΡ	mς

For Ac	tion Items
•	Project Tracking System (PTS) Number and Project Name (only submitted projects can be
	heard as action items):
•	PTS # 0691672
•	Address and APN(s):7951 Paseo Del Ocaso, La Jolla and APN: 346-512-07-00
•	Project contact name, phone, e-mail: <u>Chandra Slaven, 619-316-7645,</u>
	chandraslaven@gmail.com
•	Project description: Please see attached
•	Please indicate the action you are seeking from the Advisory Board:
	☐Recommendation that the Project is minor in scope (Process 1)
	□Recommendation of approval of a Site Development Permit (SDP)
	□Recommendation of approval of a Site Development Permit (SDP) and Coastal
	Development Permit (CDP)
	☑Other: <u>Recommendation of Approval Consistent with the LCP/Municipal Code</u>
•	In addition, provide the following:
	o lot size: <u>7,489 SF (0.172 acres)</u>
	 existing structure square footage <u>and</u> FAR (if applicable): <u>1,799 SF / 0.24 FAR</u>
	o proposed square footage and FAR: (conditioned area only, not including Garage and
	Mech room): 3,503 SF / 0.47 FAR
	existing and proposed setbacks on all sides: Existing Setbacks: Street- 18'; North
	Side- 3'; Back- 17'; South Side- 2'-6". (There is also an existing dilapidated shed in the
	back yard that is within the easement and approximately 2' from rear PL). Proposed
	Setbacks: Street- 16'; North Side- 4'; Back- 13'; South Side- 2'-6"
	 height if greater than 1-story (above ground): <u>Primary Second Story Parapet Height</u> -
	23'-7 1/2"; High Point of Stair Enclosure Above Existing Grade - 29'-3 1/2"
	<u> </u>
For Inf	formation Items (For projects seeking input and direction. No action at this time)
•	Project name (Unsubmitted projects can be informational items if the development team is
	seeking comments and direction from the Trustees on the concept):
•	Address and APN(s):
•	Project contact name, phone, e-mail:
•	Project description:
•	In addition to the project description, please provide the following:
	o lot size:
	 existing structure square footage and FAR (if applicable):
	o proposed square footage and FAR:
	 existing and proposed setbacks on all sides:
	o height if greater than 1-story (above ground):
•	Project aspect(s) that the applicant team is seeking Advisory Board direction on. (community
-	character, aesthetics, design features, etc.):
	character, acouncies, acoign reatares, etc.,.

1 Form Updated: 1/22/2021

Exhibits and other materials to provide:

Exhibits and other project-related presentation materials (e.g. site plan, elevations, exhibits showing addition/remodel areas, etc.) although not required, are extremely helpful in informing the Advisory Board's review and understanding of a project. The following exhibits and materials are recommended and if provided by the applicant, will be attached to the agenda and posted to the City's website: https://www.sandiego.gov/planning/community/profiles/lajolla/pddoab for view by the public:

- All exhibits should be sized to 8 ½" X 11" format
- Exhibits, which can contain the following:
 - A. A site plan showing the street, the property line on all sides, the setbacks on all sides, and the setbacks from the property lines to the neighboring building;
 - B. Elevations for all sides;
 - C. If the proposal is for a remodel, a clear delineation of what part of the proposed structure is new construction
 - D. If the proposal is for a building with more than one story, show:
 - how the upper story sits on the story beneath it (setback of the upper story from the lower story);
 - the distance from the proposed upper story to comparable stories of the neighboring buildings; and
 - > the height of neighboring buildings compared to the proposed structure's height.
- Any surveys that indicate similarities in floor area or architectural style in the surrounding neighborhood
- Any communications such as letter and emails from adjacent neighbors, local neighborhood groups, and/or the Homeowners' Association

Meeting Presentation – *updated 8/31/20*

Due to COVID-19, the La Jolla Shores Planned District Advisory Group meetings will be conducted as online virtual meetings utilizing the Zoom application. Staff will provide all applicants, as well as the public instructions for logging in and participating in the meeting.

For the meeting, the applicant should provide a concise powerpoint presentation on their project or simply present the exhibits provided for the agenda distribution as their presentation. During the meeting, staff will allow the applicant to become the presenter, so that they may share their screen and run their presentation.

PLEASE DO NOT PROVIDE THE FOLLOWING:

- The complete plan set of the project. Complete plan sets take up a lot of memory to distribute and most of the information is not necessary for the Advisory Board's review.
- Plans or exhibits of the interior of the project. Interiors are not reviewed by the Advisory Board.
- Personal contact information of the property owners of the project should not be included, unless they
 are the "owner/applicant" and they are the designated point of contact

2 Form Updated: 1/22/2021

The Advisory Board members are very keen to know that the neighbors in the immediate vicinity have been noticed and their views noted. Community conformity, setbacks, FAR, parking, view corridors, bulk & scale, and articulation are key discussion points on all projects. Action Items will be heard first.

Thank you,

Please return the information requested to no later than a week before the scheduled meeting date:

Marlon I. Pangilinan, Senior Planner mpangilinan@sandiego.gov Planning Department 9485 Aero Drive MS 413 San Diego CA 92123 619-235-5293

3 Form Updated: 1/22/2021

7951 Paseo Del Osaco, La Jolla Baylor Residence Project Description:

The project consists of removing an existing two-story residence, garage, pool, site work, and shed and constructing a new two-story single-family residence with roof access and attached 2-car garage. Additional scope includes landscaping of the existing yard, construction of the new pool, spa, and perimeter fence. It should be noted that the existing residence is uninhabitable at this time.

The LJCP&LCP emphasizes avoiding extreme and intrusive changes to the residential scale of La Jolla's neighborhoods and promoting good design and harmony within the visual relationships and transitions between new and older structures. The placement of the proposed development fits into the established diverse theme within the vicinity. The LJCP&LCP does not designate this site as having visual access or is identified as a public access point. The project would not impact the public view of the Pacific Ocean, as the project is observing all required setbacks, and the proposed project is contained within the existing lot area. Therefore, the project will not impede upon any existing or proposed physical access way legally used by the public identified in the Community Plan and LCP Land Use Plan.

The height of the residence is less than 30 feet, in keeping with the community's existing character, is consistent with the goals of the Community Plan and LCP, and contributes to preserving and improving the physical appearance and visual harmony of the La Jolla community. Furthermore, the Residential Land Use section also recommends promoting the development of various housing types and styles in La Jolla. The project's contemporary design will diversify the architectural styles in the neighborhood while still conforming to the bulk and scale of adjacent properties.

7951 Paseo Del Ocaso, La Jolla Baylor Residence Project Description:

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ABBREVIATIONS

DEPT DET

DIA DIM DR

DW DWG

ENGR EQ EQPT

EXPN EXT

FIXT FLR FOF FOC FP

FTG

GALV GEN GL GWB GYP

HDWD

HOR HR HT

INSUL INT

JAN

LAV LOC LTG LTWT LVL

DEPARTMENT

DOUGLAS FIR

DIAMETER

DIMENSION

DOWNSPOUT

EAST EXISTING EACH

ENGINEER

EQUIPMENT

EXTERIOR

EXPANSION

FLOOR DRAIN

FOUNDATION

FINISH FLOOR

FIREPLACE FOOT, FEET FOOTING

GALVANIZED

GYPSUM

HOLLOW CORE HARDWOOD

HOLLOW METAL HORIZONTAL HOUR HEIGHT

INSIDE DIAMETER
INSULATED GLASS UNIT

INSULATION, INSULATED INTERIOR

HOT WATER

LAVORATORY

LIGHTWEIGHT

LOCATION LIGHTING

LEVEL

INCH

GENERAL GLASS GYPSUM WALL BOARD

FINISH (ED)
FIXTURE
FLOOR
FACE OF FINISH
FACE OF CONCRETE

FIRE EXTINGUISHER CABINET

EQUAL

EL, ELEV ELEVATION
ELEC ELECTRICAL

DISHWASHER DRAWING

DECOMPOSED GRANITE

AND MASONRY MATL MAX MATERIAL MAXIMUM NUMBER MED CAB MEDICINE CABINET MECH MECHANICAL
MEMB MEMBRANE
MFR MANUFACTURE AIR CONDITIONING ACOUSTIC CEILING TILE MANUFACTURER ADJ AFF ALT MIN MIR MISC ADJUSTABLE MINIMUM ABOVE FINISH FLOOR MIRROR ALTERNATE MISCELLANEOUS ALUM ALUMINUM
ANOD ANODIZED
APPROX APPROXIMATE MTD MTL MOUNTED METAL NEW NORTH ARCH ARCHITECTURAL N NAT NIC NOM AVG AXON AVERAGE NATURAL AXONOMETRIC NOT IN CONTRACT NOMINAL BOARD NTS NOT TO SCALE BUILDING BLKG B.O. BP **BLOCKING** OC OD OPHD OPER OPNG OPP OVHD ON CENTER **BOTTOM OF OUTSIDE DIAMETER** BUILDING PAPER OPPOSITE HAND BSMT BUR BYD BASEMENT OPERABLE **BUILT-UP ROOFING** BEYOND **OPPOSITE** OVERHEAD CABINET CAB
CEM
CER
CHAN
CIP
CL
CLR
CLG
CLOS
CMU
COL
CONC CEMENT PERFORATED CERAMIC PLATE OR PROPERTY LINE CHANNEL PLASTIC LAMINATE CAST-IN-PLACE PLAS PLASTER PLYWD PLYWOOD CENTERLINE CLEAR CEILING CLOSET
CONCRETE MASONRY UNIT PROPERTY PT PTD POINT PAINTED COLUMN CONCRETE CONTINUOUS RISER CONT COORD CORR CPT CS CT RESILIENT BASE CORRIDOR, CORRUGATED REFERENCE COORDINATE REFLECTING CARPET COUNTER SUNK REFR REFRIGERATOR REINF REQD RETG REINFORCED CERAMIC TILE REQUIRED

RETAINING

ROOM

RM RO RWL

STL

TFWD
T&G
TEMP
T.O.
TOC
TOW
TV
TYP

UBC UC UNF UON UTIL

VAR VCT VERT VEST VIF VNR

W/ WC WD

WDW WH W/O WO WP

REVISION/REVISED RADIANT HEAT MANIFOLD

ROUGH OPENING

SOLID CORE

SLAB ON GRADE

SPEAKER SPECIFICATION

STAINLESS STEEL

TO BE DETERMINED
TELEPHONE
TRANSPARENT FINISH

TONGUE & GROOVE

TOP OF TOP OF CONCRETE TOP OF WALL TELEVISION

UNIFORM BUILDING CODE UNDER COUNTER

UNLESS OTHERWISE NOTED UTILITY

VARIES
VINYL COMPOSITION TILE
VERTICAL

VESTIBULE VERIFY IN FIELD

WATER CLOSET

WASHER/DRYER

WHERE OCCURS WATERPROOF

VENEER

WEST

WITH

WOOD

WINDOW WATER HEATER

WITHOUT

TYPICAL

TRANSPARENT FINISH WOOD

SPRINKLER

STANDARD

STEEL

STOR STORAGE STRUC STRUCTURAL SUSP SUSPENDED SYM SYMMETRICAL

RAIN WATER LEADER

SELF-ADHERED FLASHING

SECTION SEE ELECTRICAL DRAWING

SLIDING SEE LANDSCAPE DRAWING

SEE PLUMBING DRAWING

SEE MECHANICAL DRAWING

SEE STRUCTURAL DRAWING

SITE LOCATION MAP (NOT TO SCALE)

Address: 7951 Paseo Del Ocaso La Jolla, CA 92037

PROJECT DATA

Zoning: LJSPD-SF (La Jolla Shores Planned District) Height & Bulk: 30' max height Type of Construction: V-B (non-rated) Scope of Work: New 2 story building Existing Occupancy: R-3
Existing Use: Single Family Dwelling Proposed Occupancy: R-3
Proposed Use: Single Family Dwelling

PROJECT DESCRIPTION:

THE REMOVAL OF AN EXISTING TWO STORY RESIDENCE, GARAGE, POOL, SITEWORK AND SHED.

CONSTRUCTION OF A NEW TWO STORY SINGLE FAMILY RESIDENCE WITH ROOF ACCESS, AND ATTACHED 2-CAR GARAGE. LANDSCAPING OF EXISTING YARD, CONSTRUCTION OF NEW POOL, SPA AND PERIMETER FENCE.

LOT SIZE: 7,489 SF (0.172 ACRES)

PROPOSED FAR: 4,178 TOTAL SF (incl. Garage) / 7,489 SF LOT = 0.56 FAR

LEGAL DESCRIPTION:

LOT 5 IN BLOCK 4 OF LA JOLLA SHORES UNIT NO. 1, IN THE CITY OF SAN DIEGO, COUNTY OF SAN DIEGO, STATE OF CALIFORNIA, ACCORDING TO MAP THEREOF NO. 1913, FILED IN THE OFFICE OF THE COUNTY RECORDER OF SAN DIEGO COUNTY, JUNE 3, 1926.

APN: 346-512-07-00

DIRECTORY SHEET INDEX

Owner:
David Baylor and Terry Helmer
10 Sylvan Lane Ross, CA 94957

Architect: Aidlin Darling Design Contact: Chris DeHenzel 500 Third Street, Suite 410 San Francisco, CA 94107 T 415-974-5603 Email: cdh@aidlin-darling-design.com

Surveyor/Civil Engineer: Coffey Engineering, Inc. Contact: Michael Rein 9666 Businesspark Avenue, Suite 210 San Diego, CA 92131-1646 T (858)831-0111 Ext. 208

Email: rein@coffeyengineering.com

Geotechnical Engineer: GEi (Geotechnical Exploration, Inc.) Contact: Adam Hespeler 7420 Trade Street San Diego, CA 92121 (858) 549-7222 Èmail: ahespeler@gei-sd.com

Landscape Architect: Leslie Ryan / Aerea Studio T: (619) 200-8297 Email: leslie@aerea-studio.com

Permit Consultant: Chandra Slaven T: 619-316-7645 chandraslaven@gmail.com

- L1.0 Planting Plan and Legend L1.1 Planting Notes L2.0 Hardscape Plan and Finish Legend

LANDSCAPE

L2.1 Hardscape Details L3.0 Irrigation Notes and Hydrozones

SURVEY

<u>TITLE</u>

C.0 Site Survey C.01 Topographic Survey 300' Boundary C.02 Topographic Survey Setback Analysis

C.1 Grading and Drainage Plan

A0.1 Project Information

A0.2 Finish Legend

ARCHITECTURAL

A1.0 Demo Plan

A2.0 Site Plan A2.1 Ground Floor Plan A2.2 Second Floor Plan A2.3 Mid Roof Plan

A2.4 High Roof Plan A5.1 Building Elevations A5.2 Building Elevations

A5.3 Building Sections

A5.4 Building Sections

A5.5 Building Sections A5.6 Building Sections

A6.1 Wall Sections

aidlin darling **design**

500 third street suite 410 san francisco, ca 94107 415 974 0849 **fax**

415 974 5603 phone

BAYLOR RESIDENCE

7951 PASEO DEL OCASO LA JOLLA, CA

1909


DATE: 01.14.22

DRAWN: CDH

JOB:

SCALE: AS NOTED DATE ISSUE COASTAL DEV PERMIT 05.07.2021

COASTAL DEV PERMIT	01.14.2022

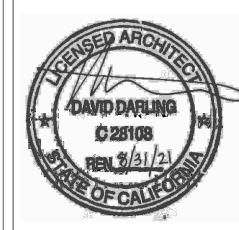

A0.1 **PROJECT**

INFORMATION

FLOOR AREAS

	Proposed Floor Are	Proposed Floor Area (SQFT)				
	Conditioned Un-Conditioned					
1st Floor 1,550 House		675 Garage/Mech/Storage				
2nd Floor	1,953 House					
Totals	3,503	675				

EXTERIOR RENDERED VIEW FROM PASEO DEL OCASO



SYMBOLS ARCHITECTURAL FINISH LEGEND 000 Window tag FINISH **MATERIAL** MARK CONC-1 BOARD FORMED CAST IN PLACE CONCRETE WALLS aidlin darling **design** CONC-2 CONCRETE FLOORS INTERIOR EXPOSED STRUCTURAL CONCRETE SLAB CONC-3 500 third street CONCRETE SLAB EXTERIOR EXPOSED STRUCTURAL CONCRETE SLAB suite 410 Elev # / Sheet # CONC-4 CONCRETE SLAB NOT USED san francisco, ca 94107 CONC-5 CONCRETE PAVERS AND STEPS CAST IN PLACE EXTERIOR CONCRETE 415 974 0849 **fax** 415 974 5603 phone CPL-1 EXTERIOR CEMENT PLASTER SMOOTH TROWELED; INTEGRAL COLOR INSULATED GLAZING; LOW-E COATING; TEMPERED WHERE REQUIRED GL-1 EXTERIOR CLEAR GLASS Section # / Sheet # MTL-1 STANDING SEAM ZINC VM ZINC SINGLE LOCK STANDING SEAM PANELS, 1" SEAM HEIGHT, "PIGMENTO BROWN" FINISH MTL-2 AESS PAINTED STEEL ARCHITECTURAL EXPOSED STRUCTURAL STEEL, AESS 3 UON; GALVANIZE AND PRIME AT EXTERIOR MTL-3 PAINTED ORNAMENTAL STEEL HOT ROLLED, GRADES SUITABLE FOR STUCTURAL LOADING; GALVANIZE AND PRIME AT EXTERIOR LOCATIONS MTL-4 PAINTED SHEET METAL COLD ROLLED GALVANIZED METAL FLASHING, PAINTED MTL-5 COR-TEN PLATE LANDSCAPE RETAINING EDGING; SLD **BAYLOR** Ceiling mounted smoke detector **RESIDENCE** WD-1 EXTERIOR WOOD GARAGE DOOR CLADDING NUSKU TERRATEK THERMALLY MODIFED CEDAR; 3/4" X 5" CONT HORIZONTAL BOARDS; CONCEALED FASTENERS Fire sprinkler WD-2 EXTERIOR WALL AND CEILING CLADDING WESTERN RED CEDAR 3/4" X 3" T&G BOARD; VERT GRAIN, S4S W/ TRANSPARENT SEALER WD-3 EXTERIOR DECKING NUSKU THERMACOR THERMALLY MODIFIED LUMBER; 6" W BOARDS TYP WD-4 EXTERIOR WOOD CLADDING WESTERN RED CEDAR 3/4" X 3" T&G VERT BOARDS; STAINED FINISH; CONCEALED FASTENERS WOOD FENCES AND GATES NUSKU THERMACOR THERMALLY MODIFIED LUMBER; 3" W BOARDS TYP 7951 PASEO DEL OCASO LA JOLLA, CA GENERAL MATERIAL FINISH NOTES 1. PRODUCTS TO COMPLY WITH EMISSIONS LIMIT REQUIREMENTS OF CAL GREEN 4.504.2.1-5, 5.504.4.1-6 FOR ADHESIVES, SEALANTS, PAINTS, COATINGS, CARPET SYSTEMS INCLUDING CUSHIONS AND ADHESIVES, RESILIENT FLOORING (80% OF AREA), AND COMPOSITE WOOD PRODUCTS **DATE:** 01.14.22 JOB: 2. WALL AND FLOOR WOOD FRAMING MUST HAVE <19% MOISTURE CONTENT BEFORE ENCLOSURE Thermostat DRAWN: MP Wall washer **SCALE**: AS NOTED Surface mounted fixture DATE Recessed Downlight, halo or COASTAL DEV PERMIT 05.07.2021 Pendant fixture COASTAL DEV PERMIT 01.14.2022 -──⊣ Wall mounted fixture — ○ — Cove light ⊢ Under counter light Flourescent lighting Ceiling junction box J⊢ Wall mounted junction box Wall mounted telephone/CAT-5/video Wall mounted telephone Cable television jack Wall mounted duplex Switched outlet Dedicated duplex outlet GFI-protected duplex outlet Exterior waterproof outlet Quadplex outlet Floor outlet □**ഗ**— Lightswitch □ Dimmer 3-way Lightswitch (Elevation) FINISH LEGEND

ORIGINAL 2/27/19 REVISION 1 REVISION 2

REVISION 3 REVISION 4

REVISION 5

TOPOGRAPHIC SURVEY PLAN

SCALE: 1" = 10'

<u>WARNING</u> 0 1/2 IF THIS BAR DOES NOT MEASURE 1" THEN DRAWING IS NOT TO SCALE. SCALE ACCORDINGLY

NOTES

ABBREVIATIONS

ICV PLTR PVMT

IRRIGATION CONTROL VALVE PLANTER PAVEMENT

STREET LIGHT TOP OF WALL ELEVATION

SEWER CLEANOUT

TYPICAL

WATER METER

LEGEND

<u>STD DWG</u>

<u>SYMBOL</u>

<u>N45°45'45"W</u>

- 1. THIS TOPOGRAPHIC SURVEY WAS PERFORMED FOR THE PURPOSES OF A SPECIFIC PROJECT, AND SOME AREAS MAY HAVE GREATER OR LESSER DETAIL BASED ON PROJECT REQUIREMENTS. CHANGES TO THE SCOPE, DESIGNER, OR LOCATION OF WORK MAY REQUIRE THAT ADDITIONAL SURVEYING BE PERFORMED TO SATISFY THE NEW REQUIREMENTS.
- 2. THIS IS A TOPOGRAPHIC SURVEY, NOT A BOUNDARY SURVEY OR RECORD OF SURVEY. THE PROPERTY LINES DEPICTED ON THIS PLAN ARE GENERATED FROM EXISTING PUBLIC RECORD MAPS, DRAWINGS. OR DESCRIPTIONS. THE PROPERTY LINES AND/OR EASEMENTS SHOWN HEREON HAVE BEEN INCLUDED TO REPRESENT THEIR APPROXIMATE LOCATIONS RELATIVE TO THE TOPOGRAPHIC
- 3. THE LOCATIONS OF UTILITIES, IF ANY, SHOWN ON THIS PLAN ARE GENERATED FROM RECORDS PROVIDED BY UTILITY/GOVERNING AGENCIES AND/OR FIELD DATA COLLECTED DURING THE SURVEY. THE PLOTTING OF UTILITIES ON THIS PLAN DOES NOT CONSTITUTE A GUARANTEE OF THEIR LOCATION, DEPTH, SIZE, OR TYPE.

LEGAL DESCRIPTION

LOT 5 IN BLOCK 4 OF LA JOLLA SHORES UNIT NO. 1, IN THE CITY OF SAN DIEGO, COUNTY OF SAN DIEGO, STATE OF CALIFORNIA, ACCORDING TO MAP THEREOF NO. 1913, FILED IN THE OFFICE OF THE COUNTY RECORDER OF SAN DIEGO COUNTY, JUNE 3, 1926.

APN: 346-512-07-00

<u>DESCRIPTION</u>

STREET CENTERLINE

EASEMENT LINE INDEX CONTOUR

SPOT ELEVATION

BUILDING FOOTPRINT

CHAIN LINK / WIRE FENCE

FREE STANDING WALL

OVERHEAD UTILITIES

RETAINING WALL

POWER POLE WATER SERVICE

SEWER LATERAL

BRUSHLINE

C; CONC

CC&R ELEV E: FL

TREE; PLANT; PALM

ASPHALTIC CONCRETE ASBESTOS CEMENT

CENTER LINE

CONCRETE

ELEVATION FLOW LINE GAS METER

BRICK GRADE AT BOTTOM OF WALL

CONDITIONS, COVENANTS & RESTRICTIONS

PCC CURB

BRICKS

PCC PAVING WOOD FENCE

PROPERTY LINE (RECORD)

PROPERTY LINE - OFFSITE

BENCHMARK


SEBP AT THE INTERSECTION OF PASEO DEL OCASO AND CALLE DE LA PLATA


ELEV = 35.851 MSL, NGVD 29, CITY OF SAN DIEGO VERTICAL CONTROL BENCHBOOK, 2011

т <u>1</u> оғ <u>1</u> sнт

THIS SURVEY WAS PREPARED WITH THE BENEFIT OF A PRELIMINARY TITLE REPORT FROM CHICAGO TITLE COMPANY, TITLE NO. 73718010234-PM, DATED NOVEMBER 15, 2018. SAID REPORT INDICATES AN EASEMENT PRESENT AFFECTING THE SUBJECT PROPERTY AS DESCRIBED IN THE CC&Rs CLAUSE 19 AND SHOWN ON THIS PLAN.

EASEMENTS

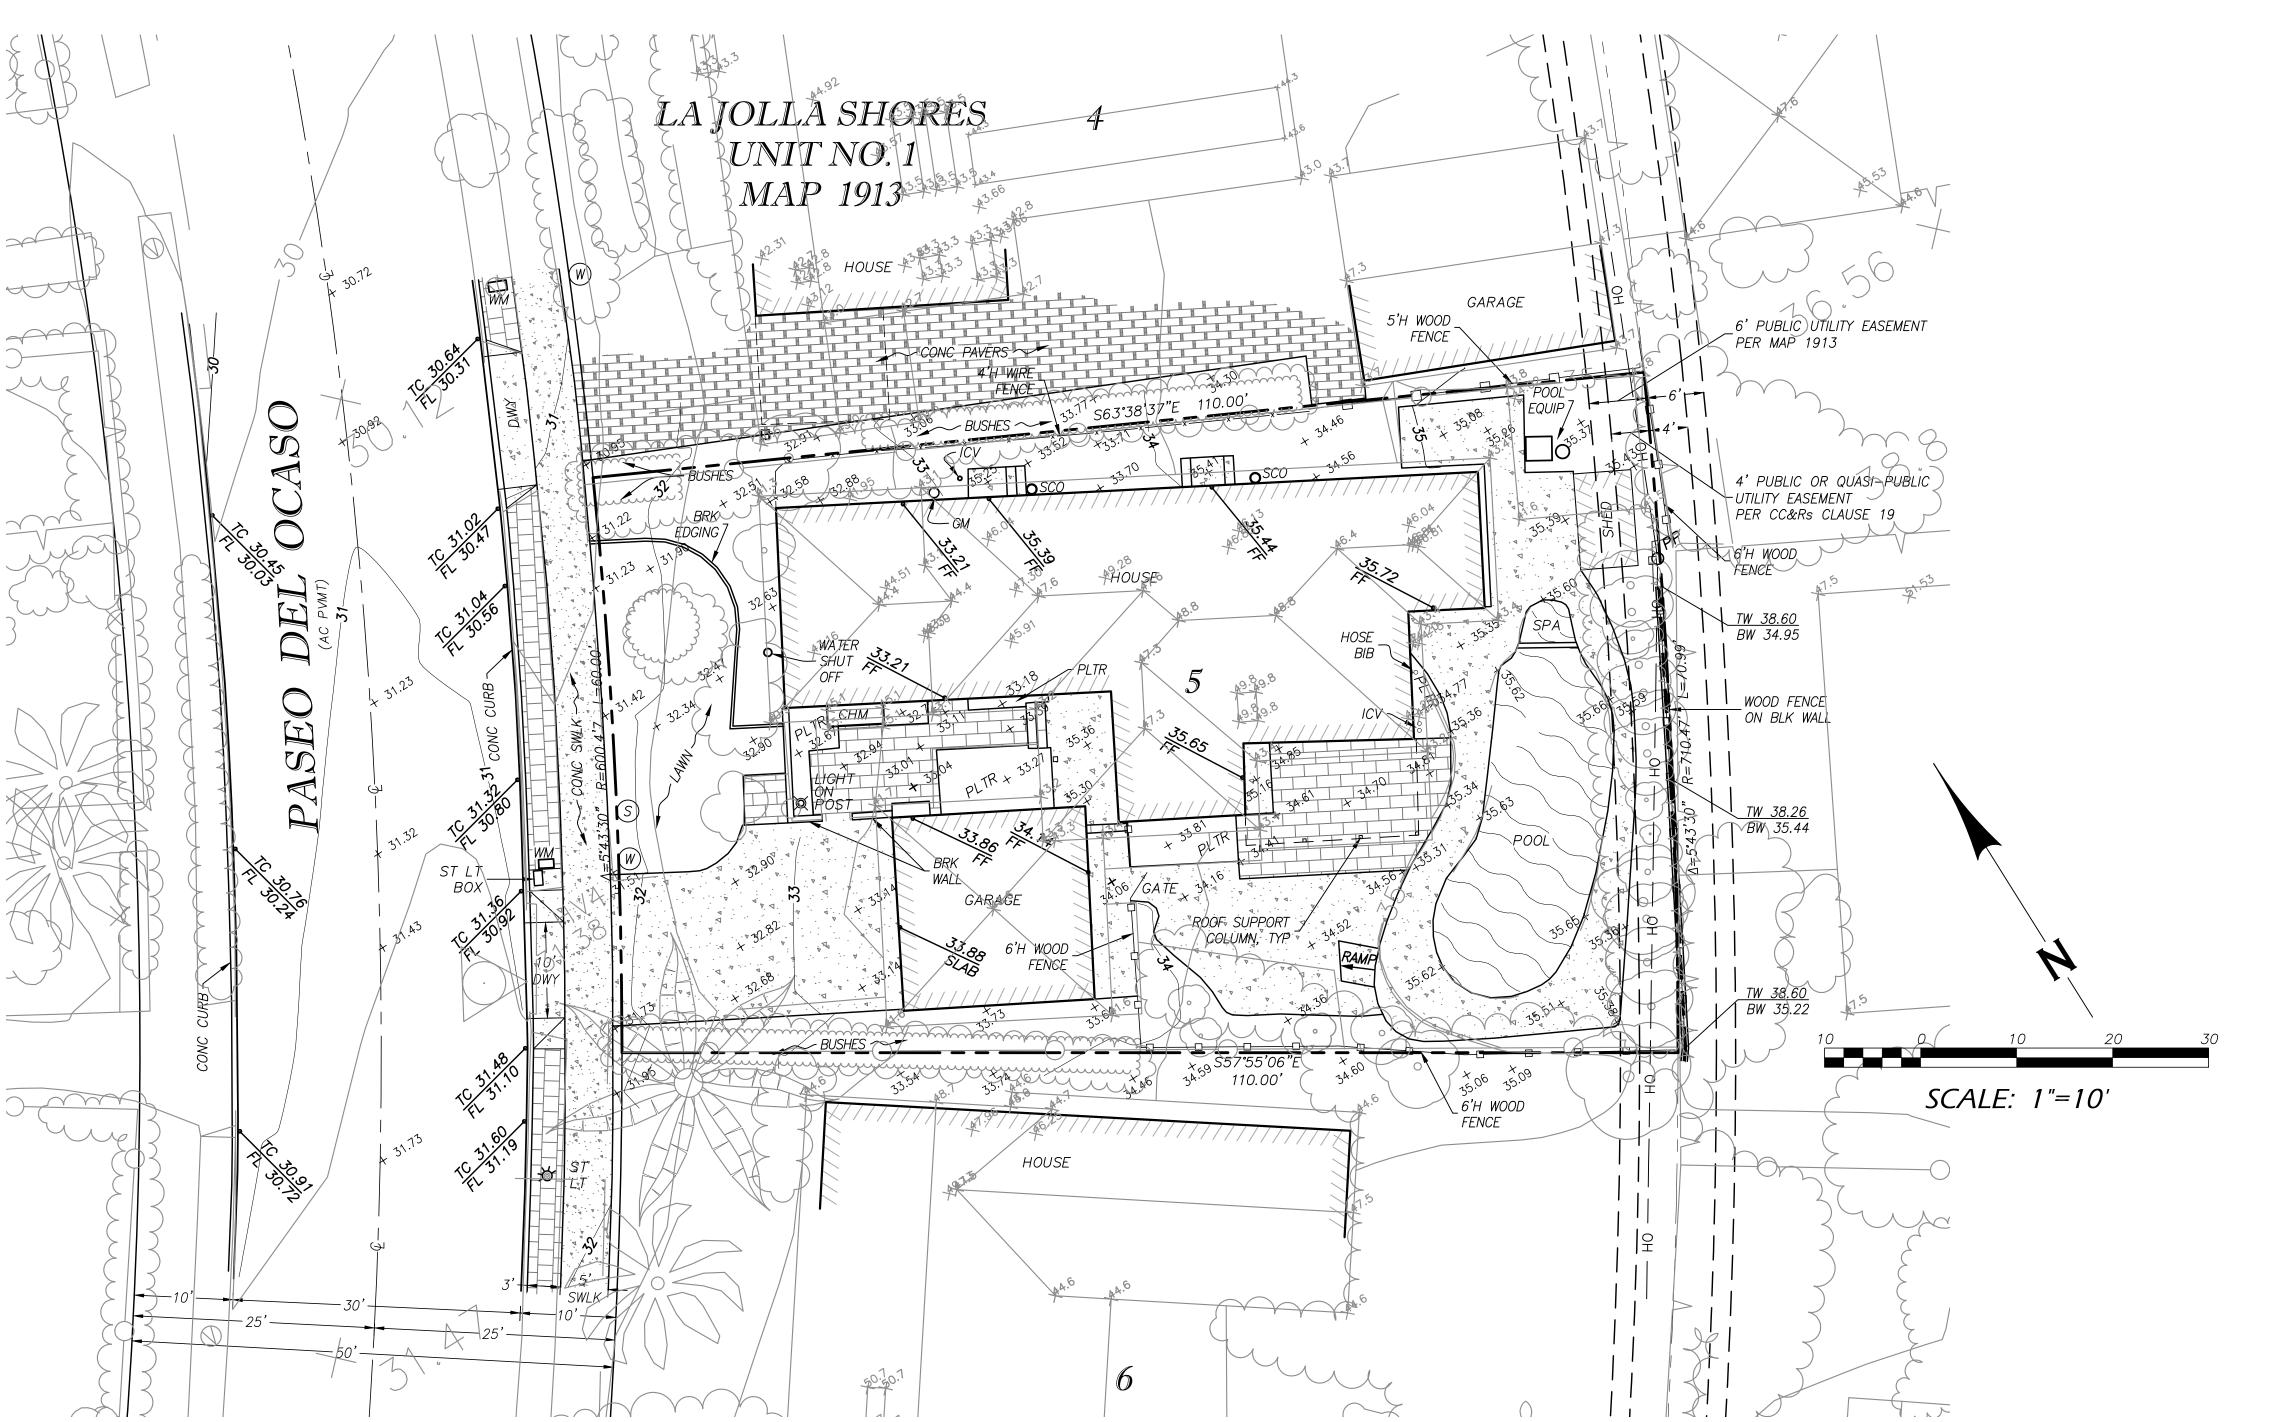


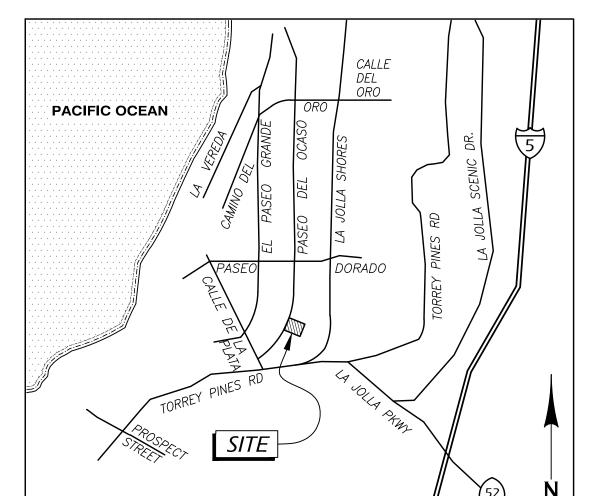

VICINITY MAP

THOMAS BROS. MAP 1227-H4 NO SCALE



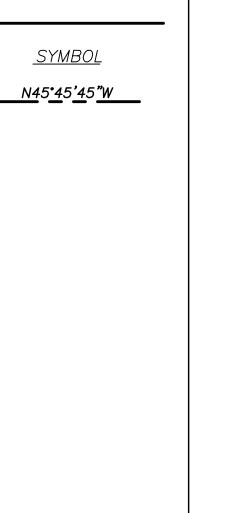

Lot Area

0.15

0.14

0.15

0.15

0.15

0.22

0.12

0.13

0.12

0.15

0.12

0.12

0.12

0.12

0.11

0.14

0.17

0.17

0.18

0.18

0.17

0.17

0.17

0.17

0.17

0.17

0.17

0.17

0.16

0.17

0.17

0.17

0.17

0.17

0.18

6,480

6,240

6,321

6,335

6,643

9,639

5,232

5,493

5,395

5,322

5,264

5,047

5,098

5,303

4,984

5,900

7,307

7,419

7,697

7,646

7,303

7,399

7,246

7,293

7,605

7,246

7,201

7,449

6,960

7,200

7,204

7,238

7,505

7,585

7,745

FAR Ratio

0.426

0.279

0.272

0.364

0.554

0.327

0.512

0.354

0.343

0.457

0.326

0.302

0.452

0.582

0.341

0.521

0.327

0.320

0.311

0.250

0.403

0.332

0.229

0.309

0.303

0.347

0.399

0.403

0.197

0.255

0.427

0.354

0.217

0.219

0.277

LEGEND

Assumed Garage | Total Floor Area (SF) | Lot Area (SF)

400

200

400

400

400

400

400

400

400

400

200

400

400

400

400

400

400

400

200

400

400

200

400

400

400

400

400

400

200

400

400

400

400

200

2,762

1,738

1,717

2,308

3,683

3,151

2,677

1,947

1,851

2,432

1,714

1,522

2,305

3,088

1,698

3,076

2,080

2,386

2,371

2,392

1,915

2,942

2,458

1,656

2,256

2,301

2,512

2,870

3,001

1,369

1,837

3,073

2,561

1,631

1,660

2,143

<u>STD DWG</u>

<u>DESCRIPTION</u>

PROPERTY LINE (RECORD)

SCALE: 1"=40'

300' Radius Parcel Information (La Jolla, CA 92037)

2,362

1,538

1,317

1,908

3,283

2,751

2,277

1,547

1,451

2,032

1,714

1,322

1,905

2,688

1,298

2,676

1,680

1,986

1,971

2,192

1,515

2,542

2,258

1,256

1,856

1,901

2,112

2,470

2,601

1,169

1,437

2,673

2,161

1,631

1,260

1,943

Living Area (SF)

Lot No.

|14

13

11

10

24

19

18

|16

Assessor's Parcel No.

346-503-06-00

346-503-05-00

346-503-04-00

346-503-03-00

346-503-02-00

346-503-01-00

346-503-07-00

346-503-08-00

346-503-09-00

346-503-10-00

346-503-11-00

346-503-12-00

346-503-13-00

346-503-14-00

346-503-15-00

346-503-16-00

346-512-11-00

346-512-10-00

346-512-09-00

346-512-08-00

346-512-06-00

346-512-05-00

346-512-04-00

346-512-03-00

346-512-02-00

346-512-12-00

DRAWN BY: EM / MR CHECKED BY: JC

Del 920


ORIGINAL 3/11/20 REVISION 1 REVISION 2

REVISION 3 REVISION 4 REVISION 5

TOPOGRAPHIC SURVEY 300' BOUNDARY

SCALE: 1" = 40'

____1__ OF ___1__SHTS

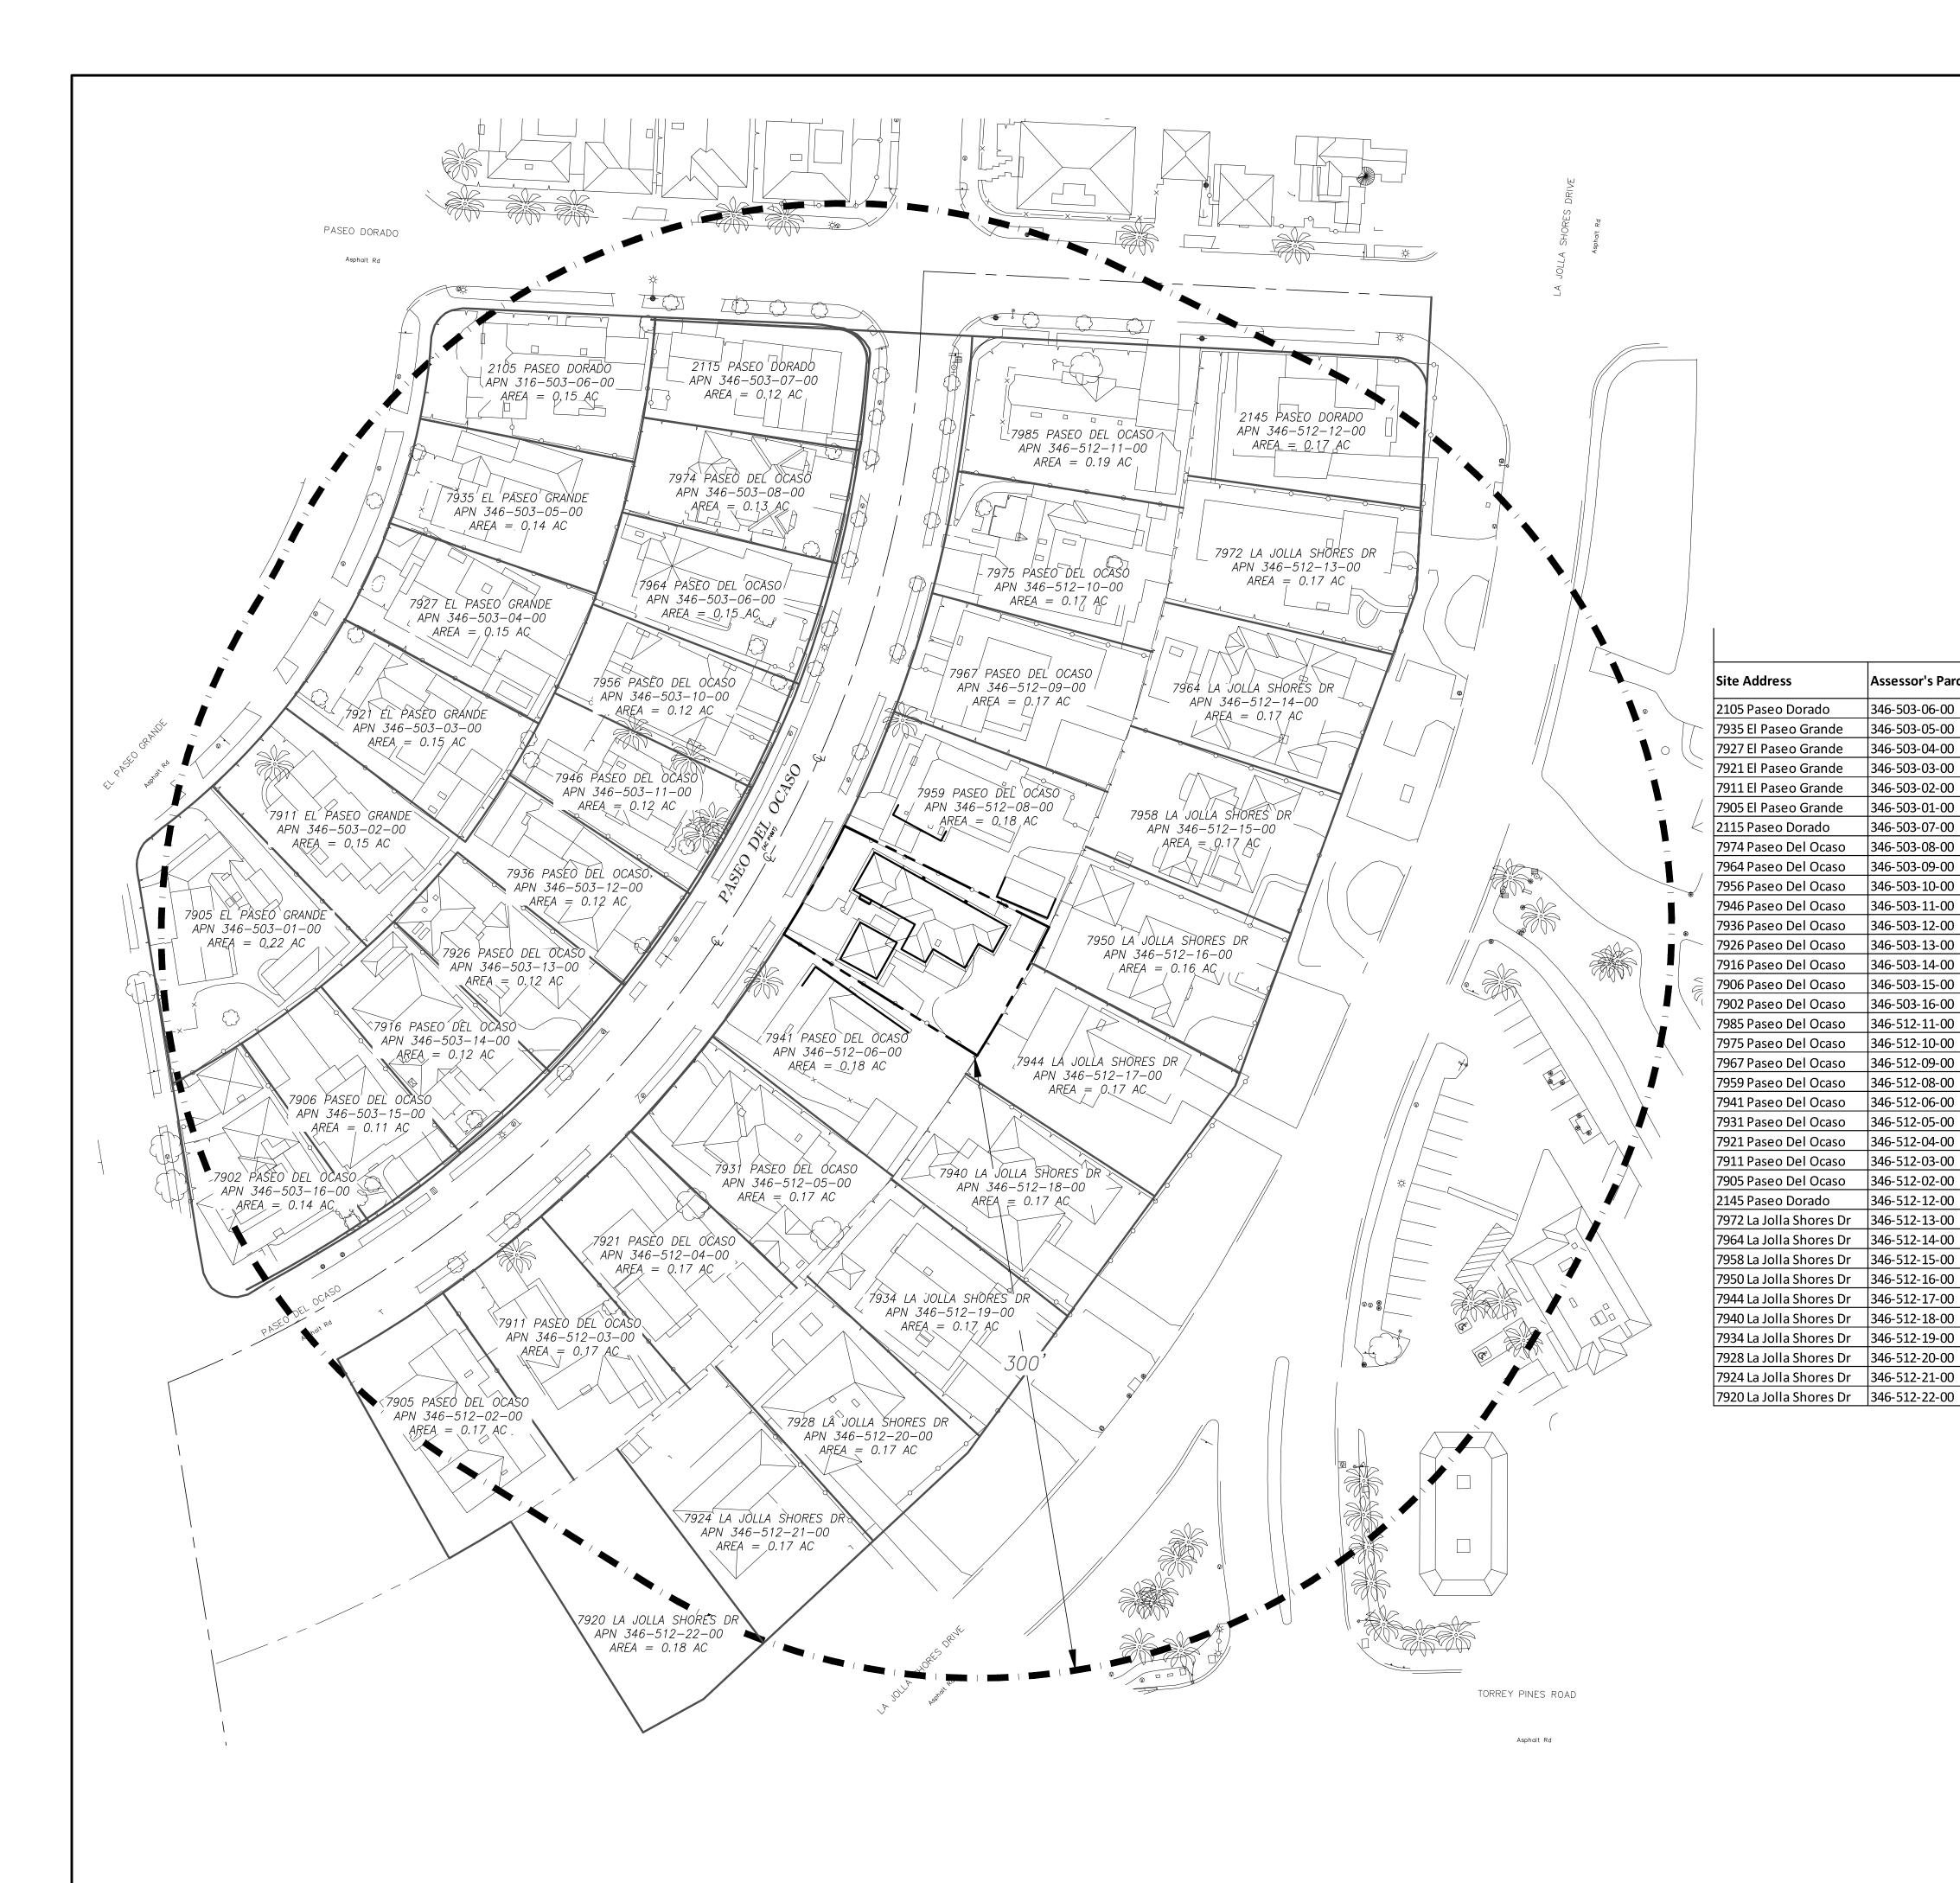



DRAWN BY: EM / MR CHECKED BY: JC

ORIGINAL 3/11/20 REVISION 1


REVISION 2 REVISION 3


REVISION 4 REVISION 5

TOPOGRAPHIC SURVEY Setback Analysis

SCALE: 1" = 40'

SHT <u>1</u> OF <u>1</u> SHTS

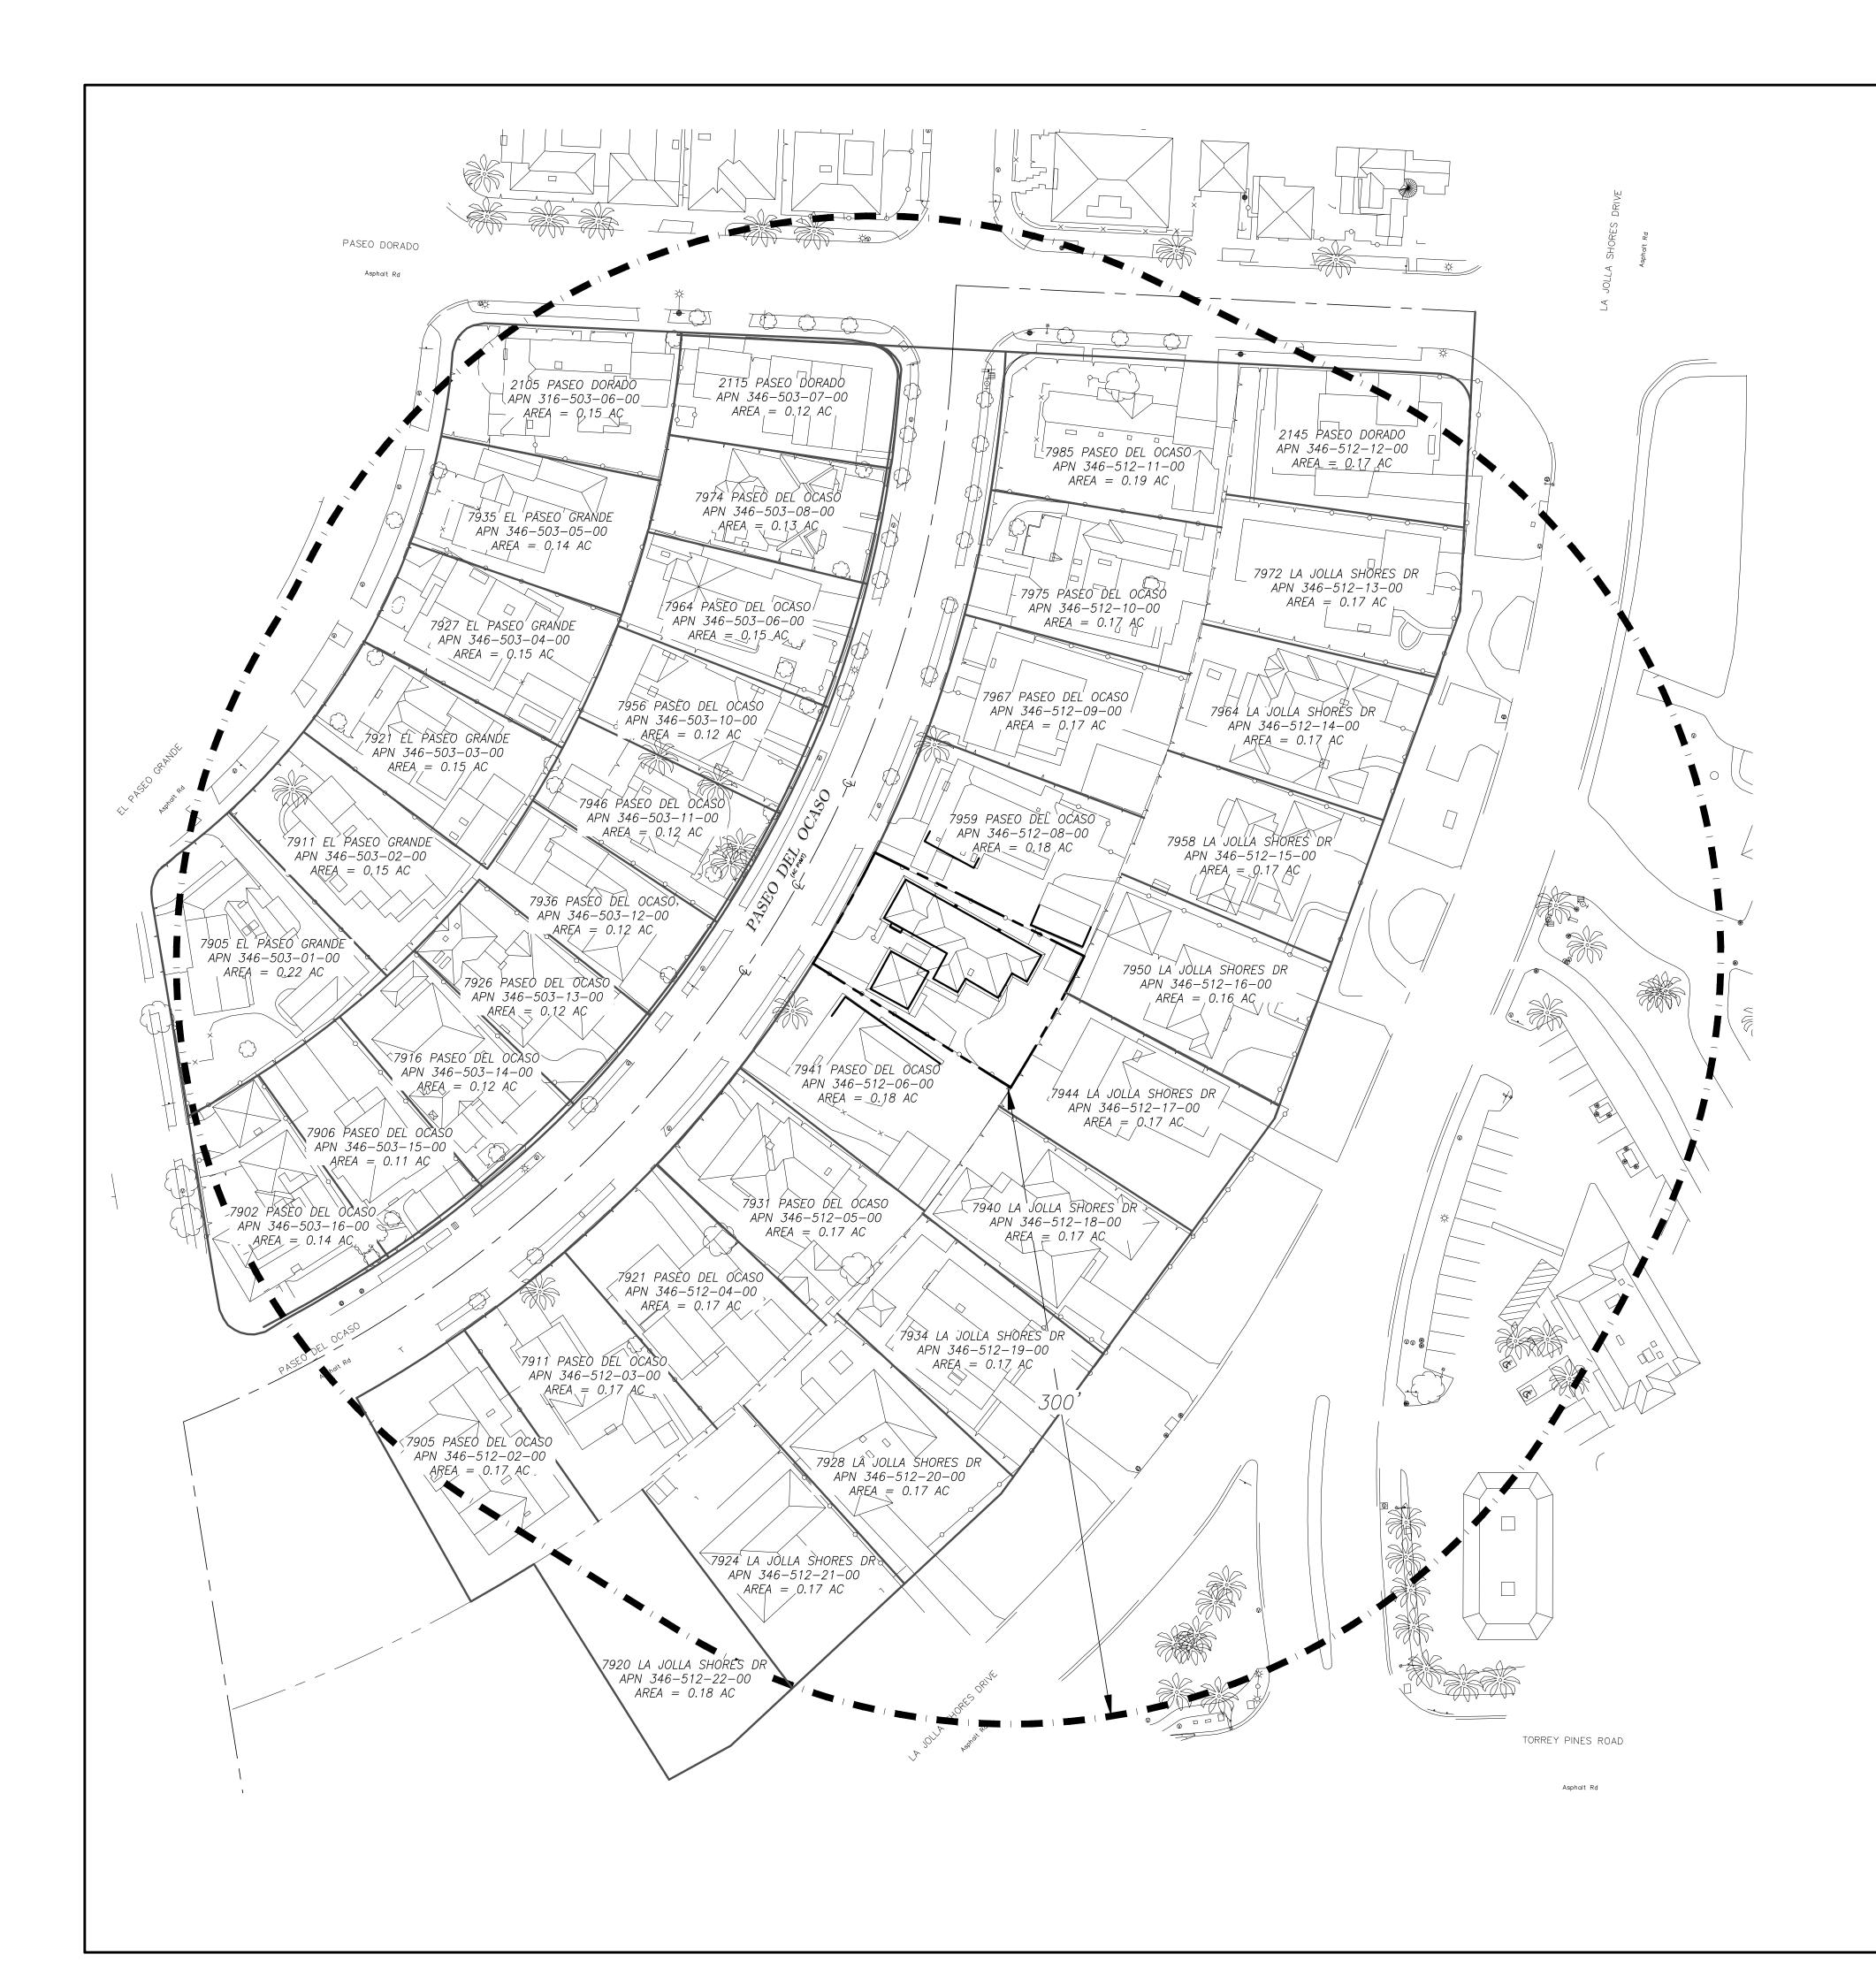

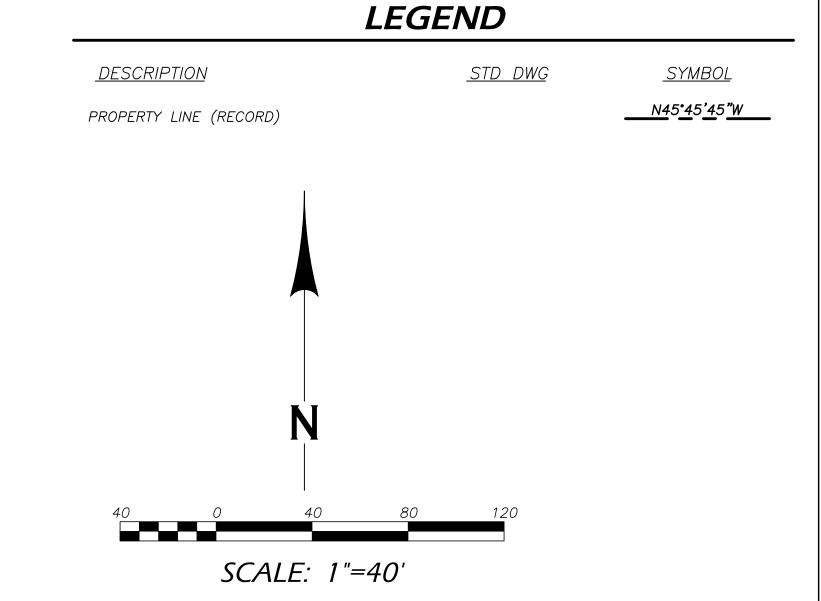


Site Address	Assessor's Parcel No 🗲	Front Yard 🔹	Sideyard 1 🕝	Sideyard 2 🕝	Rear Yard 🝷
2105 Paseo Dorado	346-503-06-00	20'	6' (North)	6' (South)	3'
7935 El Paseo Grande	346-503-05-00	16'	2' (North)	6' (South)	24'
7927 El Paseo Grande	346-503-04-00	17'	1' (North)	1' (South)	6'
7921 El Paseo Grande	346-503-03-00	25.2'	1' (North)	1' (South)	4'
7911 El Paseo Grande	346-503-02-00	23.1'	1' (North)	9' (South)	8'
7905 El Paseo Grande	346-503-01-00	20'	4' (North)	11.5' (South)	5'
2115 Paseo Dorado	346-503-07-00	10.6'	5' (South)	6' (North)	7'
7974 Paseo Del Ocaso	346-503-08-00	20.5'	7' (South)	3' (North)	26'
7964 Paseo Del Ocaso	346-503-09-00	21.3'	11' (South)	2' (North)	3'
7956 Paseo Del Ocaso	346-503-10-00	21.6'	6.5' (South)	2' (North)	17'
7946 Paseo Del Ocaso	346-503-11-00	18.3'	1' (South)	8.5' (North)	8'
7936 Paseo Del Ocaso	346-503-12-00	18.8'	9' (South)	1.5' (North)	1'
7926 Paseo Del Ocaso	346-503-13-00	17.4'	6' (South)	3' (North)	1'
7916 Paseo Del Ocaso	346-503-14-00	17.4'	9' (South)	3' (North)	3'
7906 Paseo Del Ocaso	346-503-15-00	16.2'	8.5' (South)	6' (North)	32'
7902 Paseo Del Ocaso	346-503-16-00	14.9'	4' (South)	13.1' (North)	1'
7985 Paseo Del Ocaso	346-512-11-00	20.9'	19' (North)	6' (South)	5'
7975 Paseo Del Ocaso	346-512-10-00	18.2'	5' (North)	5' (South)	20'
7967 Paseo Del Ocaso	346-512-09-00	19'	3' (North)	5' (South)	20
7959 Paseo Del Ocaso	346-512-08-00	18.5'	6' (North)	3' (South)	3'
7941 Paseo Del Ocaso	346-512-06-00	19'	3' (North)	3' (South)	3'
7931 Paseo Del Ocaso	346-512-05-00	19'	6' (North)	4' (South)	5'
7921 Paseo Del Ocaso	346-512-04-00	21.1'	6' (North)	7' (South)	4'
7911 Paseo Del Ocaso	346-512-03-00	24'	5' (North)	13' (South)	7'
7905 Paseo Del Ocaso	346-512-02-00	20.4'	5' (North)	9' (South)	17'
2145 Paseo Dorado	346-512-12-00	12'	4' (South)	1.5' (North)	19'
7972 La Jolla Shores Dr	346-512-13-00	12'	12' (South)	7' (North)	11'
7964 La Jolla Shores Dr	346-512-14-00	15'	5' (South)	5' (North)	25'
7958 La Jolla Shores Dr	346-512-15-00	18'	3' (South)	4' (North)	37'
7950 La Jolla Shores Dr	346-512-16-00	25'	3' (South)	7' (North)	6'
7944 La Jolla Shores Dr	346-512-17-00	23'	15' (South)	3' (North)	18'
7940 La Jolla Shores Dr	346-512-18-00	16'	3' (South)	3' (South)	4'
7934 La Jolla Shores Dr	346-512-19-00	30'	5' (South)	9' (North)	
7928 La Jolla Shores Dr	346-512-20-00	33'	4' (South)	8' (North)	
7924 La Jolla Shores Dr	346-512-21-00	31'	4' (South)	3' (North)	
	İ		•	· ·	i

30' 6' (South) 10' (North)

7920 La Jolla Shores Dr | 346-512-22-00

<u>SYMBOL</u>

<u>N45°45'45"W</u>

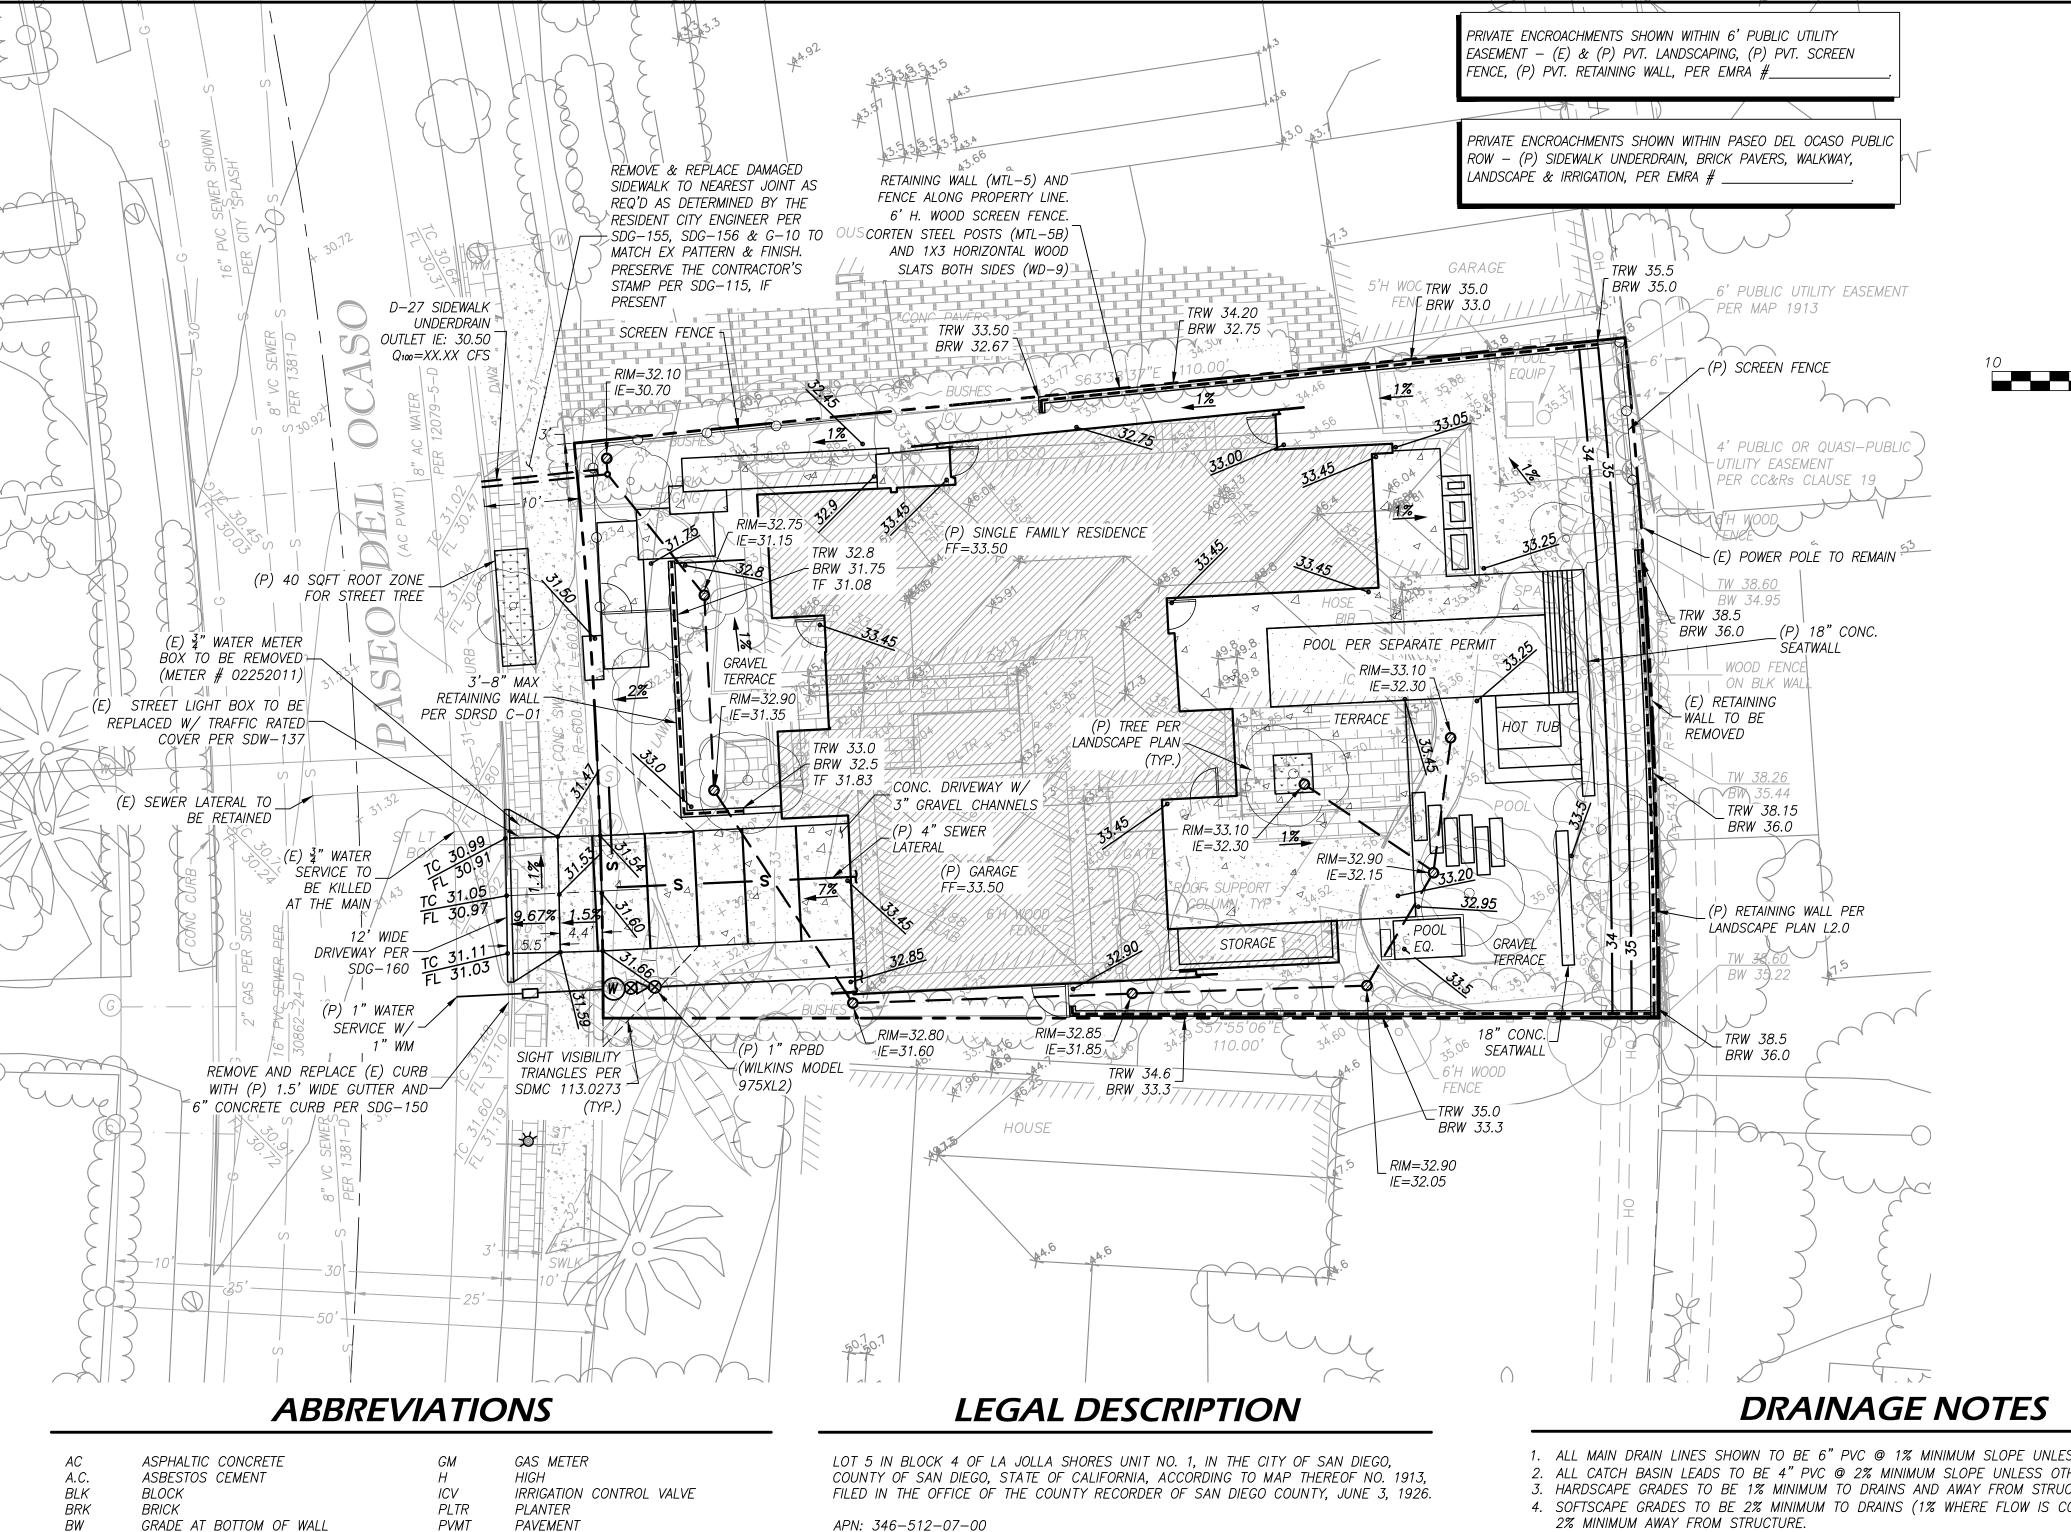

BENCHMARK

SEBP AT THE INTERSECTION OF PASEO DEL OCASO AND CALLE DE LA PLATA

ELEV = 35.851 MSL, NGVD 29, CITY OF SAN DIEGO VERTICAL CONTROL BENCHBOOK, 2011

EASEMENTS

THIS SURVEY WAS PREPARED WITH THE BENEFIT OF A PRELIMINARY TITLE REPORT FROM CHICAGO TITLE COMPANY, TITLE NO. 73718010234-PM, DATED NOVEMBER 15, 2018, AND ARE DESCRIBED AS SUCH:

- 1. 6' WIDE UTILITY EASEMENT ALONG EASTERLY (REAR) PROPERTY LINE TO CITY OF SAN DIEGO FOR ALL PIPES, POLES, OR OTHER STRUCTURES, OR WORK, TREES, AND ANYTHING OF WHATEVER NATURE THAT MAY BE IN, UPON, ACROSS, OR OVER THE EASEMENT.
- 2. SAID REPORT INDICATES A 4' WIDE QUASI-UTILITY EASEMENT PRESENT AFFECTING THE SUBJECT PROPERTY AS DESCRIBED IN THE CC&Rs CLAUSE 19 AND SHOWN ON

GRADING NOTES

- 1. ALL DRAINAGE FROM THE IMPROVEMENTS ON THE PREMISES SHALL BE DIRECTED TOWARD THE STREET.
- THIS PROJECT WILL NOT DISCHARGE ANY INCREASE IN STORM WATER RUN-OFF.

- 1. ALL MAIN DRAIN LINES SHOWN TO BE 6" PVC @ 1% MINIMUM SLOPE UNLESS OTHERWISE NOTED. 2. ALL CATCH BASIN LEADS TO BE 4" PVC @ 2% MINIMUM SLOPE UNLESS OTHERWISE NOTED.
- 3. HARDSCAPE GRADES TO BE 1% MINIMUM TO DRAINS AND AWAY FROM STRUCTURE. 4. SOFTSCAPE GRADES TO BE 2% MINIMUM TO DRAINS (1% WHERE FLOW IS CONCENTRATED) AND
- 5. SOIL COVER ABOVE DRAIN LINES SHALL BE 12" MINIMUM UNLESS OTHERWISE NOTED. 6. NOTIFY CIVIL ENGINEER IF ANY NON-DRAINING SUMP CONDITIONS BECOME APPARENT DURING

TRANSIT STOPS

1. THERE ARE NO TRANSIT STOPS LOCATED ADJACENT TO THE SUBJECT PROPERTY.

<u>STD DWG</u> PROPERTY LINE (RECORD) PROPERTY LINE - OFFSITE

LEGEND

EASEMENT LINE INDEX CONTOUR PCC CURB SPOT ELEVATION

BUILDING FOOTPRINT

DESCRIPTION

STREET CENTERLINE


BRICKS PCC PAVING WOOD FENCE CHAIN LINK / WIRE FENCE FREE STANDING WALL RETAINING WALL OVERHEAD UTILITIES POWER POLE

WATER SERVICE SEWER LATERAL TREE; PLANT; PALM

BRUSHLINE

FIRE HYDRANT

1. FIRE HYDRANTS DEPICTED ON VICINITY MAP BELOW ARE LOCATED WITHIN 600' OF THE SUBJECT

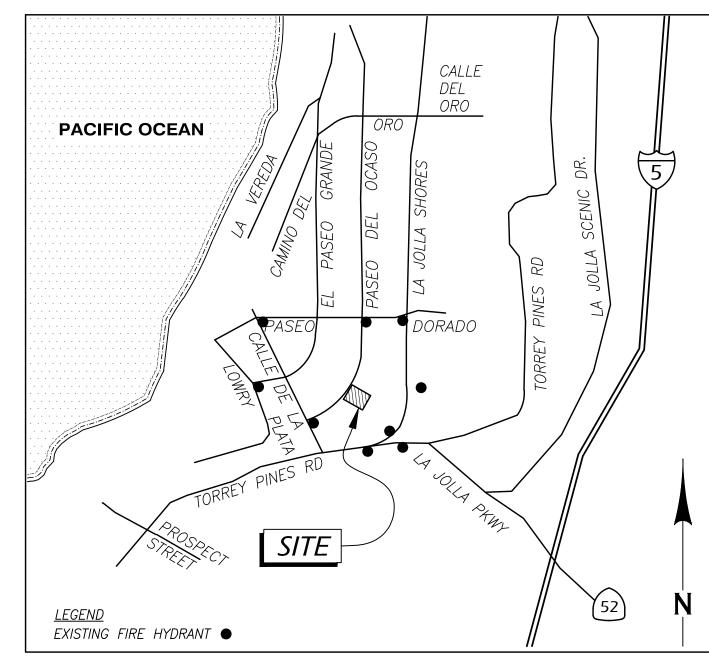

VICINITY MAP

THOMAS BROS. MAP 1227-H4 NO SCALE



1/7/2022

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CITY OF SAN DIEGO, CALIFORNIA COASTAL DEVELOPMENT PERMIT/SDP

BAYLOR RESIDENCE

7951 Paseo Del Ocaso La Jolla CA 92037

GC, MK SHEET 1 OF

GRADING TABULATIONS

TOTAL AMOUNT OF SITE TO BE GRADED: 7,200 S.F. AMOUNT OF CUT: 300 CUBIC YARDS ** AMOUNT OF FILL: 20 CUBIC YARDS

MAXIMUM HEIGHT OF FILL SLOPE(S): N/A CUBIC YARDS **MAXIMUM HEIGHT OF CUT SLOPE(S): 2

FEET AMOUNT OF IMPORT / EXPORT SOIL: 280 CUBIC YARDS RETAINING/ CRIB WALLS: LENGTH 110 FEET

SCALE: 1"=10"

MAXIMUM HEIGHT: 3'(2' RET.) FEET

% OF TOTAL SITE: 100% MAXIMUM DEPTH OF CUT: 2.5 FEET MAXIMUM DEPTH OF FILL: 1 FEET SLOPE RATIO: N/A SLOPE RATIO: 2:1

DRAINAGE PLAN

GRADE AT BOTTOM OF WALL **PVMT** SMH SEWER CLEANOUT CENTER LINE ST LT STREET LIGHT : CONC CONCRETE TOP OF WALL ELEVATION CONDITIONS, COVENANTS & RESTRICTIONS TYPICAL ELEV ELEVATION WATER METER

FLOW LINE

NOTES


1. THIS TOPOGRAPHIC SURVEY WAS PERFORMED FOR THE PURPOSES OF A SPECIFIC PROJECT, AND SOME AREAS MAY HAVE GREATER OR LESSER DETAIL BASED ON PROJECT REQUIREMENTS. CHANGES TO THE SCOPE, DESIGNER, OR LOCATION OF WORK MAY REQUIRE THAT ADDITIONAL SURVEYING BE PERFORMED TO SATISFY THE NEW REQUIREMENTS.


2. THIS IS A TOPOGRAPHIC SURVEY, NOT A BOUNDARY SURVEY OR RECORD OF SURVEY. THE PROPERTY LINES DEPICTED ON THIS PLAN ARE GENERATED FROM EXISTING PUBLIC RECORD MAPS, DRAWINGS, OR DESCRIPTIONS. THE PROPERTY LINES AND/OR EASEMENTS SHOWN HEREON HAVE BEEN INCLUDED TO REPRESENT THEIR APPROXIMATE LOCATIONS RELATIVE TO THE TOPOGRAPHIC FEATURES.


3. THE LOCATIONS OF UTILITIES, IF ANY, SHOWN ON THIS PLAN ARE GENERATED FROM RECORDS PROVIDED BY UTILITY/GOVERNING AGENCIES AND/OR FIELD DATA COLLECTED DURING THE SURVEY. THE PLOTTING OF UTILITIES ON THIS PLAN DOES NOT CONSTITUTE A GUARANTEE OF THEIR LOCATION, DEPTH, SIZE, OR TYPE.


4. PRIOR TO THE ISSUANCE OF ANY CONSTRUCTION PERMIT THE OWNER/PERMITTEE SHALL SUBMIT A WATER POLLUTION CONTROL PLAN (WPCP). THE WPCP SHALL BE PREPARED IN ACCORDANCE WITH THE GUIDELINES IN PART 2 CONSTRUCTION BMP STANDARDS CHAPTER 4 OF THE CITY'S STORM WATER STANDARDS.


ALL DOMESTIC WATER SERVICE LINE DIAMETERS ARE PROVIDED FOR CLARITY OF INTENT ONLY. ACTUAL SERVICE LINE DIAMETERS WILL BE BASED UPON THE PROJECT'S APPROVED WATER METER DATA CARD.

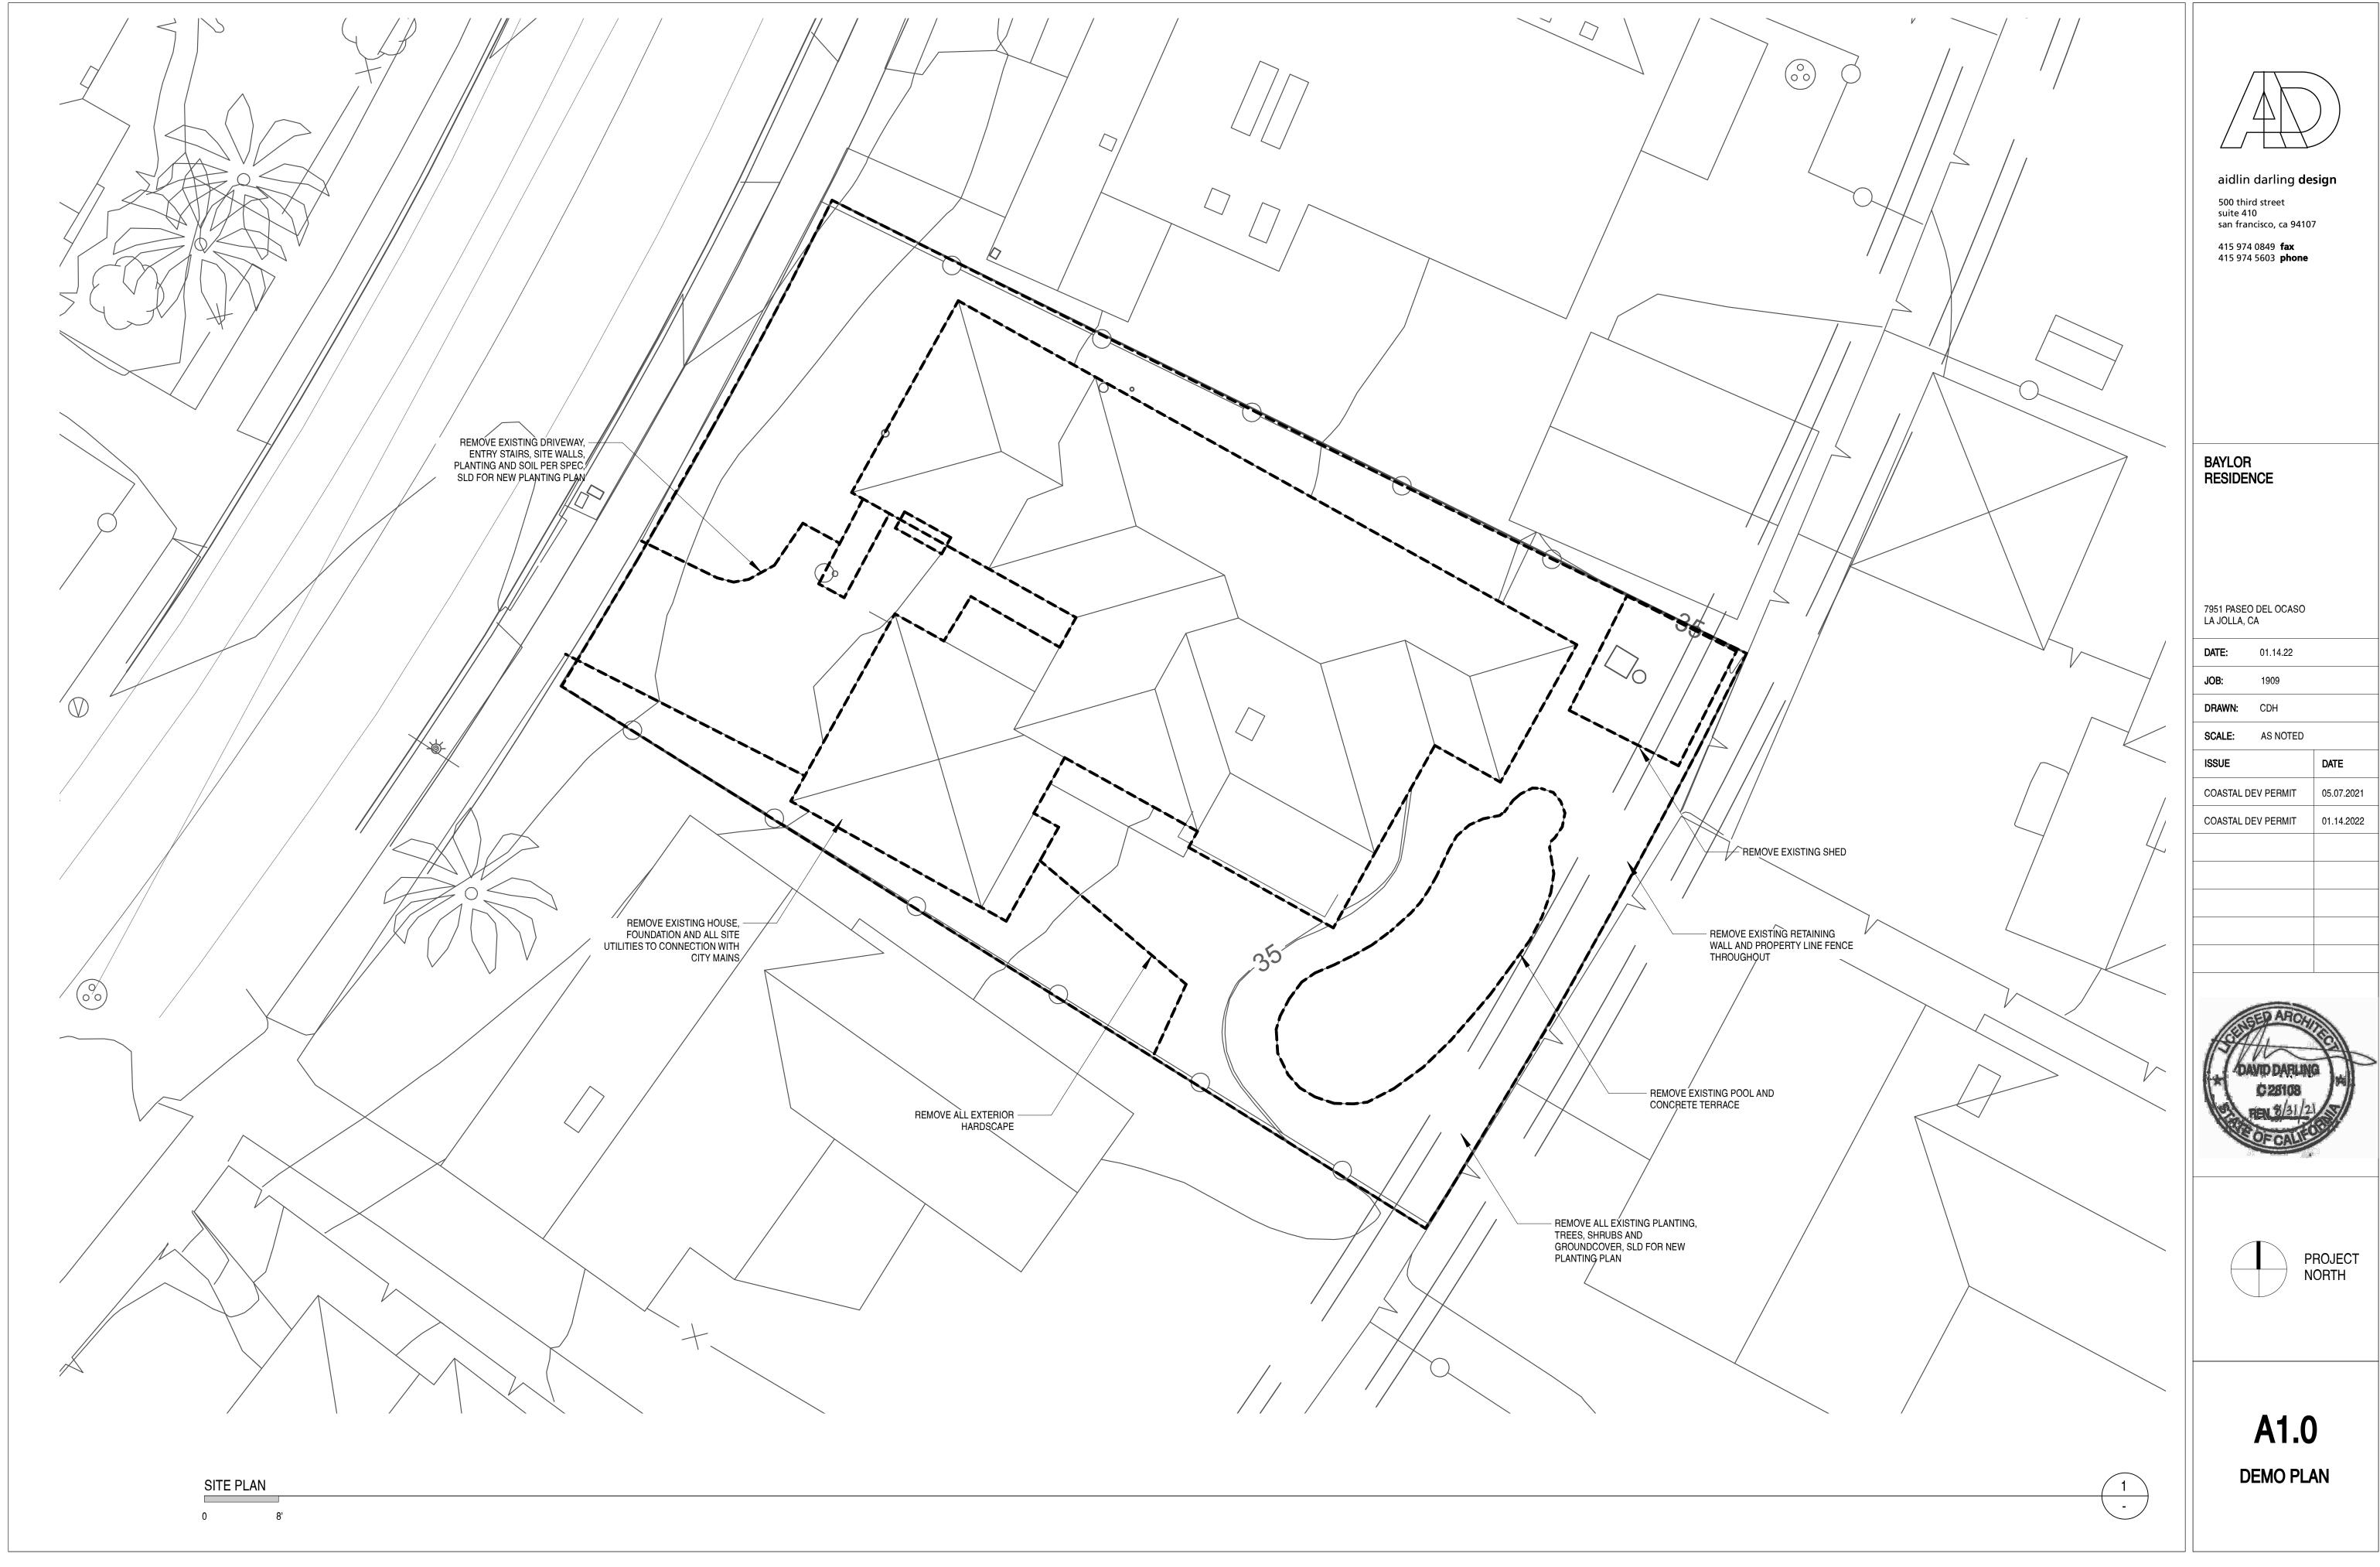


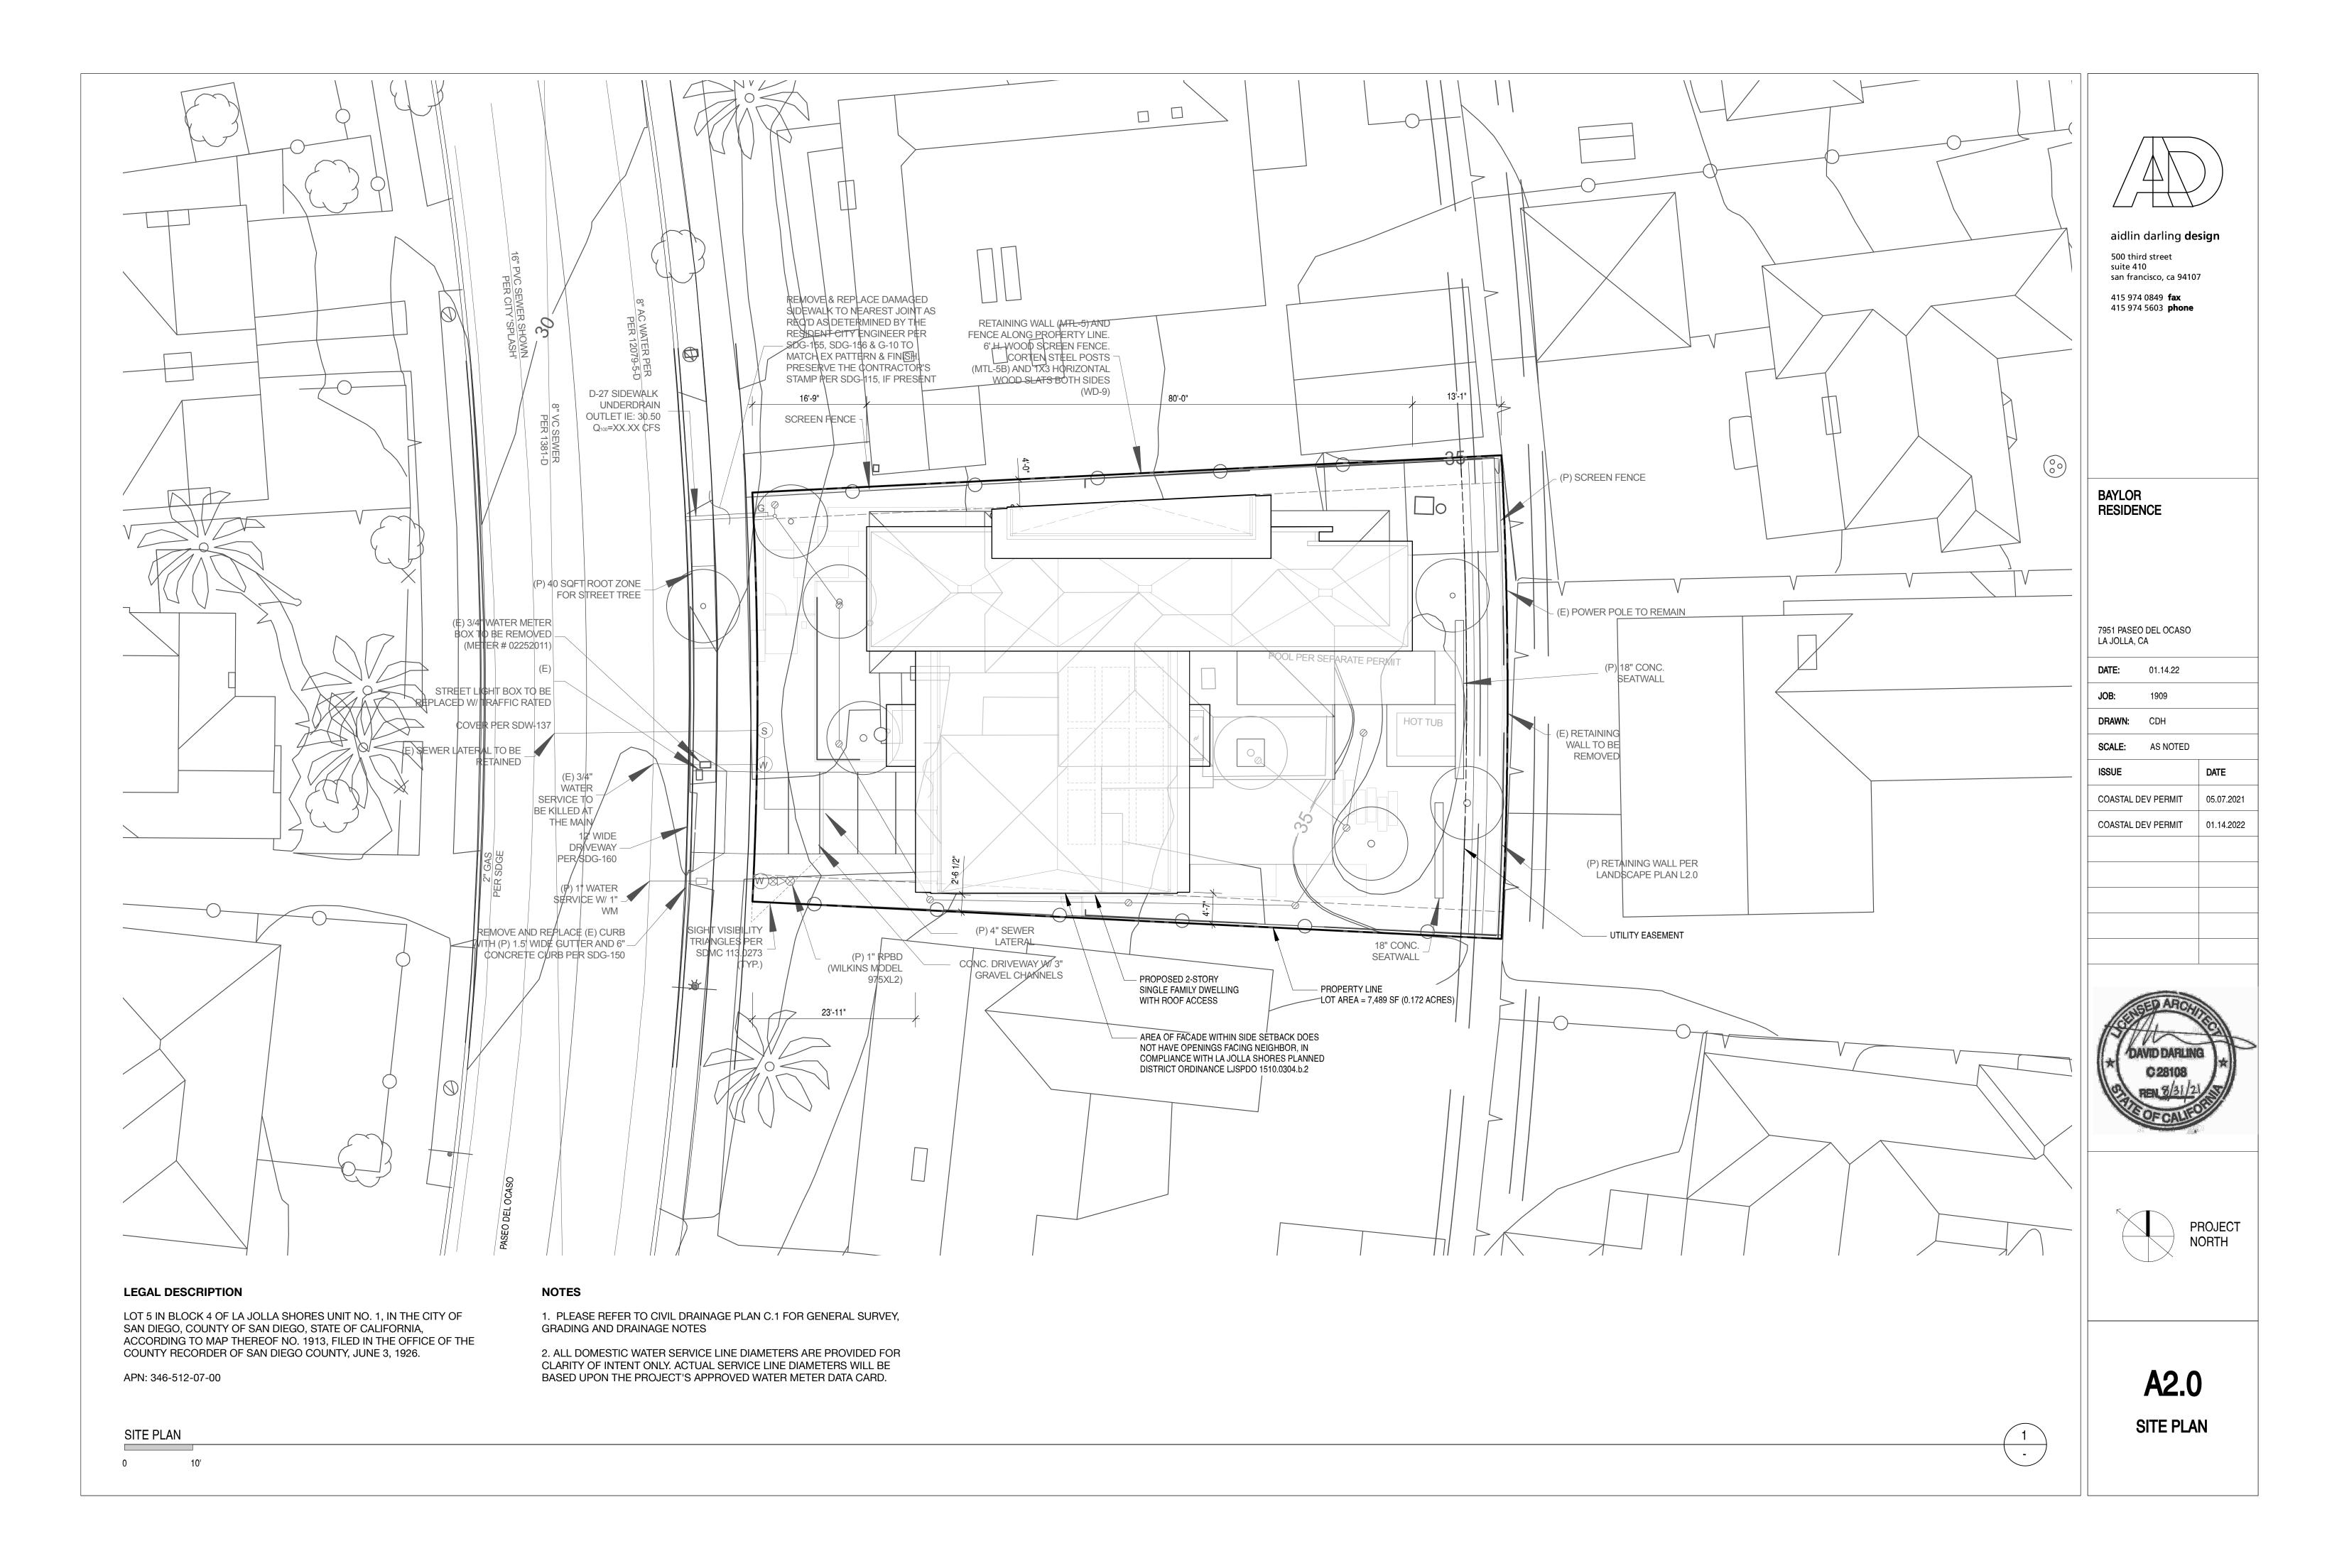


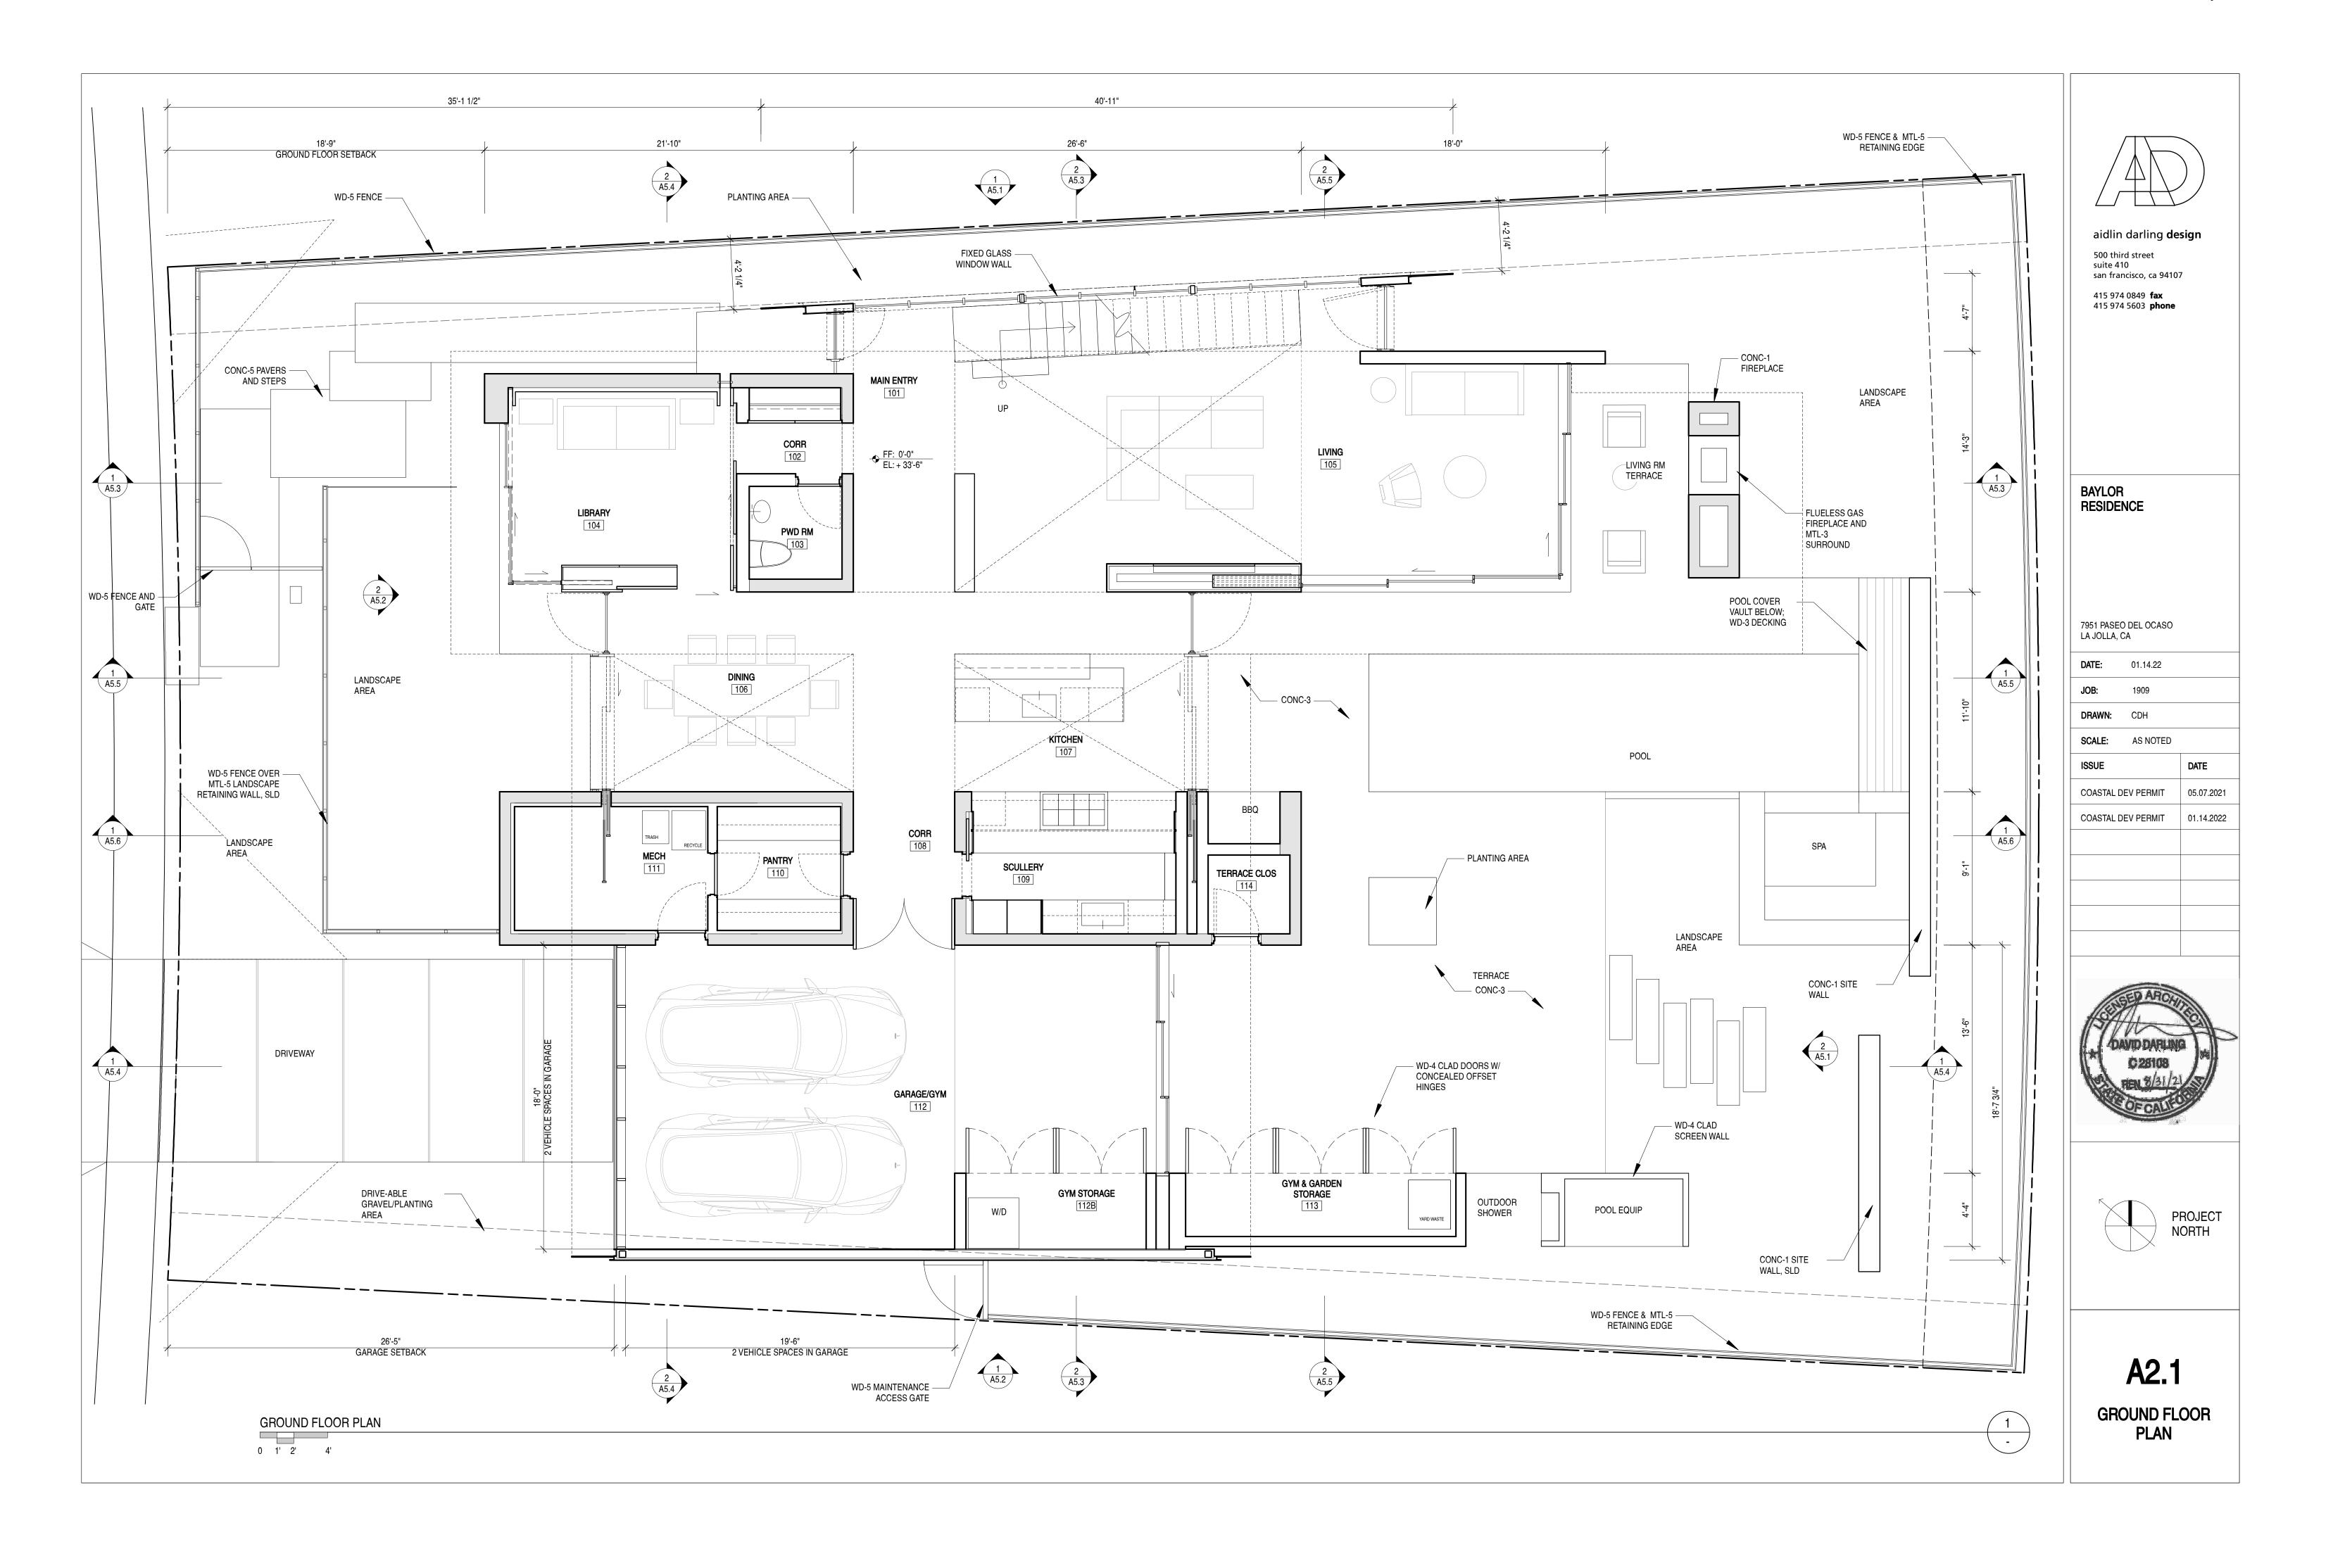


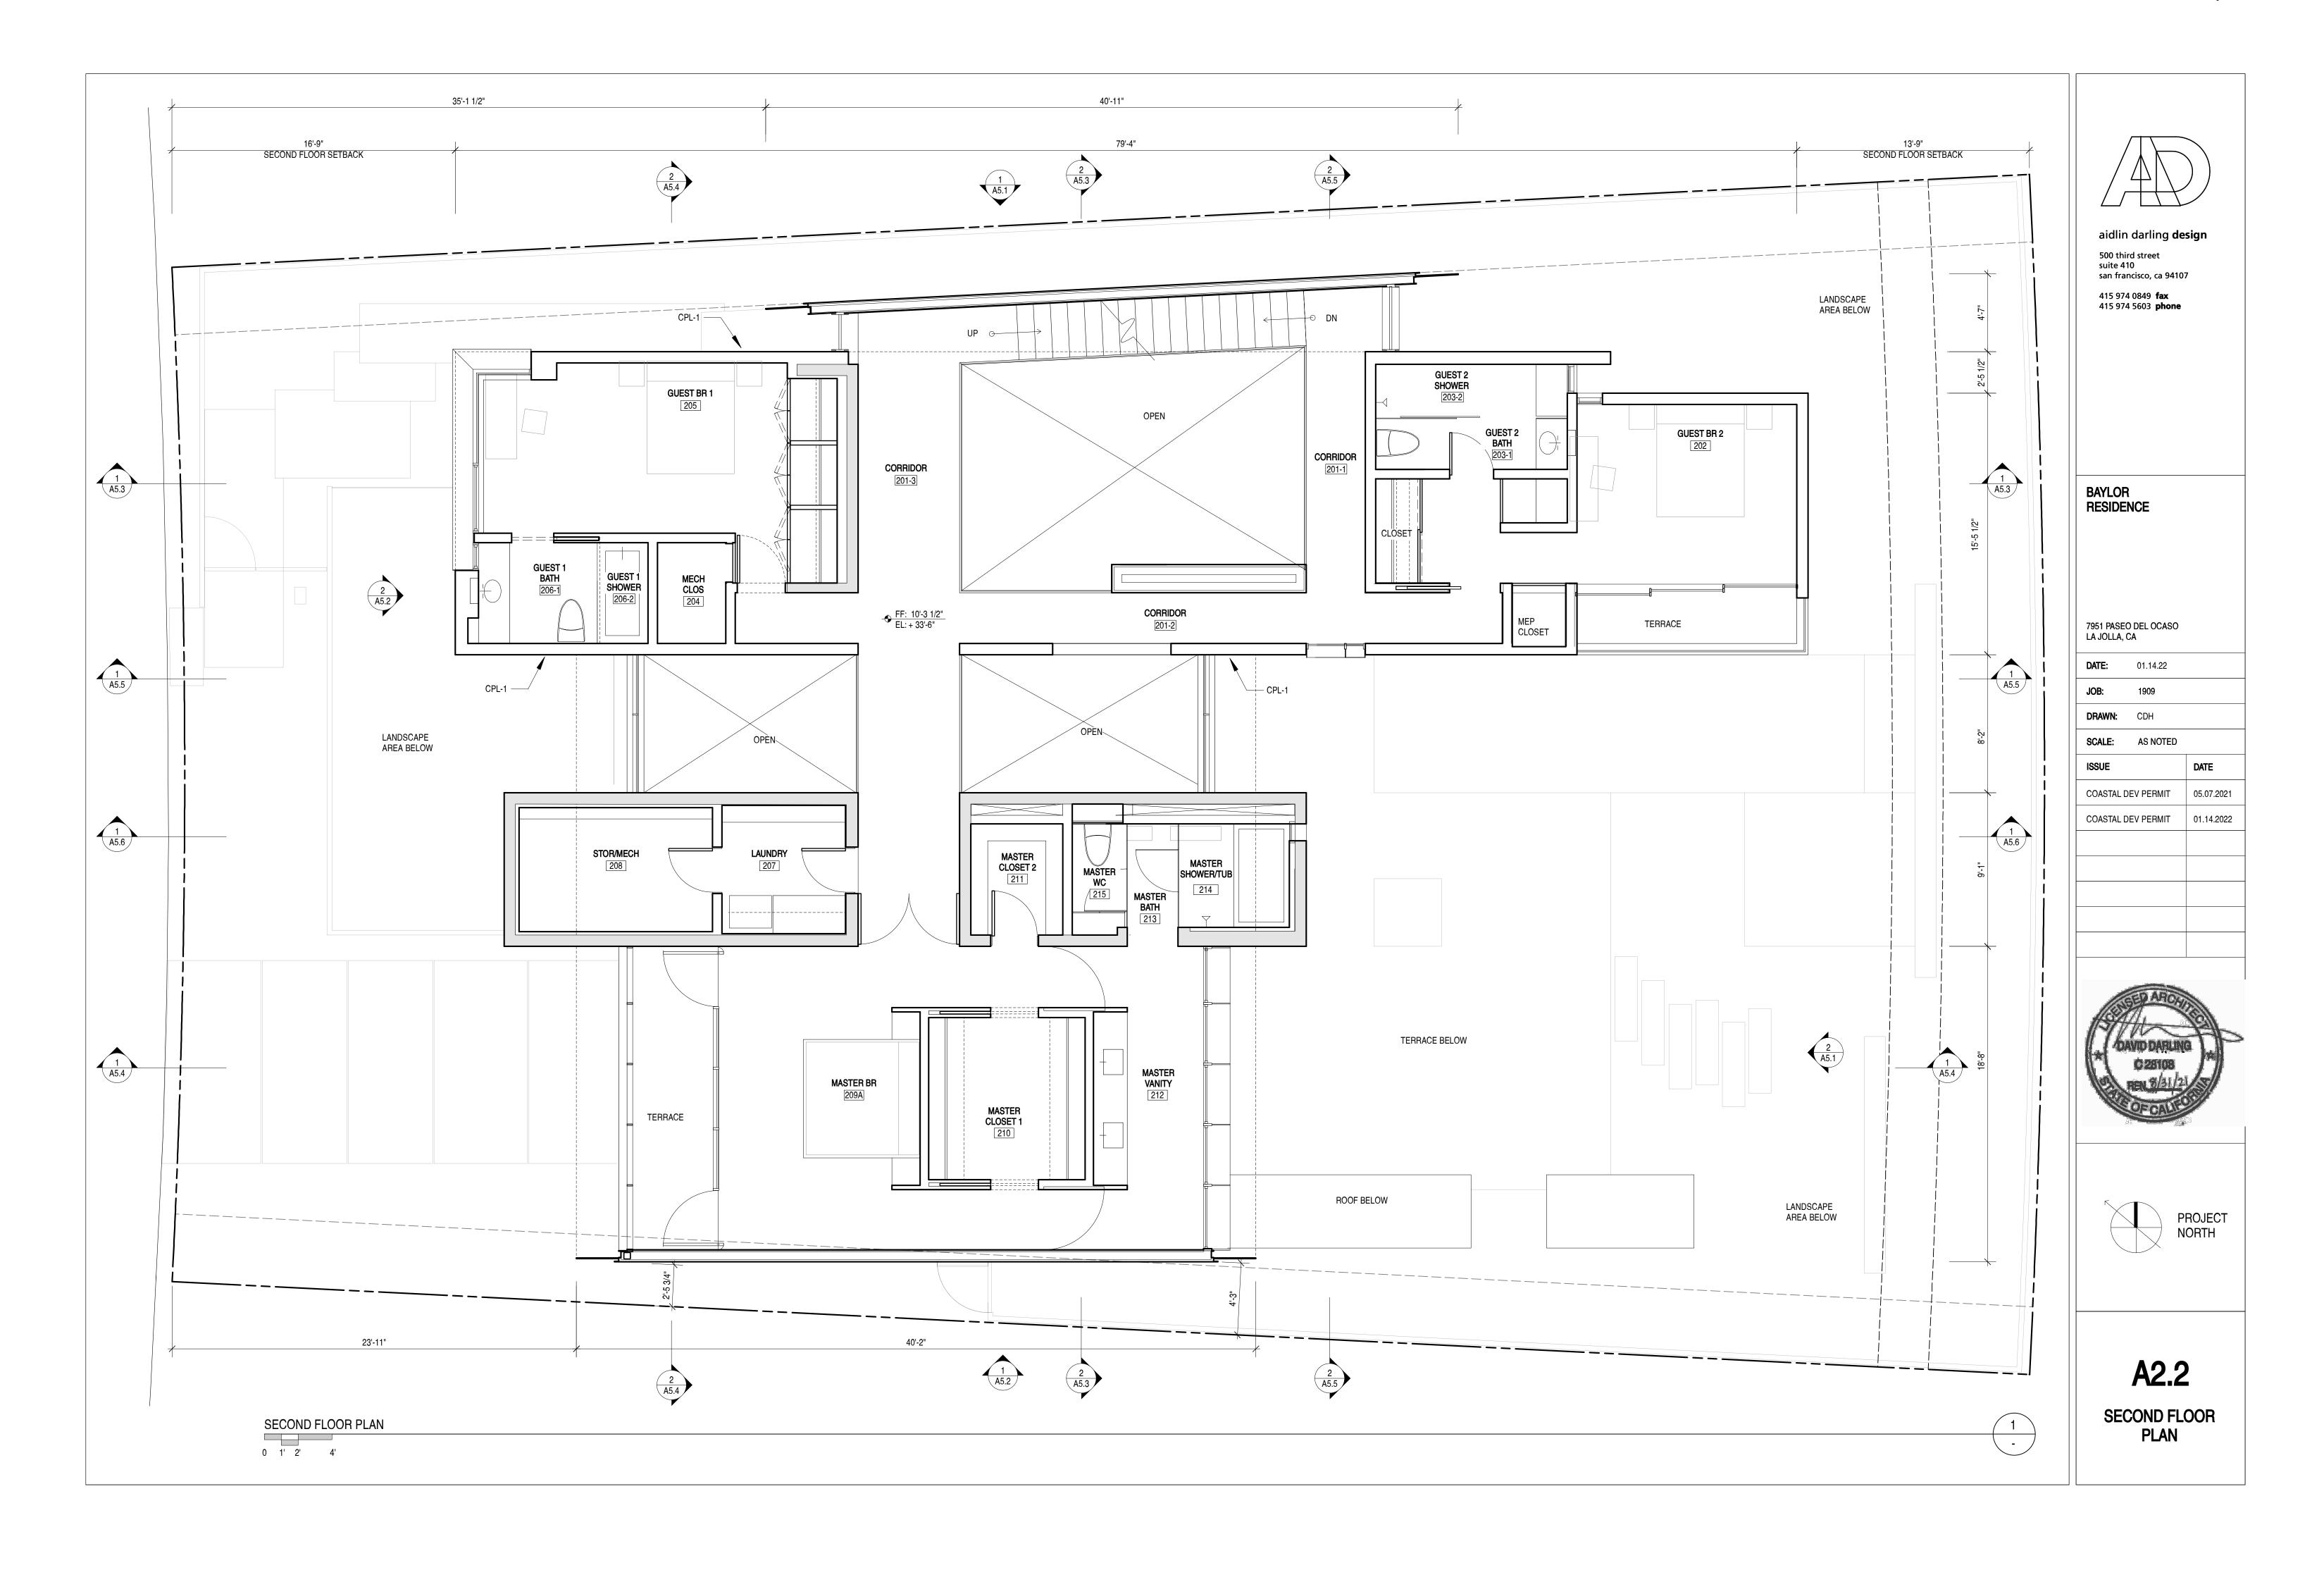


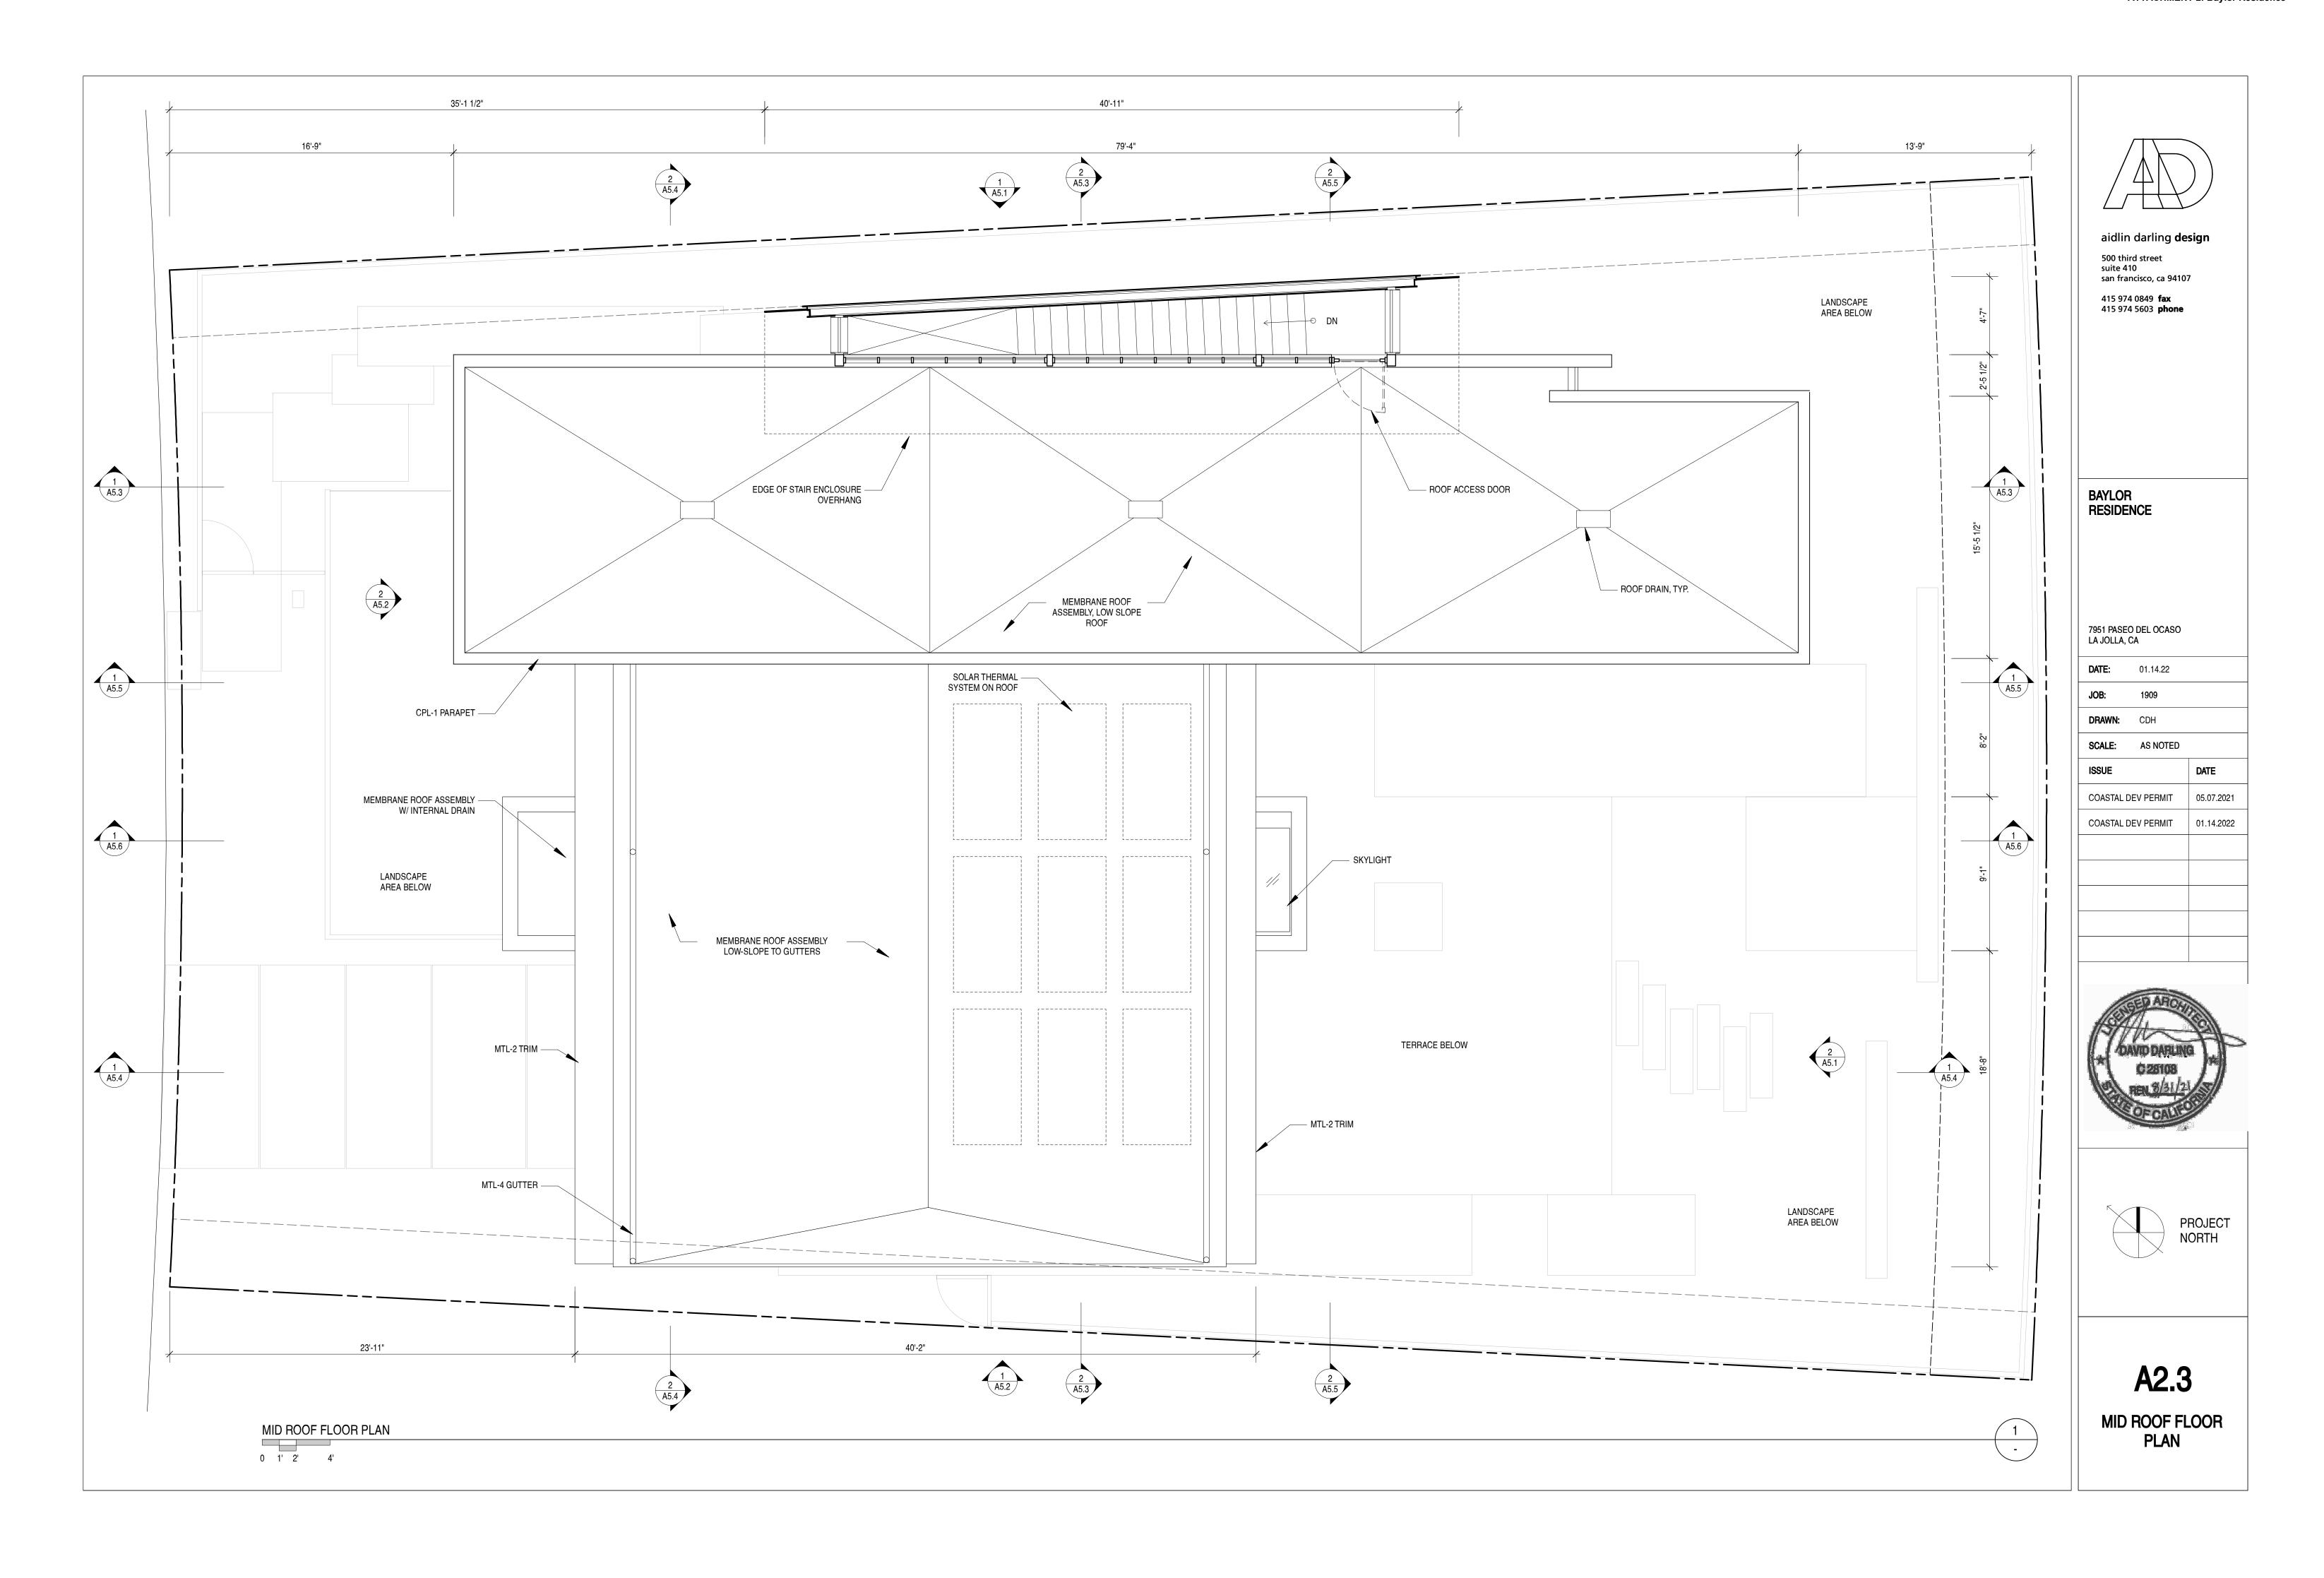


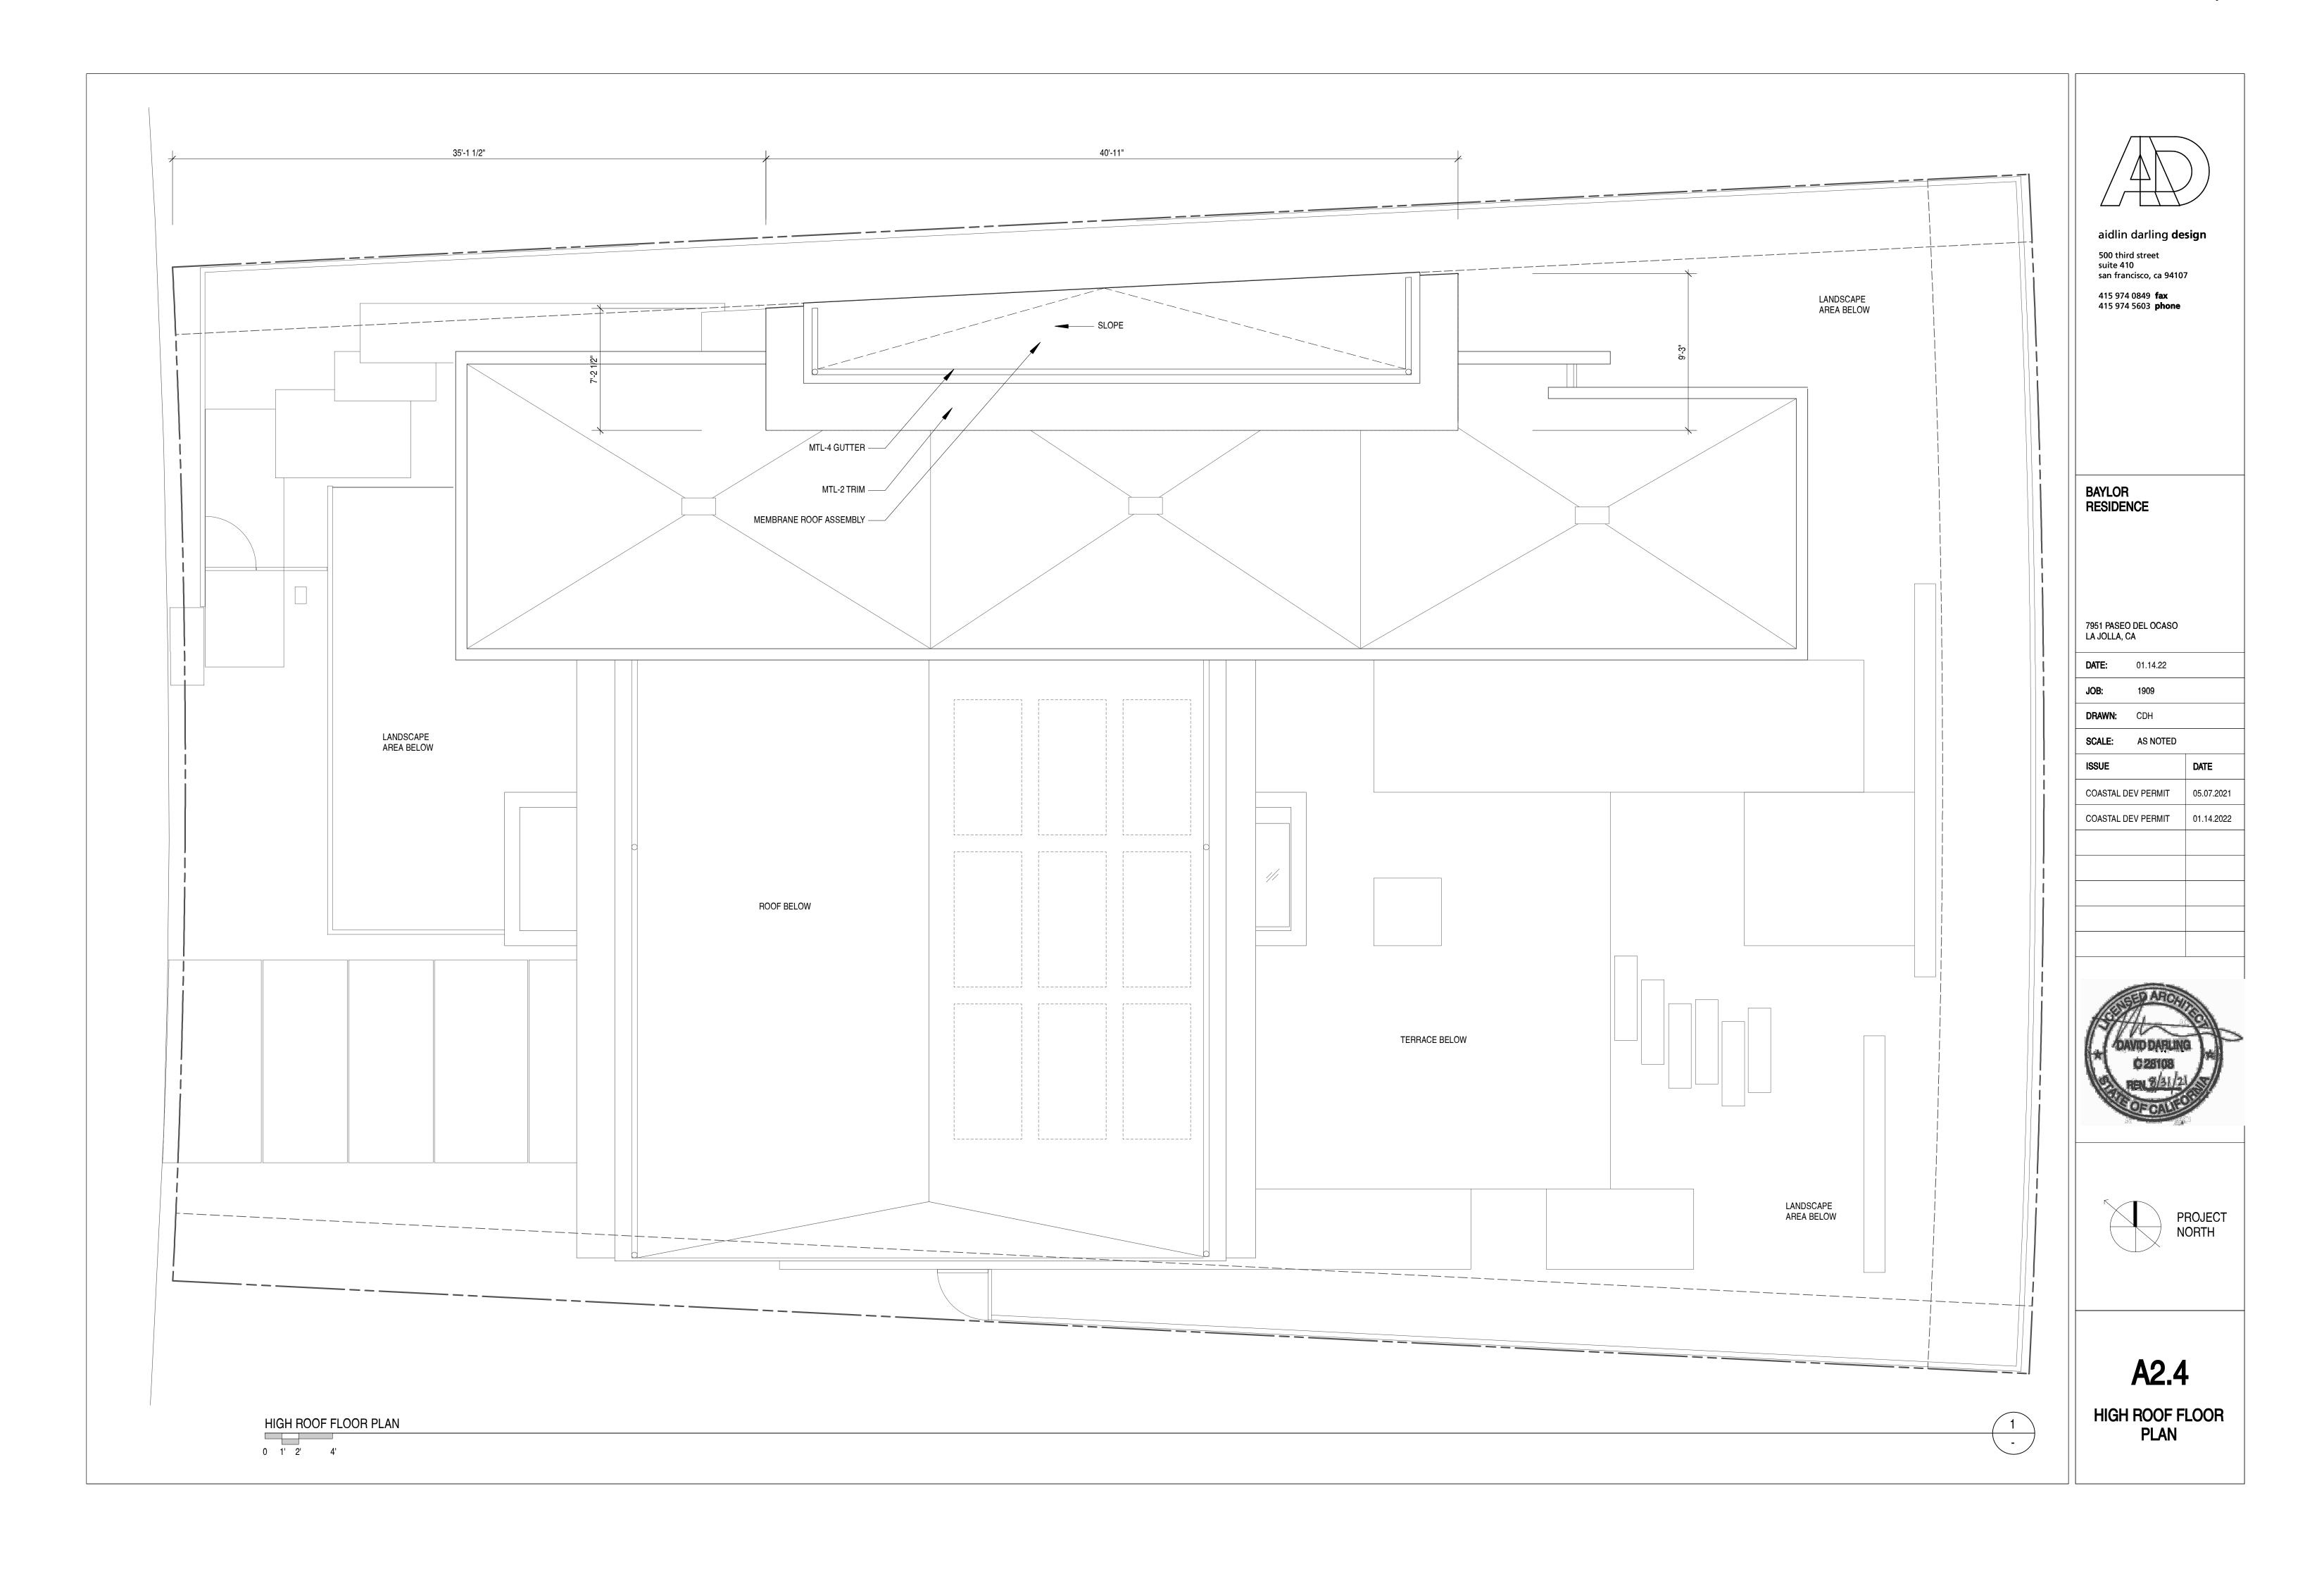


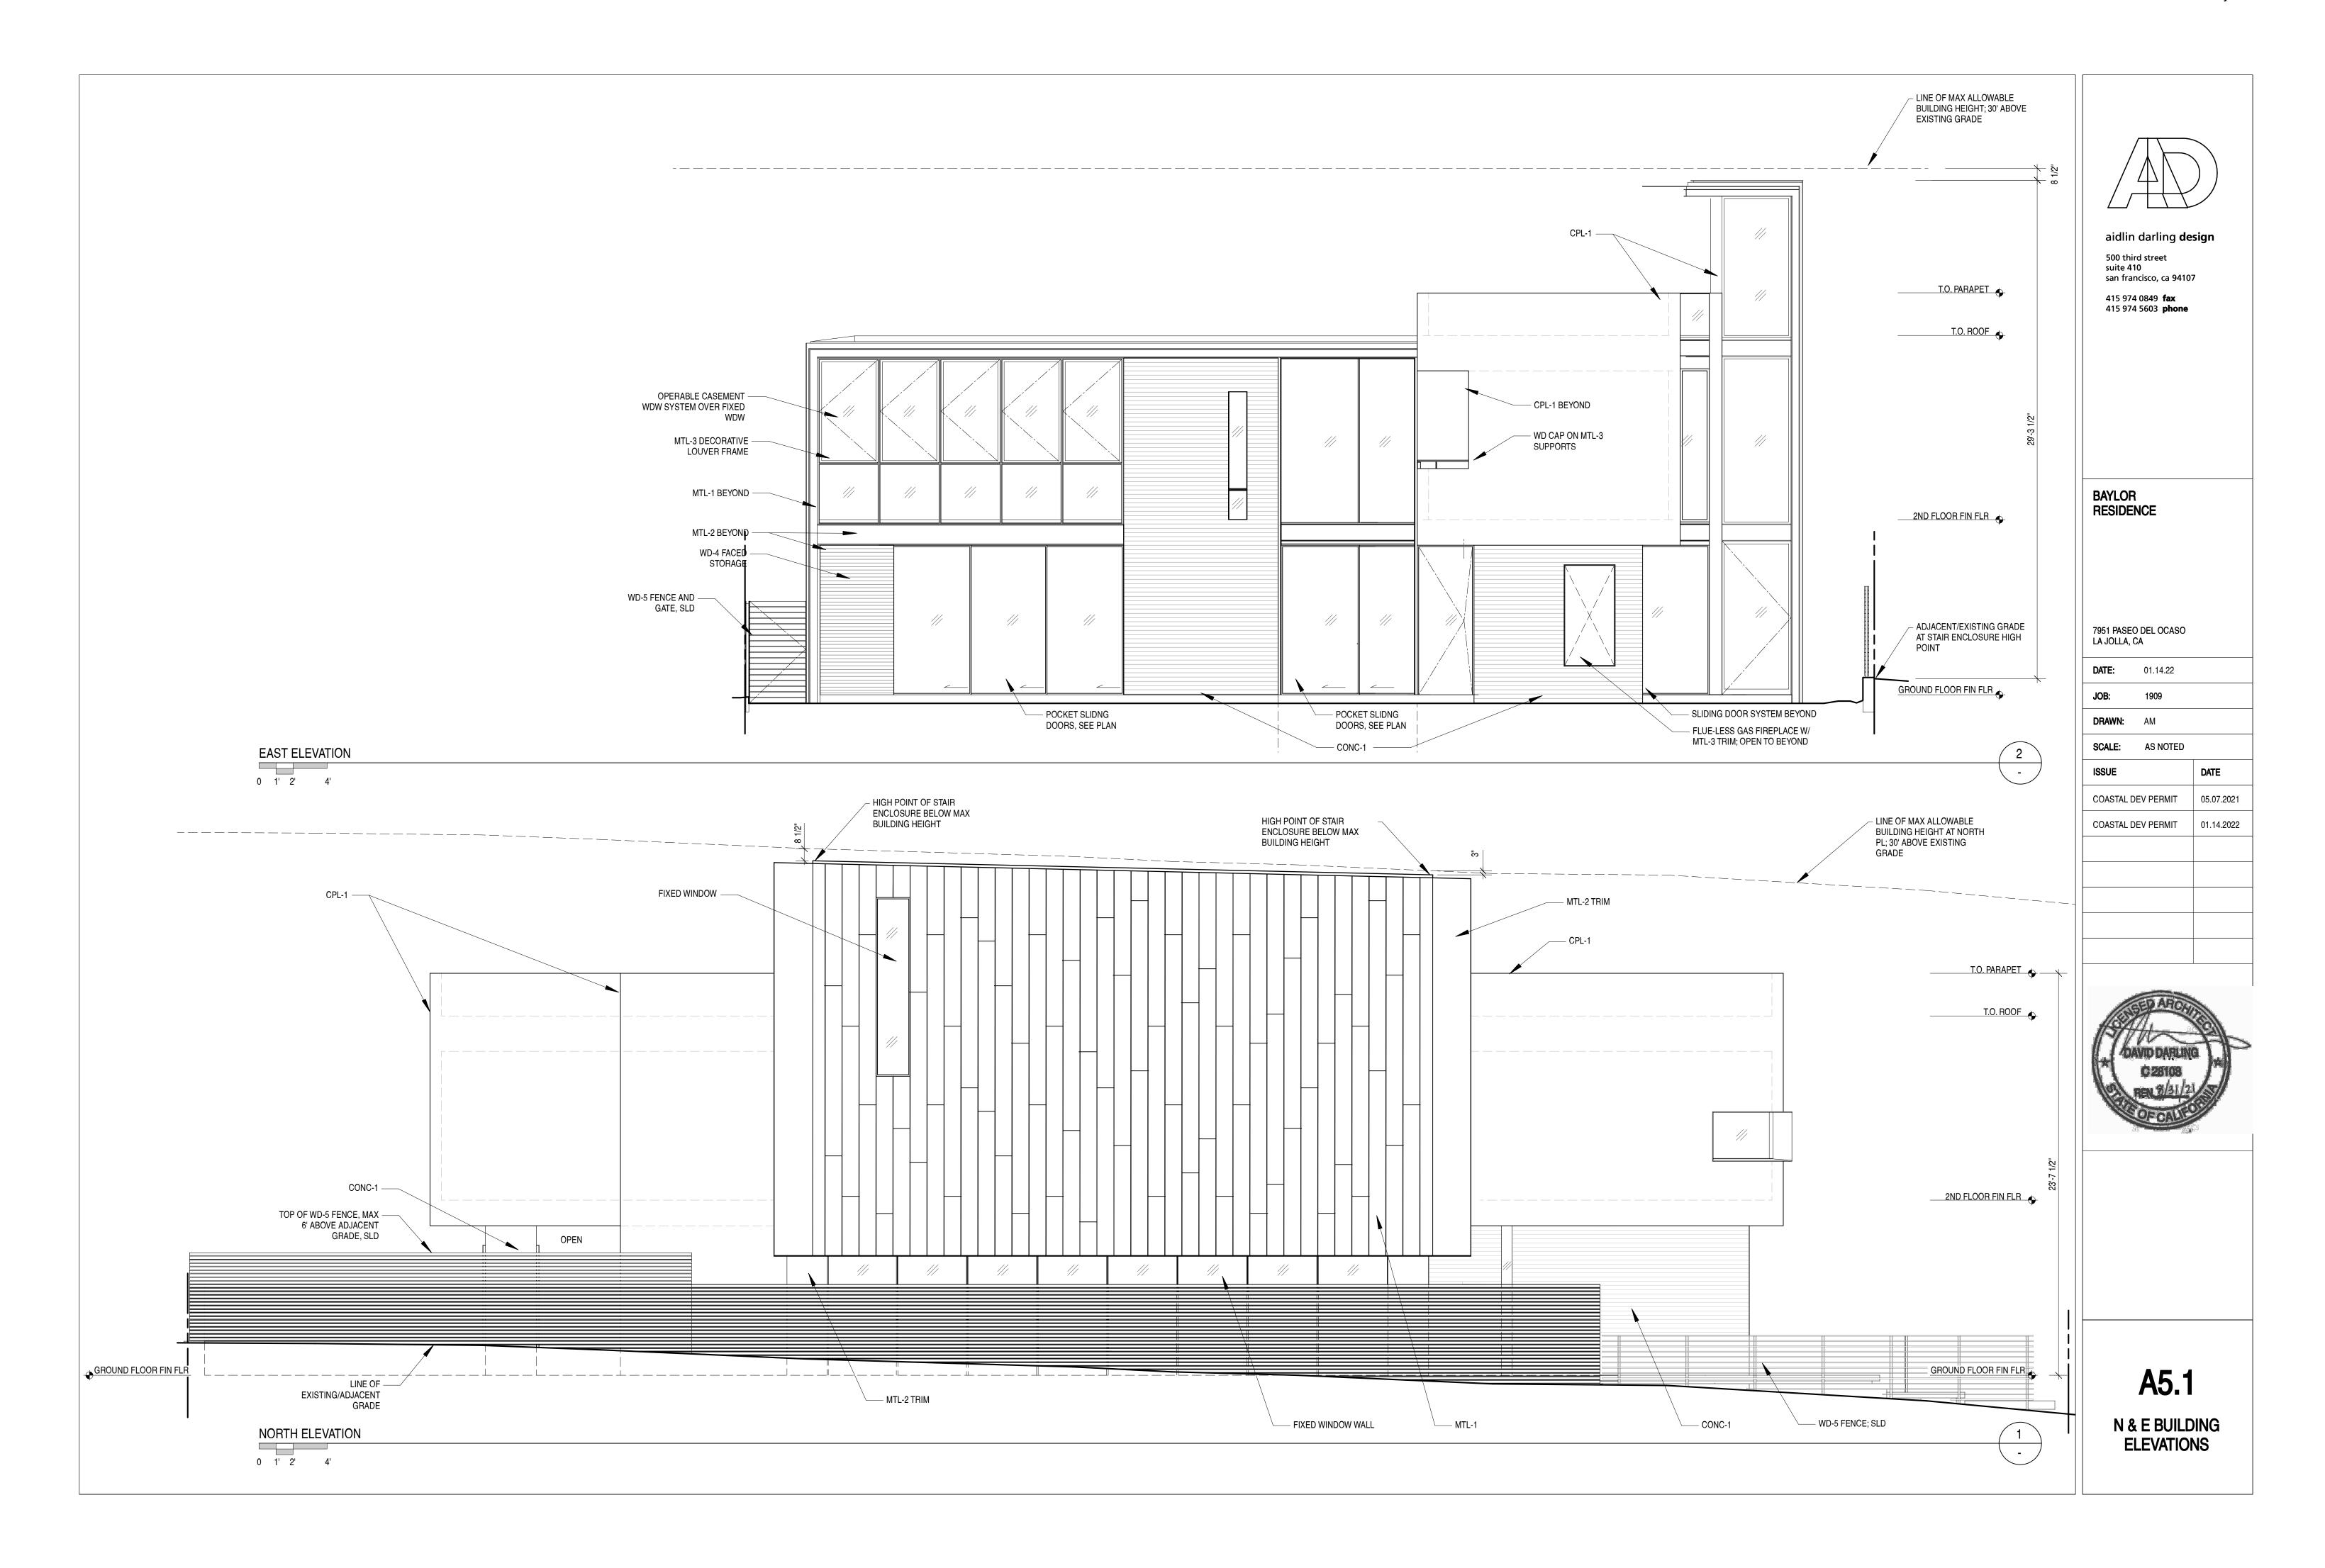


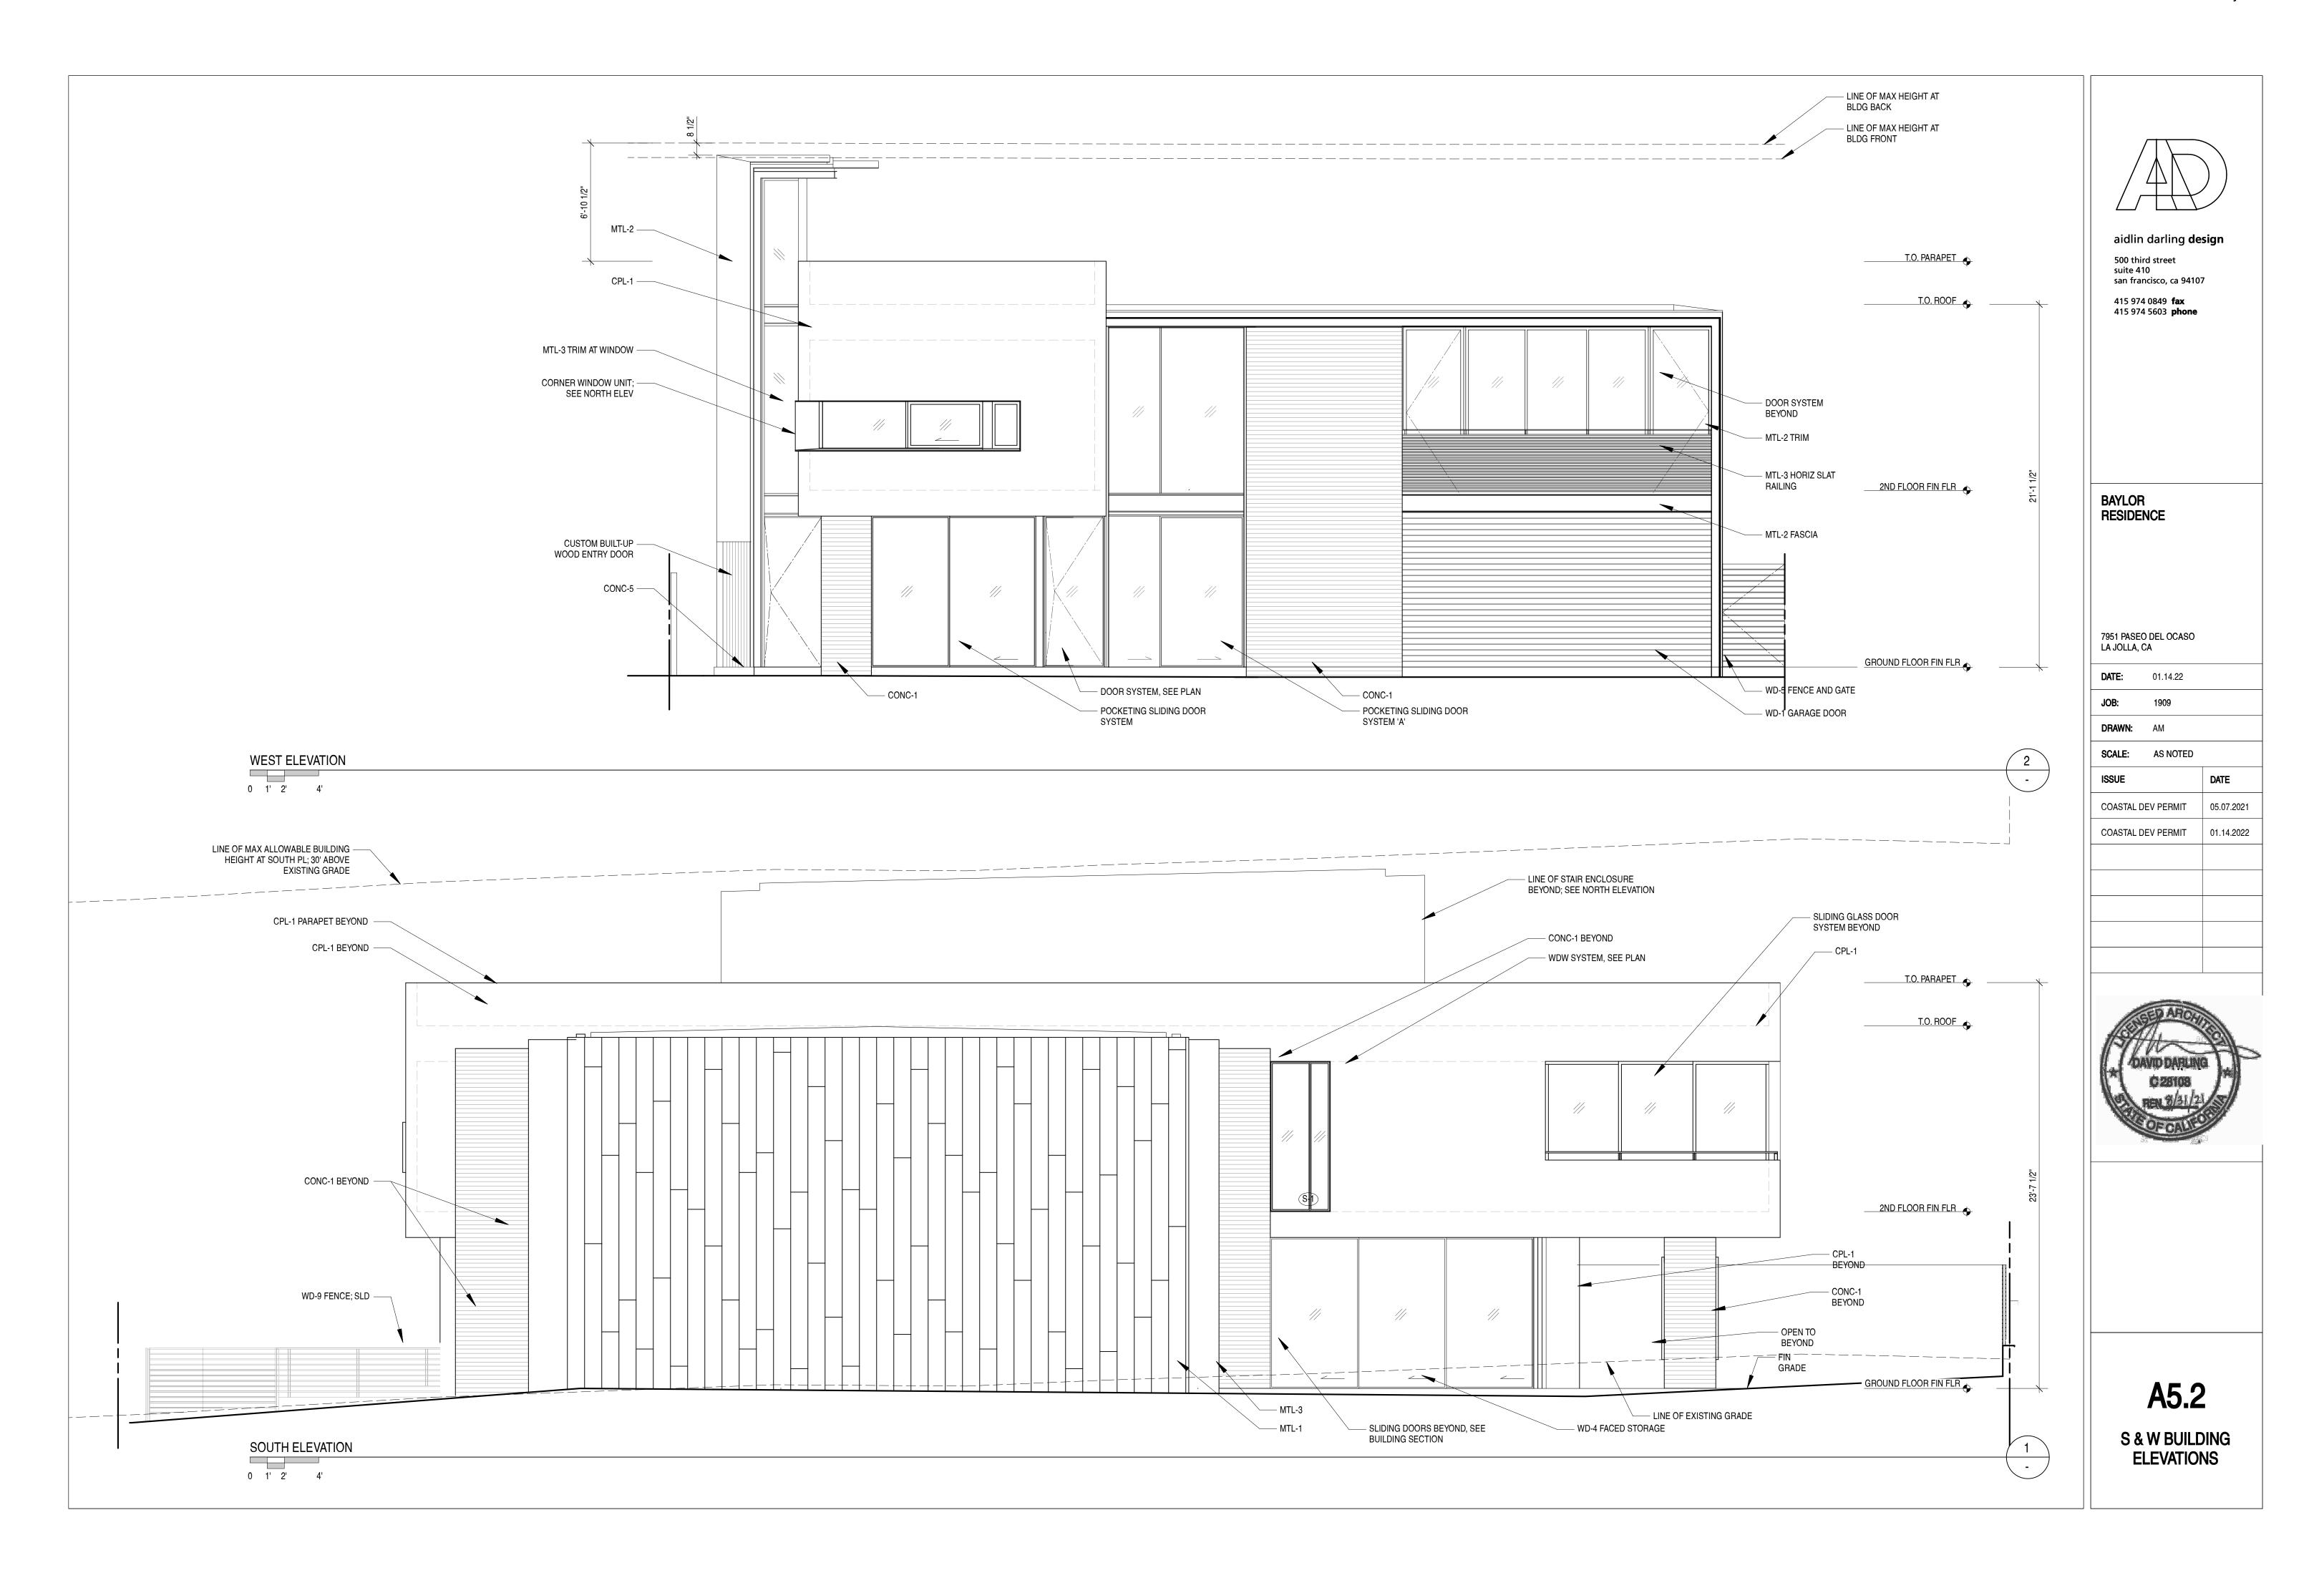


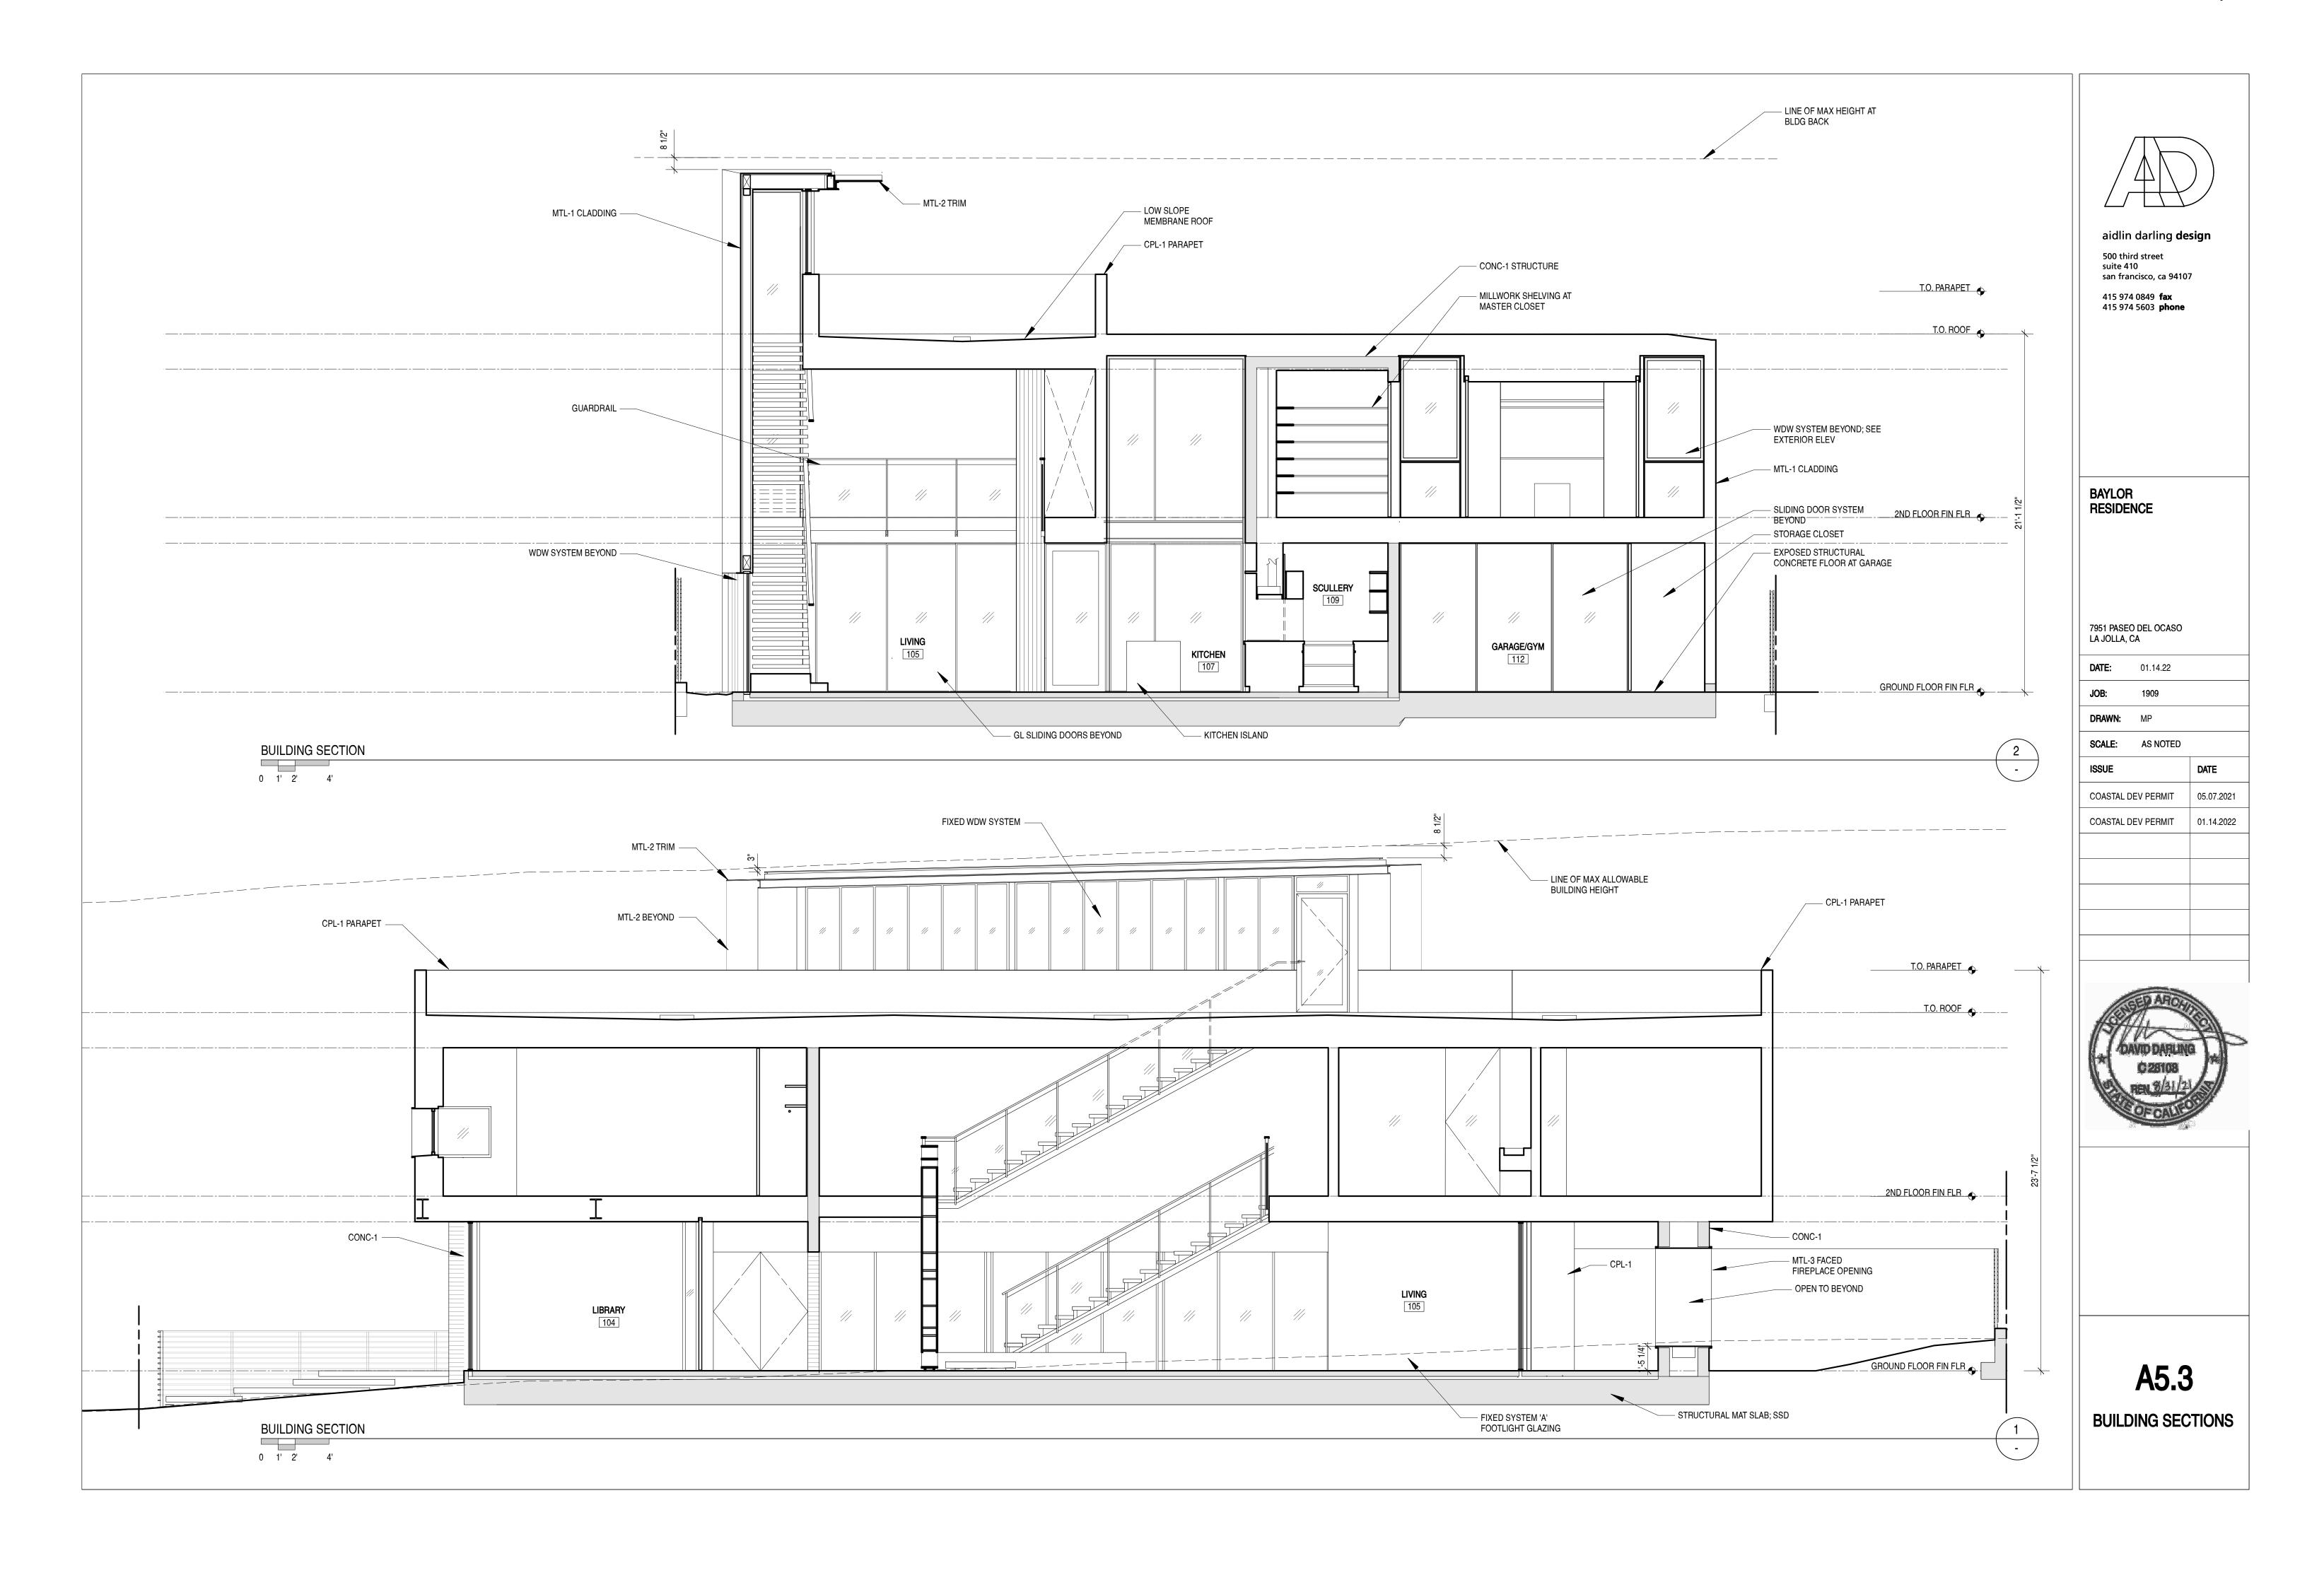

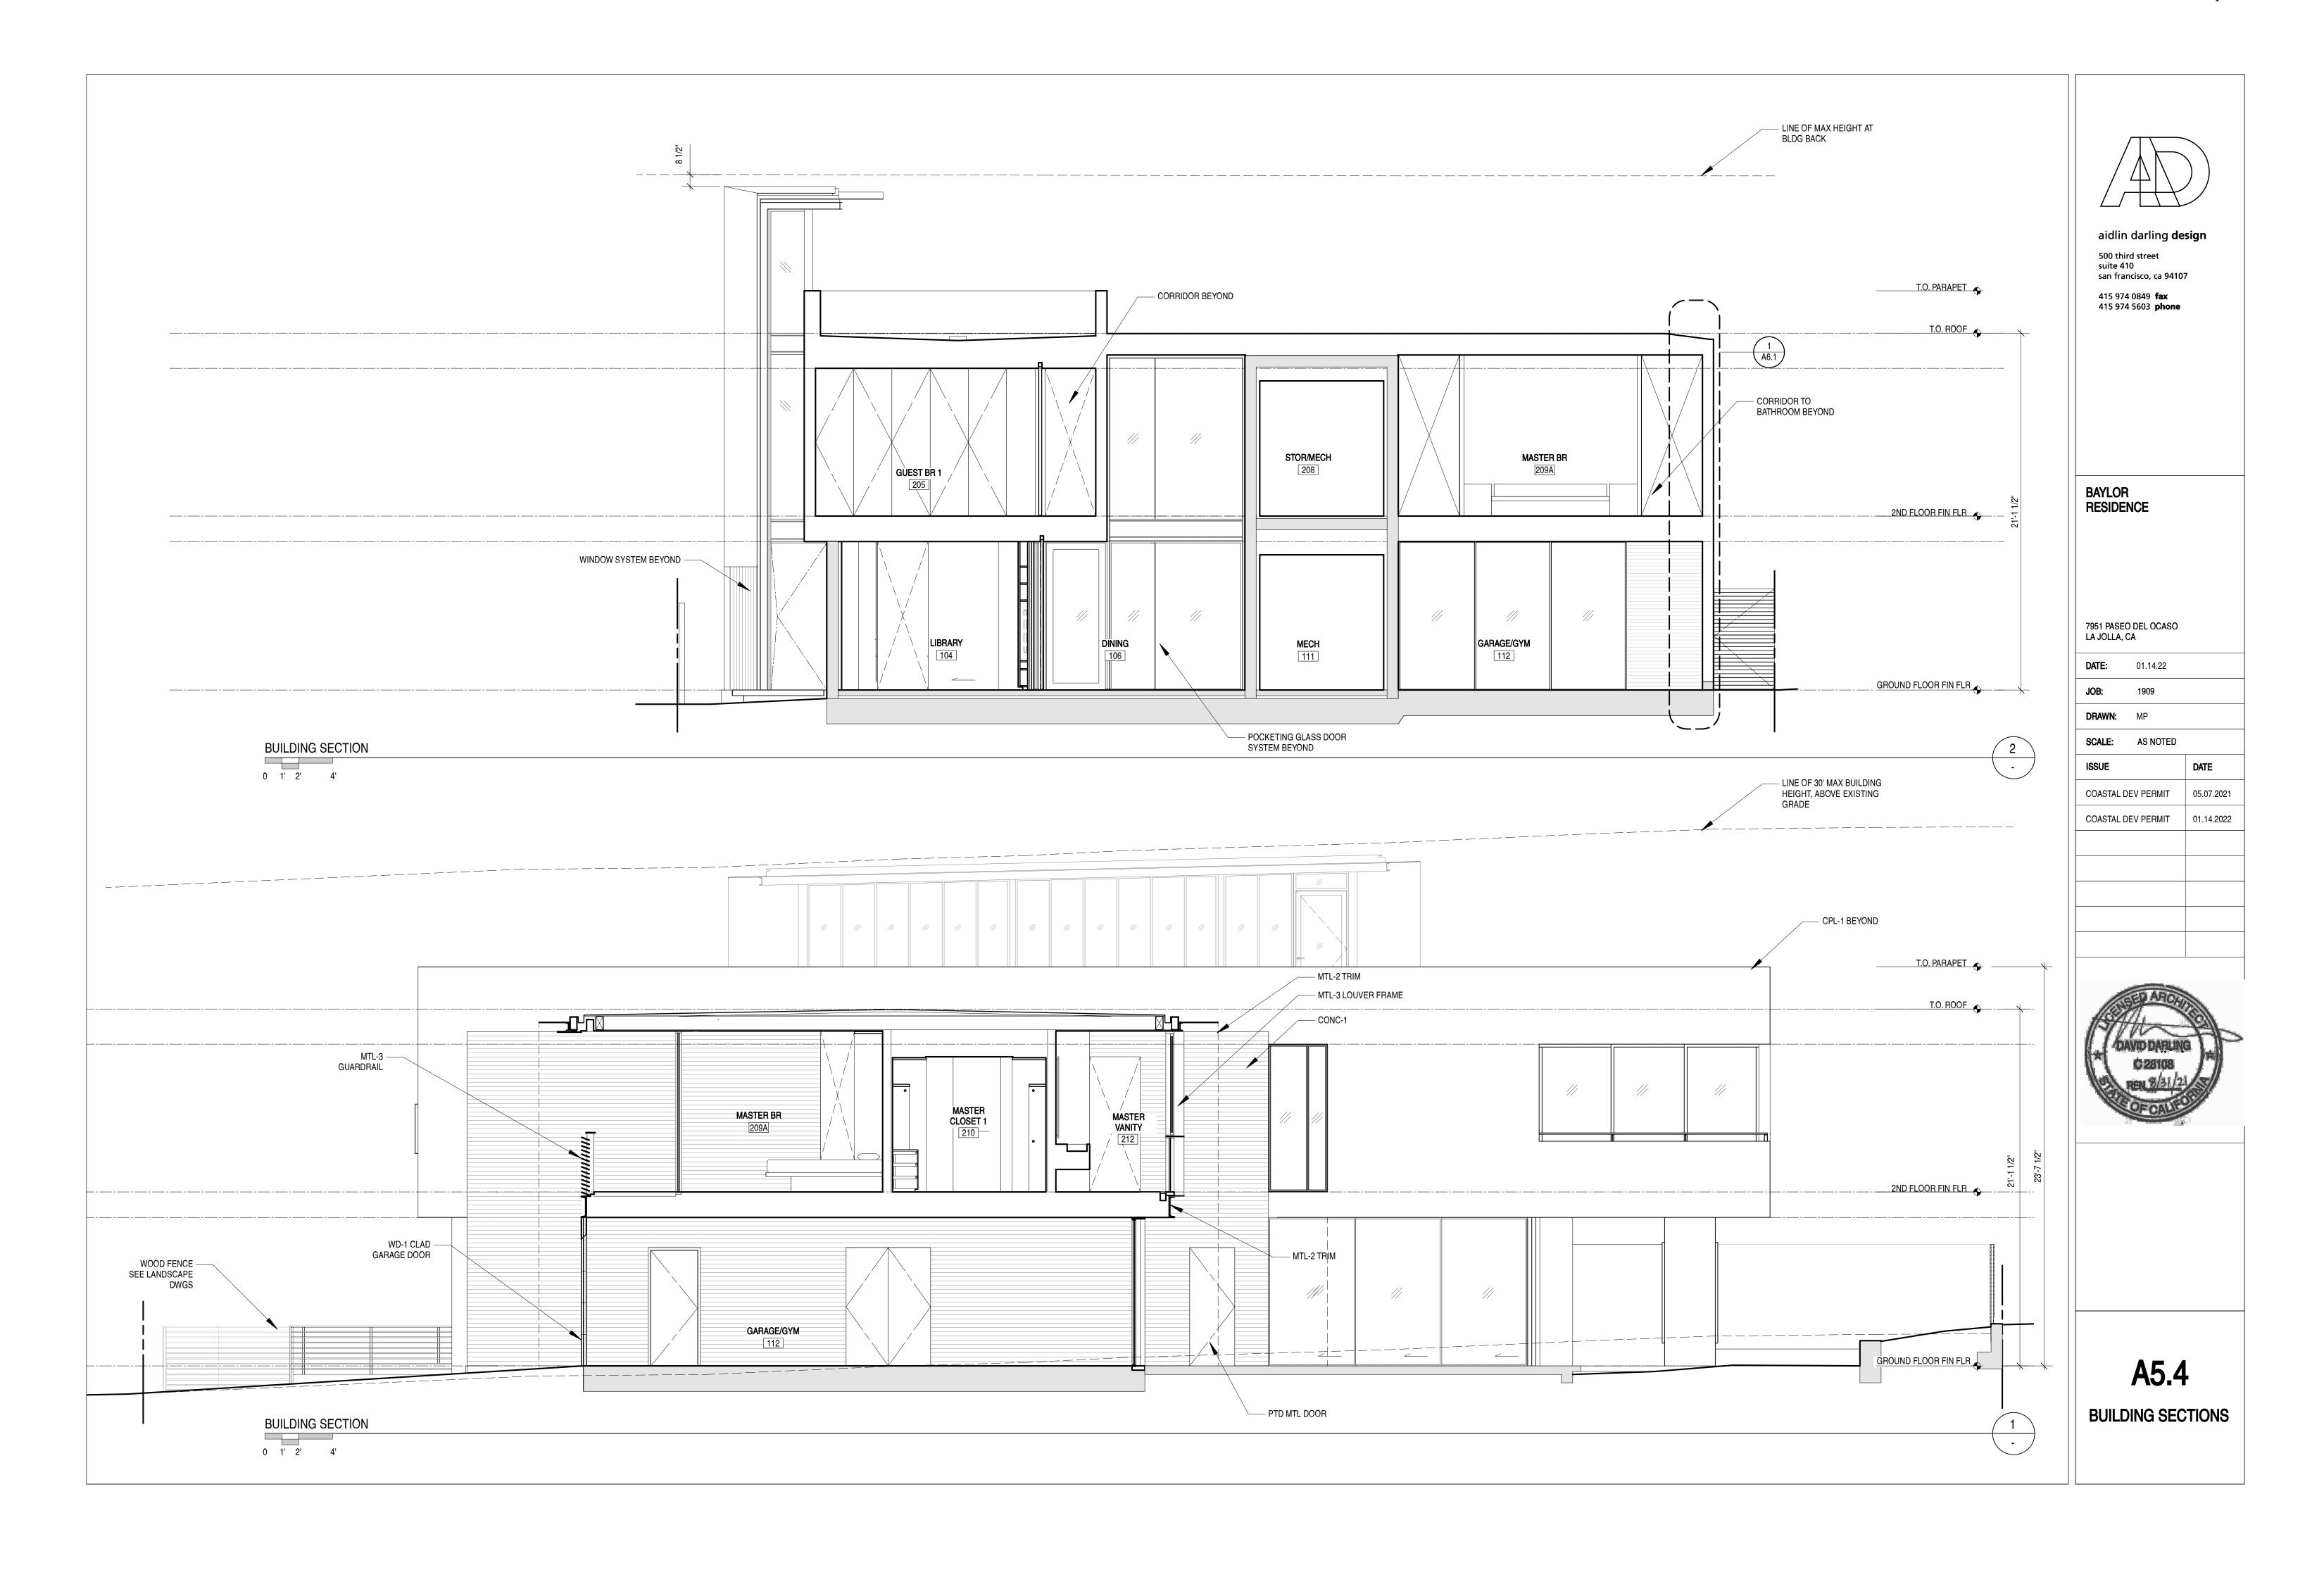

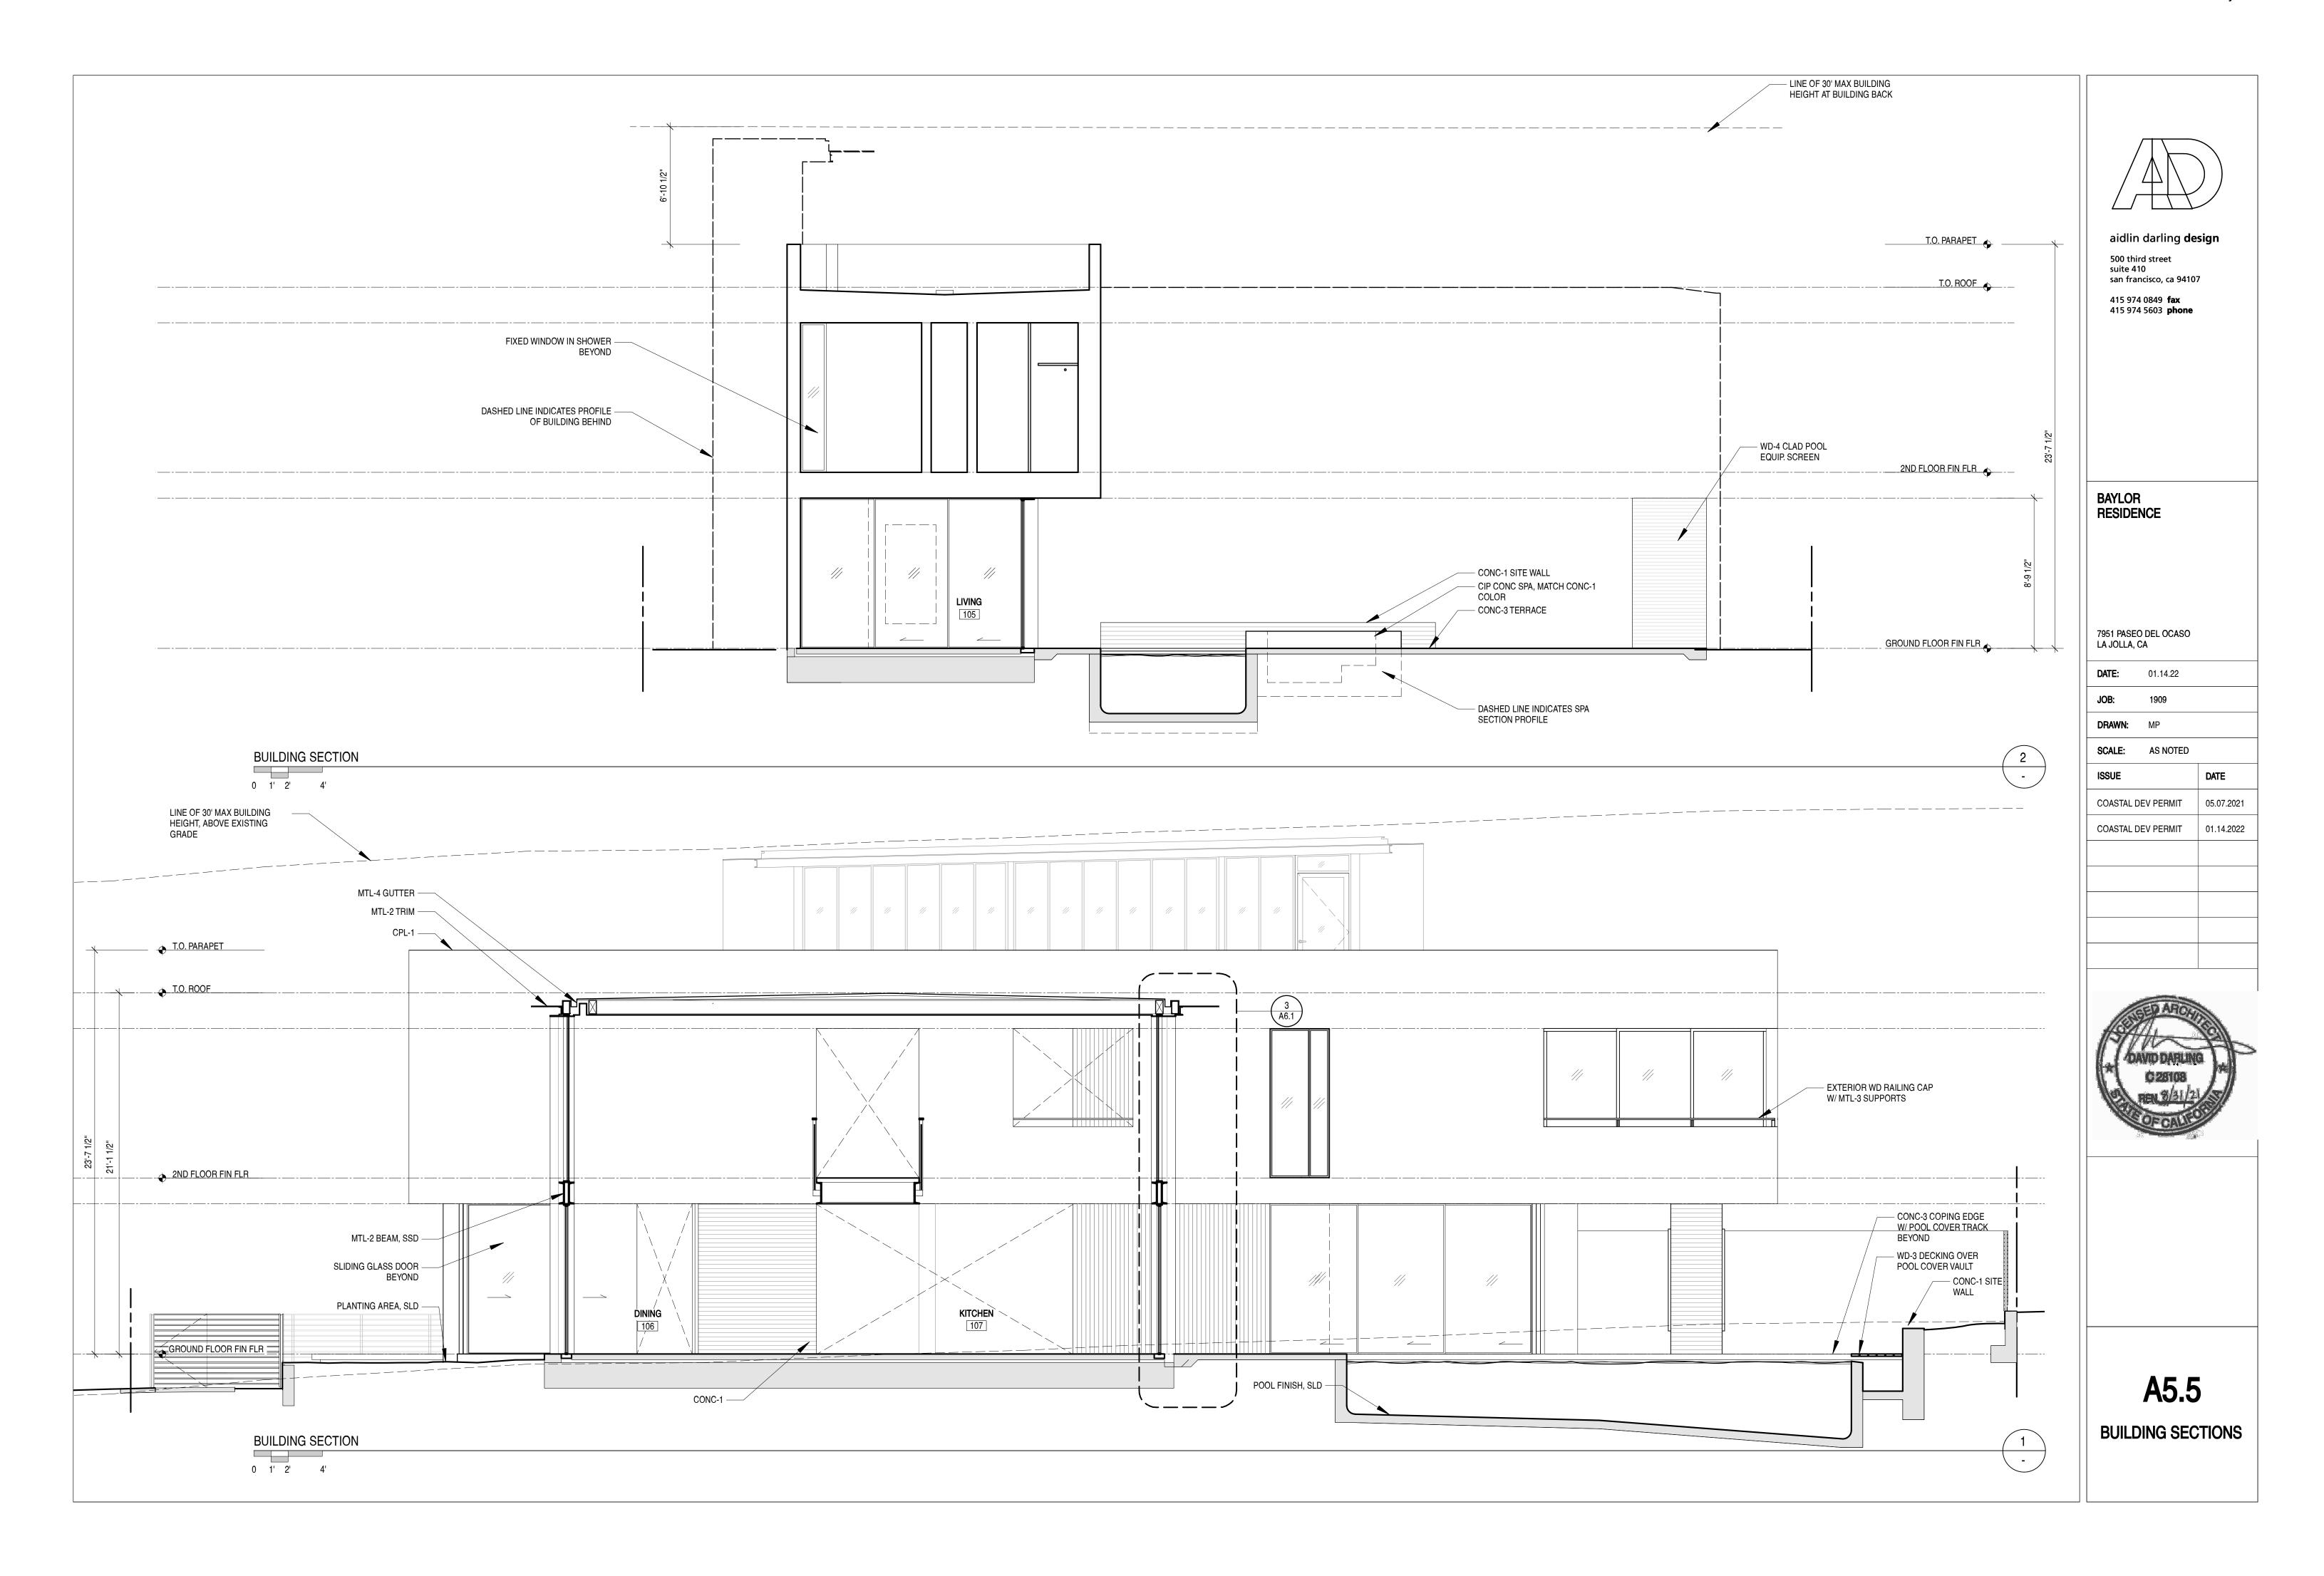


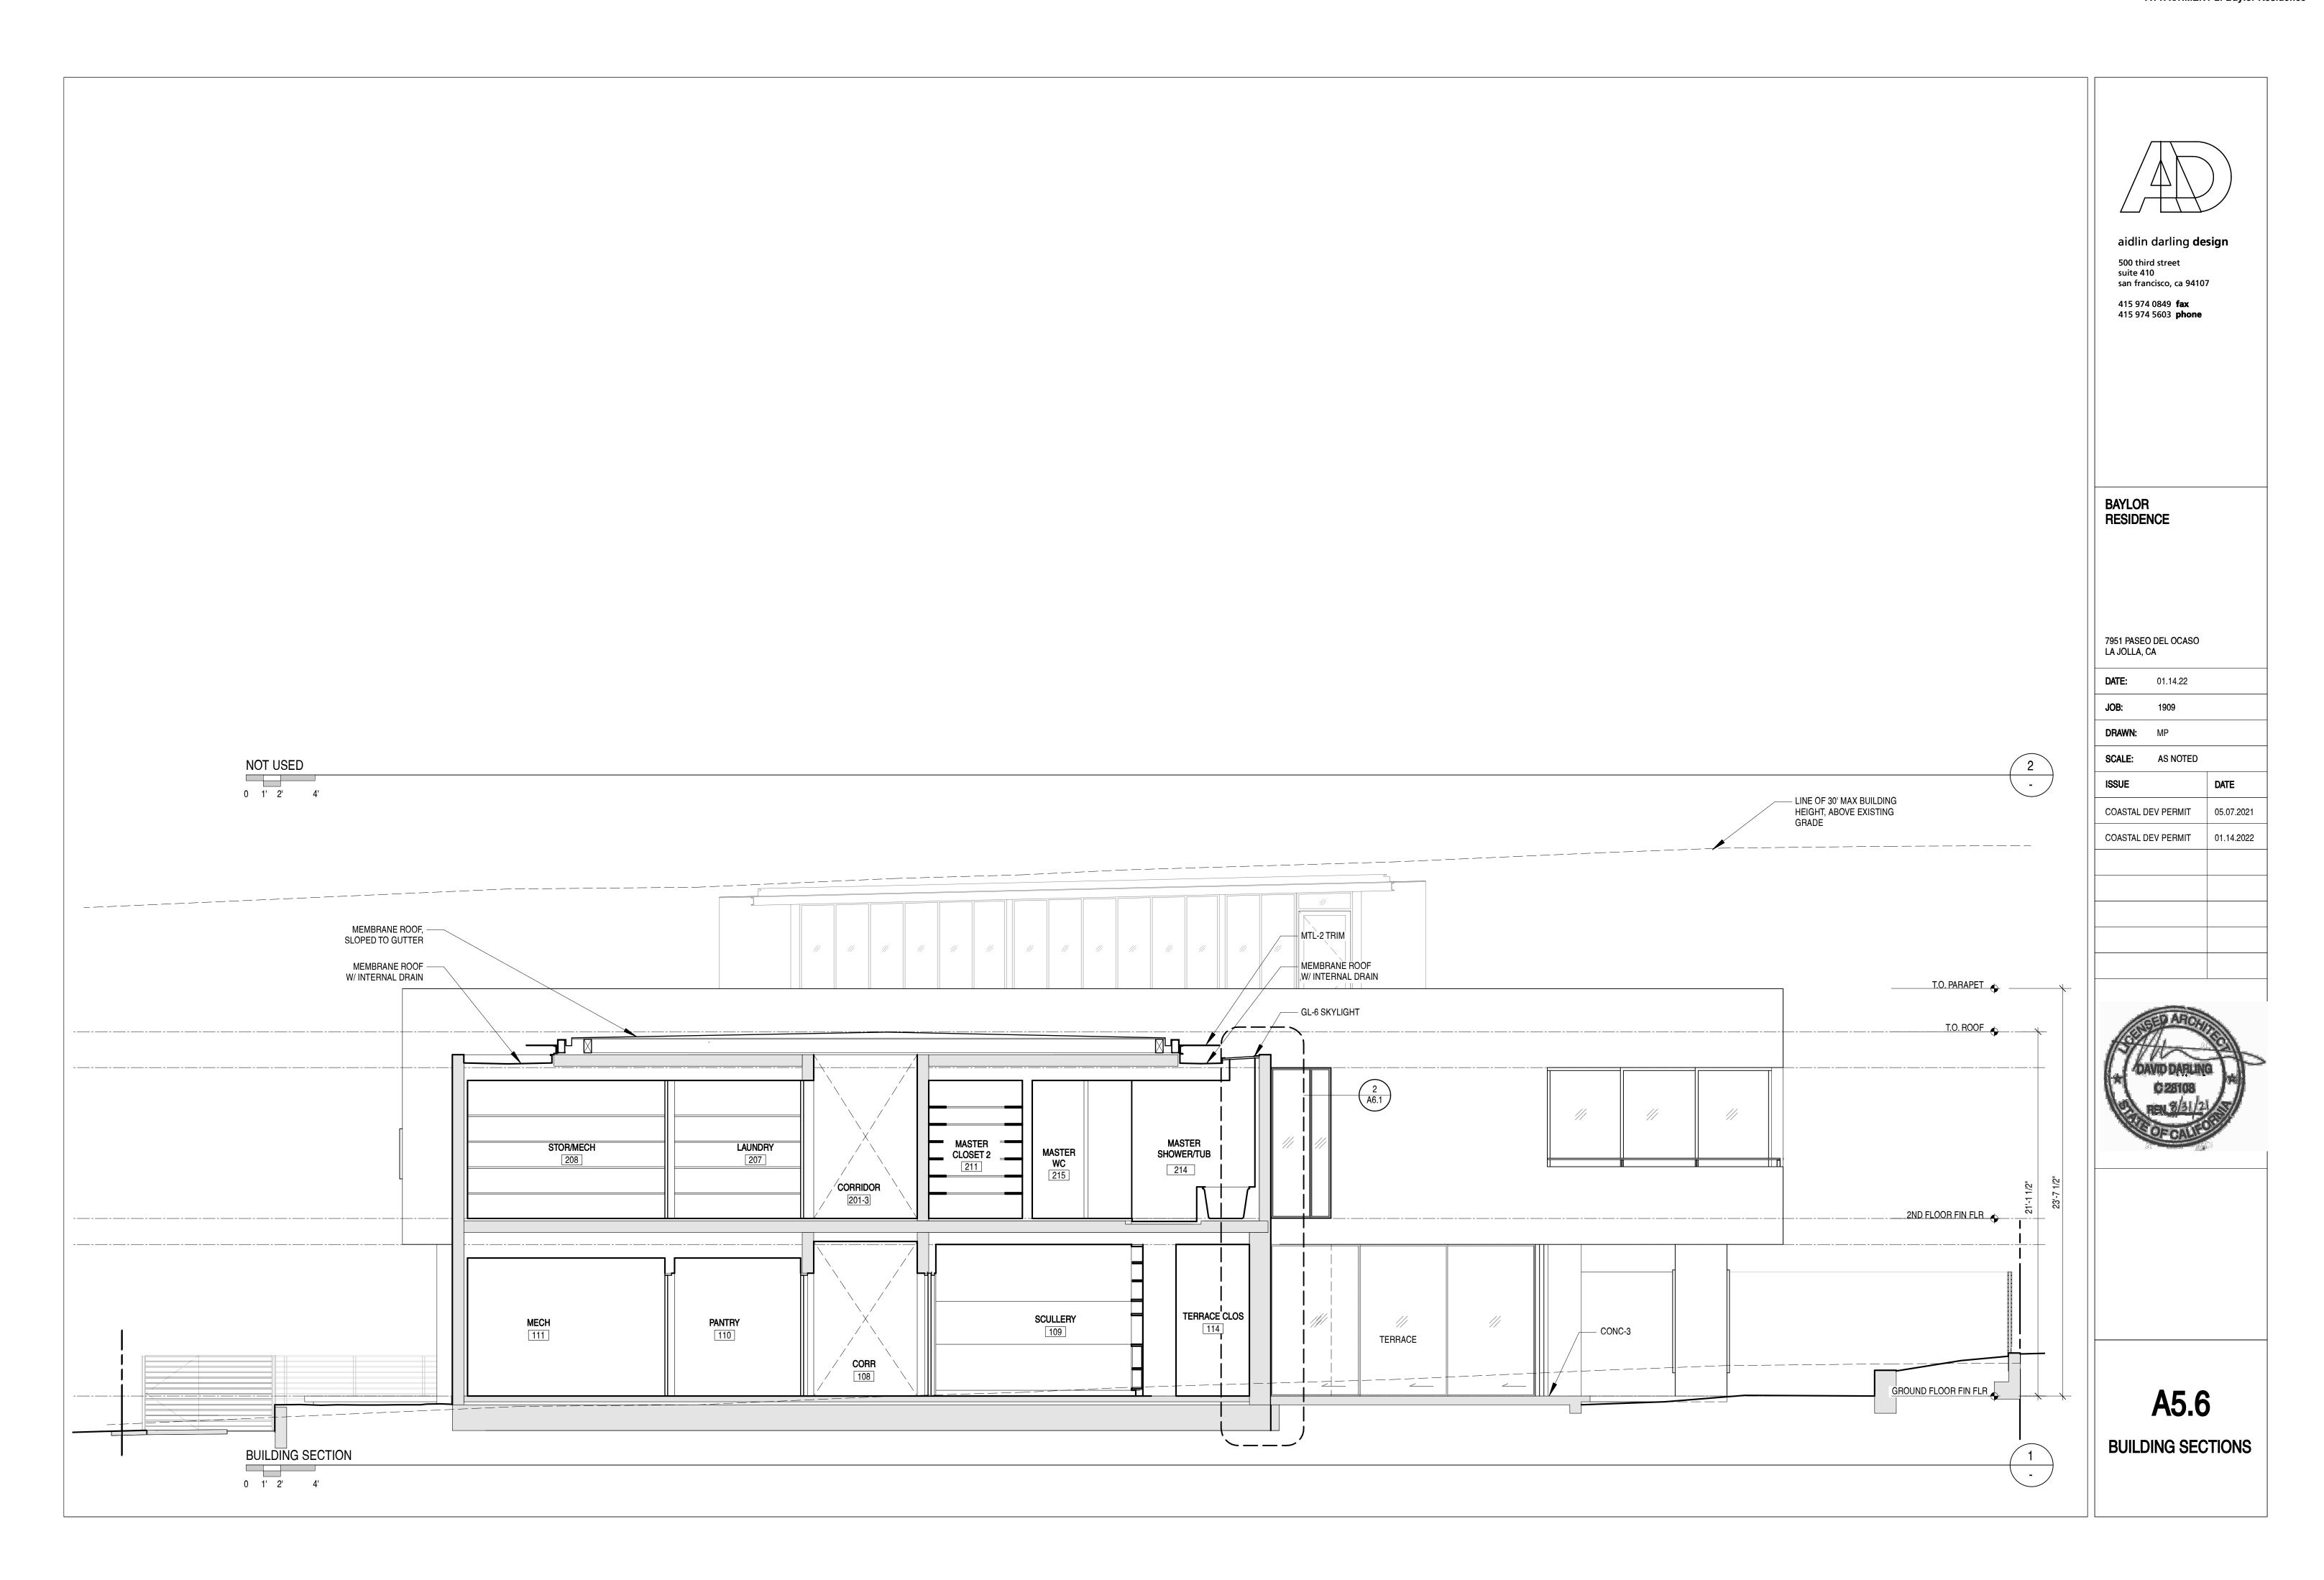

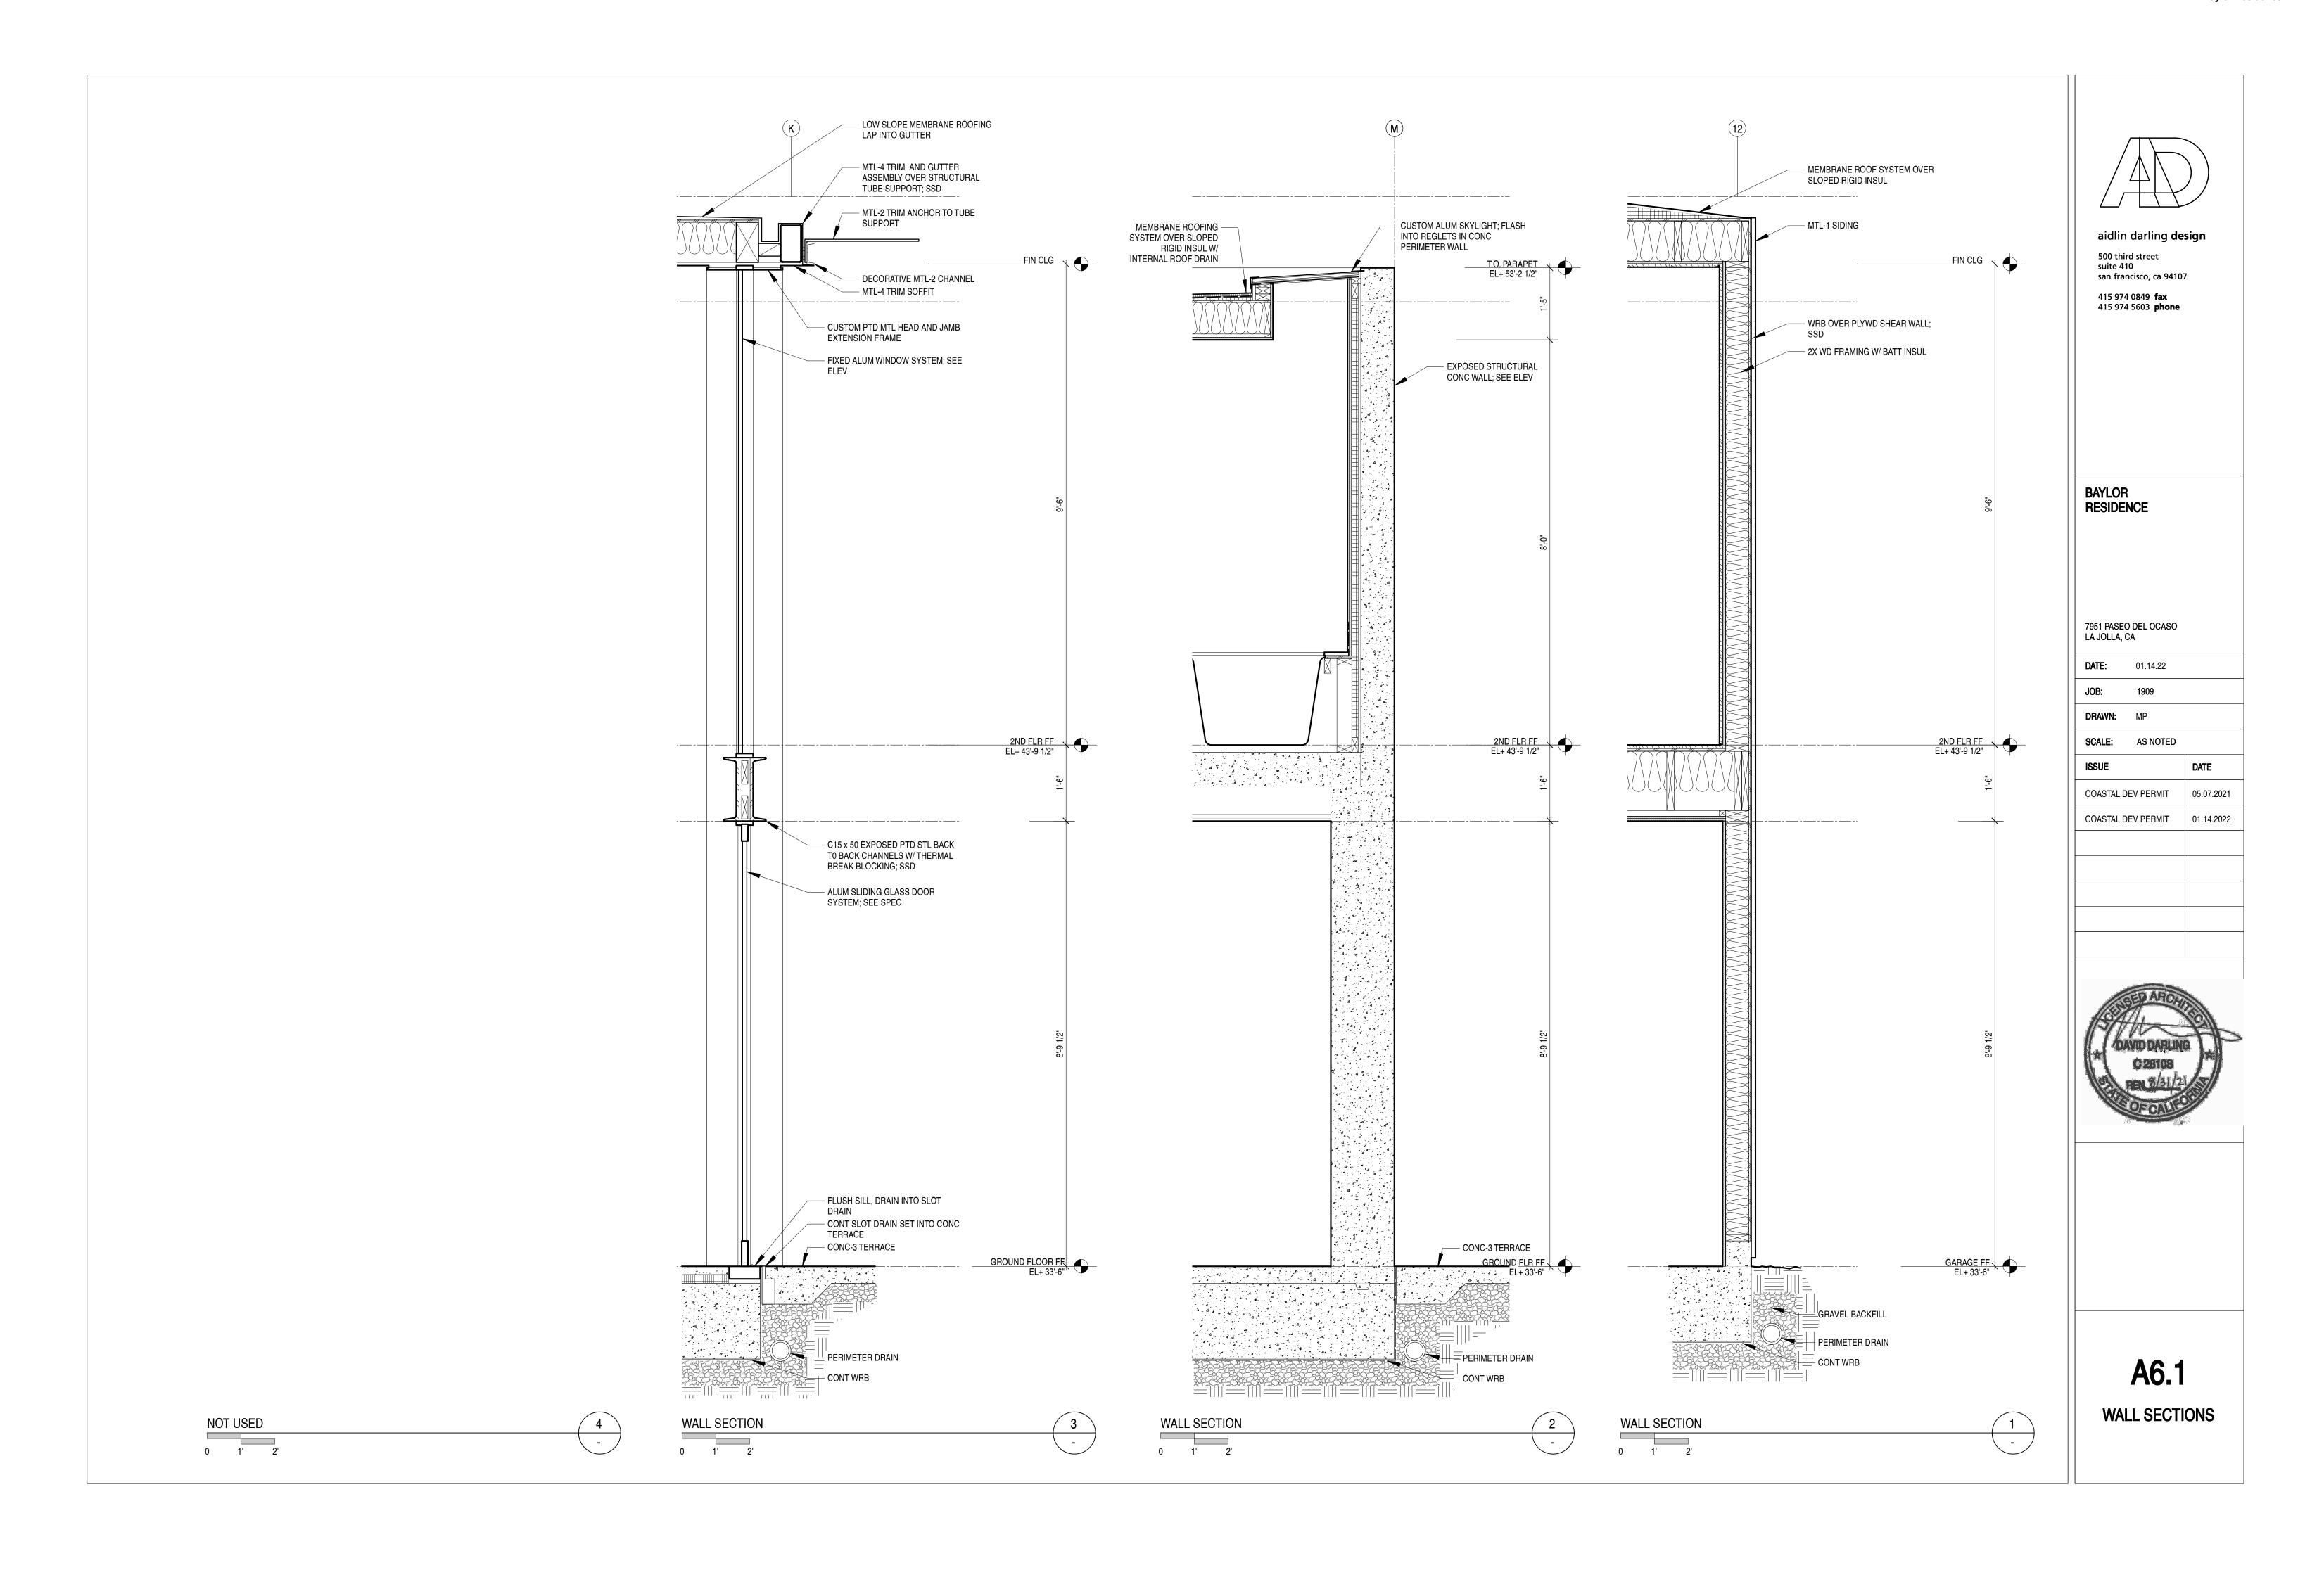

PLANTING SCHEDULE

	sym TREES	botanical name	common name	size	min. qty	notes
ST	small street tree	Lagerstroemia indica 'Natchez'	White Crape myrtle 'Natchez'	24" box	1	Street tree on Paseo de Ocaso WUCOLS = M
	sculptural tree	Arbutus 'Marina'	Marina madrone	36" box	4	Slow-moderate growth to 40' h x 25' w. WUCOLS = L
•		Metrosideros excelsa	New Zealand Christmas tree			Moderate growth to 25' h. x 20' w. WUCOLS = M
	low-branching	Olea europaea 'Fruitless'	Fruitless olive	24" box	3	Slow-moderate growth to 30' h/w, easily pruned to shape/size. WUCOLS = L
	tree	Arbutus unedo	Strawberry tree			Slow-moderate growth to 20' h/w. WUCOLS = L
		Arctostaphylos 'Dr. Hurd'	Dr. Hurd tree manzanita			Moderate growth to 12' h x 10' w. WUCOLS = L
		Grevillea 'Moonlight'	Moonlight grevillea			Fast growth to 10' h/w. WUCOLS = L
		Leptospermum laevigatum	Australian tea tree			Moderate growth to 15' h/w. WUCOLS = L
	accent tree in shade			36" box	1	
	Silve	Acer palmatum	Japanese maple			Moderate growth to 20' h x 15' w. WUCOLS = M
		Cercis canadensis var. texensis 'Texas White'	Texas white redbud			Moderate growth to 15' h x 10' w. WUCOLS = M
	SHRUBS vertical evergreen			15 gal.	60	
	screening shrub	Azara microphylla	Boxleaf azara	13 gai.		Fast growth to 20' h x 8' w. WUCOLS = M
+		Elaeocarpus decipiens	Japanese blueberry			Moderate-fast growth to 30' h x 15' w WUCOLS = M
		Laurus nobilis	Sweet bay laurel			Slow-moderate growth to 20' h x 15' w. WUCOLS = L
	low shrub	Rhamnus alaternus	Italian buckthorn	5 gal.	45	Moderate-fast growth to 15-20' h. WUCOLS = L
		Acacia cognata 'Cousin Itt'	Little river wattle			Moderate growth to 2-3' h and spreading. WUCOLS = M
		Arctostaphylos 'lan Bush'	lan Bush manzanita			Fast growth to 4-5' h/w. WUCOLS = L
		Laurus 'Little Ragu'	Dwarf bay laurel			Moderate growth to 7' h/w. Prune as needed. WUCOLS = L
		Mahonia eurybrachteata 'Soft Caress'	'Soft Caress' Oregon grape			Moderate growth to 3' h/w. WUCOLS = unknown (Sunset/UC Master Gardeners = L)
		Olea 'Little Ollie'	Dwarf olive			Moderate growth to 5' h/w. WUCOLS = L
	gracestation	Rosmarinus 'Lady in White'	White rosemary	11	75	Moderate growth to 2' h x 3' w. WUCOLS = L
	grasses/perennials	Libertia peregrinans	New Zealand Iris	1 gal.	75	Grows to 2" h/w. WUCOLS = M
		Lomandra longfolia 'Baby Breeze'	Dwarf mat rush			Grows 18" h/w. WUCOLS = L
=		Lomandra longifolia 'Breeze'	Breeze mat rush			Grows 2-3' h/w. WUCOLS = L
		Lomandra longfolia	Steely Slim mat rush			Grows 1-2' h/w. WUCOLS = L
		'Steely Slim' Sesleria autumnalis	Autumn moor grass			Grows 2-3' h/w. WUCOLS = M
	00011117-7-7	Sesleria 'Greenlee'	Greenlee moor grass			Grows to 18" h/w. WUCOLS = M
	GROUNDCOVER	Arctostaphylos edmundsii 'Carmel	Carmel Sur manzanita	flats		Moderate growth to 6" h x 6' w. WUCOLS = L
******		Sur Carex flacca	Blue sedge			Grows 6-10" h/w. WUCOLS = L
		Laurentia fluviatilis	Blue star creeper			Grows to 3" h. WUCOLS = M
		Mentha requenii	Corsican mint			Grows to 3" h. WUCOLS = M
		Thymus serphyllum	Creeping thyme			Grows to 3" h. WUCOLS = L

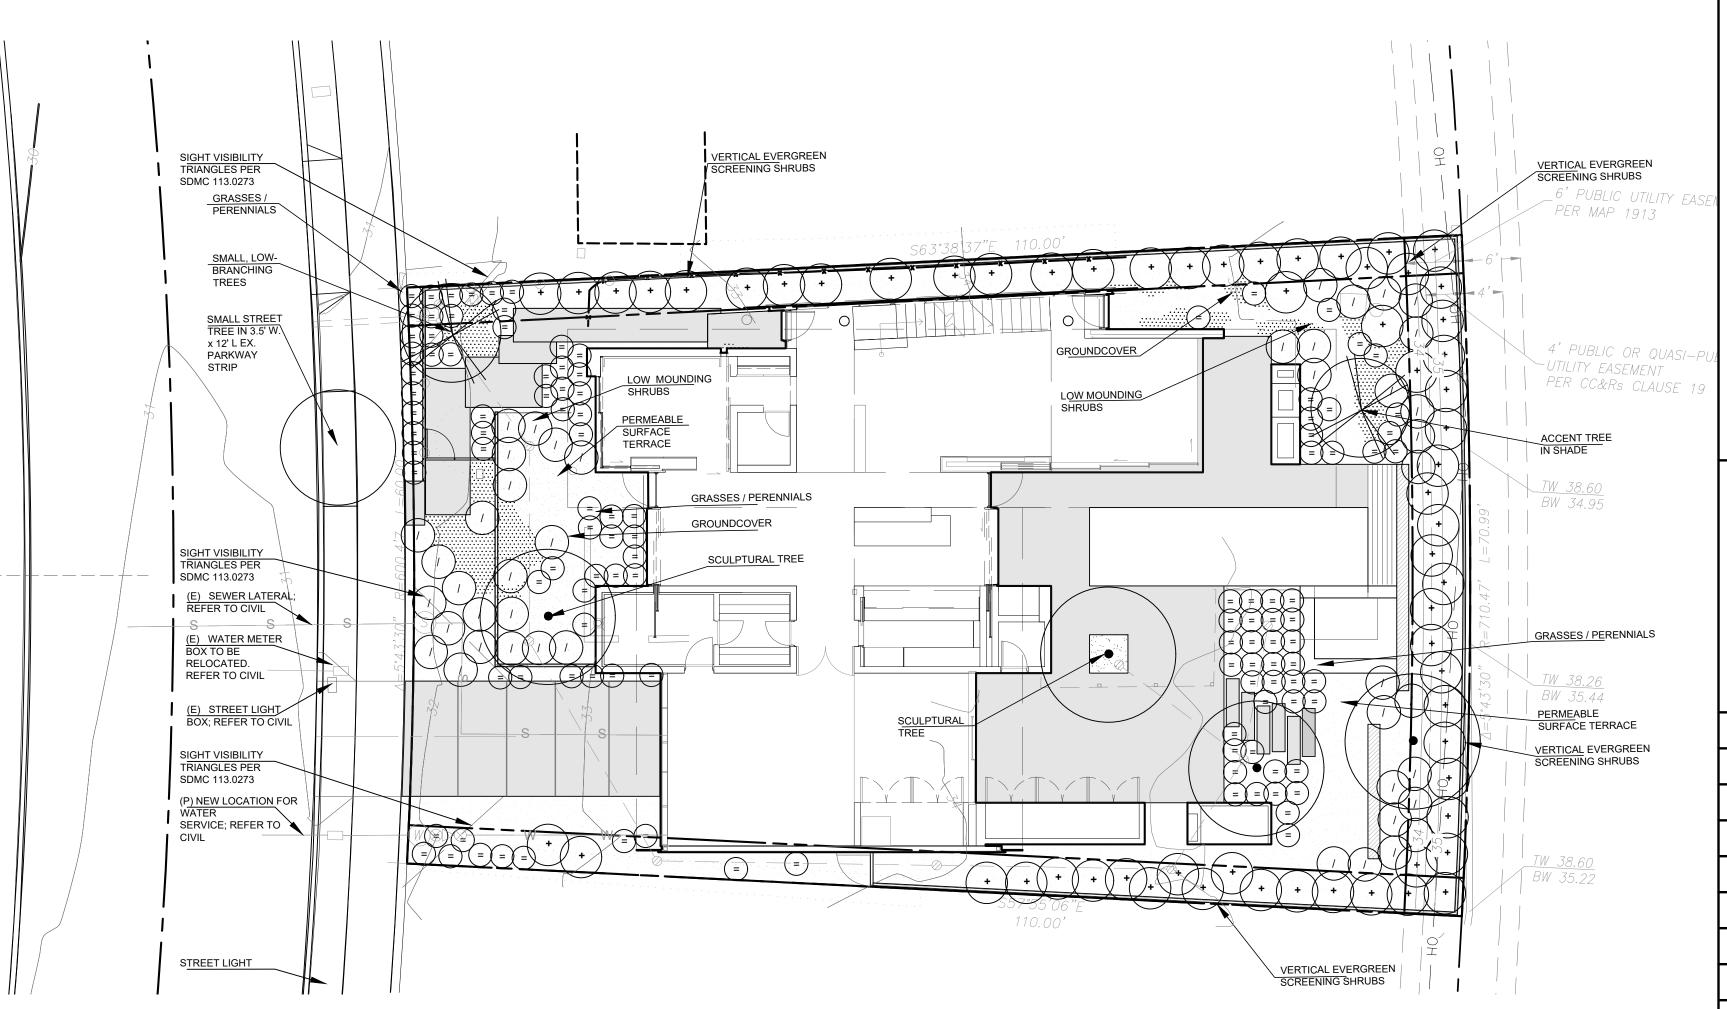

PERCENTAGE OF PLANTS PER SIZES

TREES	36" box	55%
	24" box	45%
SHRUB	S	
	15 gal.	33%
	5 gal.	25%
	1 gal.	42%
GROUN	NDCOVER	
	Flats	100%



aidlin darling design 500 third street suite 410 san francisco, ca 94107 415 974 0849 fax 415 974 5603 phone

BAYLOR RESIDENCE

7951 PASEO DEL OCASO LA JOLLA, CA

DATE: 16 August 2020 JOB: 1909

DRAWN:

SCALE: AS NOTED ISSUE DATE

CDP SUBMITTAL 0507202 CDP SUBMITTAL 01172022

PRELIMINARY ONLY NOT FOR CONSTRUCTION





aerea landscape architecture

LESLIE A. RYAN Landscape Architect PLA 6225

Signature

5

PLANTING PLAN AND LEGEND

1" = 10'-0" PLANTING PLAN

0 10'

PLANTING NOTES

Per the La Jolla Shores Planned District Ordinance and City of San Diego Landscape Regulations

- 1. In the Single-Family Zone, all of the property not used or occupied by structures, unplanted recreational areas, walks and driveways shall be landscaped and may include native materials, and in no case shall this landscaped area be less than 30 percent of the total parcel area. All landscaping and irrigation shall be developed in conformance with the Landscape Guidelines of the Land Development Manual.
- 2. All landscaping shall be completed within 6 months of occupancy or within one year of the notice of completion of a residence.
- 3. All landscaped material shall be permanently maintained in a growing and healthy condition including trimming as appropriate to the landscaping material.
- 4. The Water Use Classification of Landscape Species (WUCOLS) is included for all plant species. A minimum of 75% of plant species will be climate-adapted requiring little or no summer water and with an average plant factor of 0.3.
- 5. No turf or high-water use plant species are proposed.
- 6. All required planting areas and all exposed soil areas without vegetation shall be covered with mulch to a minimum depth of 3 inches, excluding slopes.
- 7. No known invasive species are proposed.
- 8. Plant material, other than trees, located within *visibility areas* or the adjacent *public right-of-way* shall not exceed 36 inches in height.
- 9. All pruning shall comply with the standards of the American National Standards Institute (ANSI) for tree care operations and the International Society of Arboriculture (ISA) for tree pruning. Topping of trees is not permitted.
- 10. All landscape and irrigation shall conform to the standards of the City-Wide Landscape Regulations and the City of San Diego Land Development Manual Landscape Standards and all other landscape related City and Regional Standards.
- 11. If any required landscape indicated on the approved construction document plans is damaged or removed, it shall be repaired and/or replaced in kind and equivalent size per the approved documents to the satisfaction of the Development Services Department within 30 days of damage.
- 12. An automatic, electrically controlled irrigation system shall be provided as required by LDC §142.0403(c) for proper irrigation, development, and maintenance of the vegetation in a healthy, disease-resistant condition. The design of the system shall provide adequate support for the vegetation selected.

- 1. One (1) street tree is proposed. Curbcuts and clearance for utilities reduce linear feet of street frontage to 30 LF.
- 2. Existing parkway strip is 3.5' wide and surfaced with brick paving. Street tree shall be selected from approved street tree list for parkways between 2'-4' wide.
- 3. A minimum root zone of 40sf in area shall be provided for all trees. The minimum distance for this area shall be 5 feet, per SDMC §142.0403(b)(5)
- 4. Trees shall be maintained so that all branches over pedestrian walkways are 6 feet above the walkway grade and branches over vehicular travel ways are 16 feet above grade of the travel way per San Diego Municipal Code, Section 142.0403(b)(10).
- 5. Tree root barriers shall be installed where trees are placed within 5 feet of public improvements including walks, curbs, or street pavements or where new public improvements are placed adjacent to existing trees. Contractor shall install root barriers adjacent and parallel to edge of paving or site improvement, and not encircling the root ball.

General notes


- 1. All planting operations shall conform to City of San Diego codes and guidelines, and any other applicable local, state, or federal codes and regulations.
- 2. Contractor is to call DigAlert (800 422-4133) and verify locations both above and below ground of existing utilities, pipes, drainlines and structures prior to any excavation or planting work.
- 3. Final finish grades shall insure positive drainage of the site, with all surface drainage directed away from buildings, walls, or other site improvements, and toward drains and inlets or other areas specified to receive and infiltrate drainage.

Long Term Maintenance Responsibility

- 1. Maintenance: All required landscape areas shall be maintained by the Owner. Landscape and irrigation areas in the public right-of-way shall be maintained by the Owner. The landscape areas shall be maintained free of debris and litter, and all plant material shall be maintained in a healthy growing condition. Diseased or dead plant material shall be satisfactorily treated or replaced per the conditions of the permit.
- 2. All planting areas will be maintained in a weed and debris free condition.

Minimum Tree Separation

Improvement/Minimum Distance to Street Tree Traffic Signals (Stop Sign) - 20 Feet Underground Utility Lines - 5 Feet (10' For Sewer) Above Ground Utility Structures - 10 Feet Driveway (Entries) - 10 Feet Intersections (Intersecting Curb Lines Of Two Streets) - 25 Feet Fire Hydrant (10' min.)

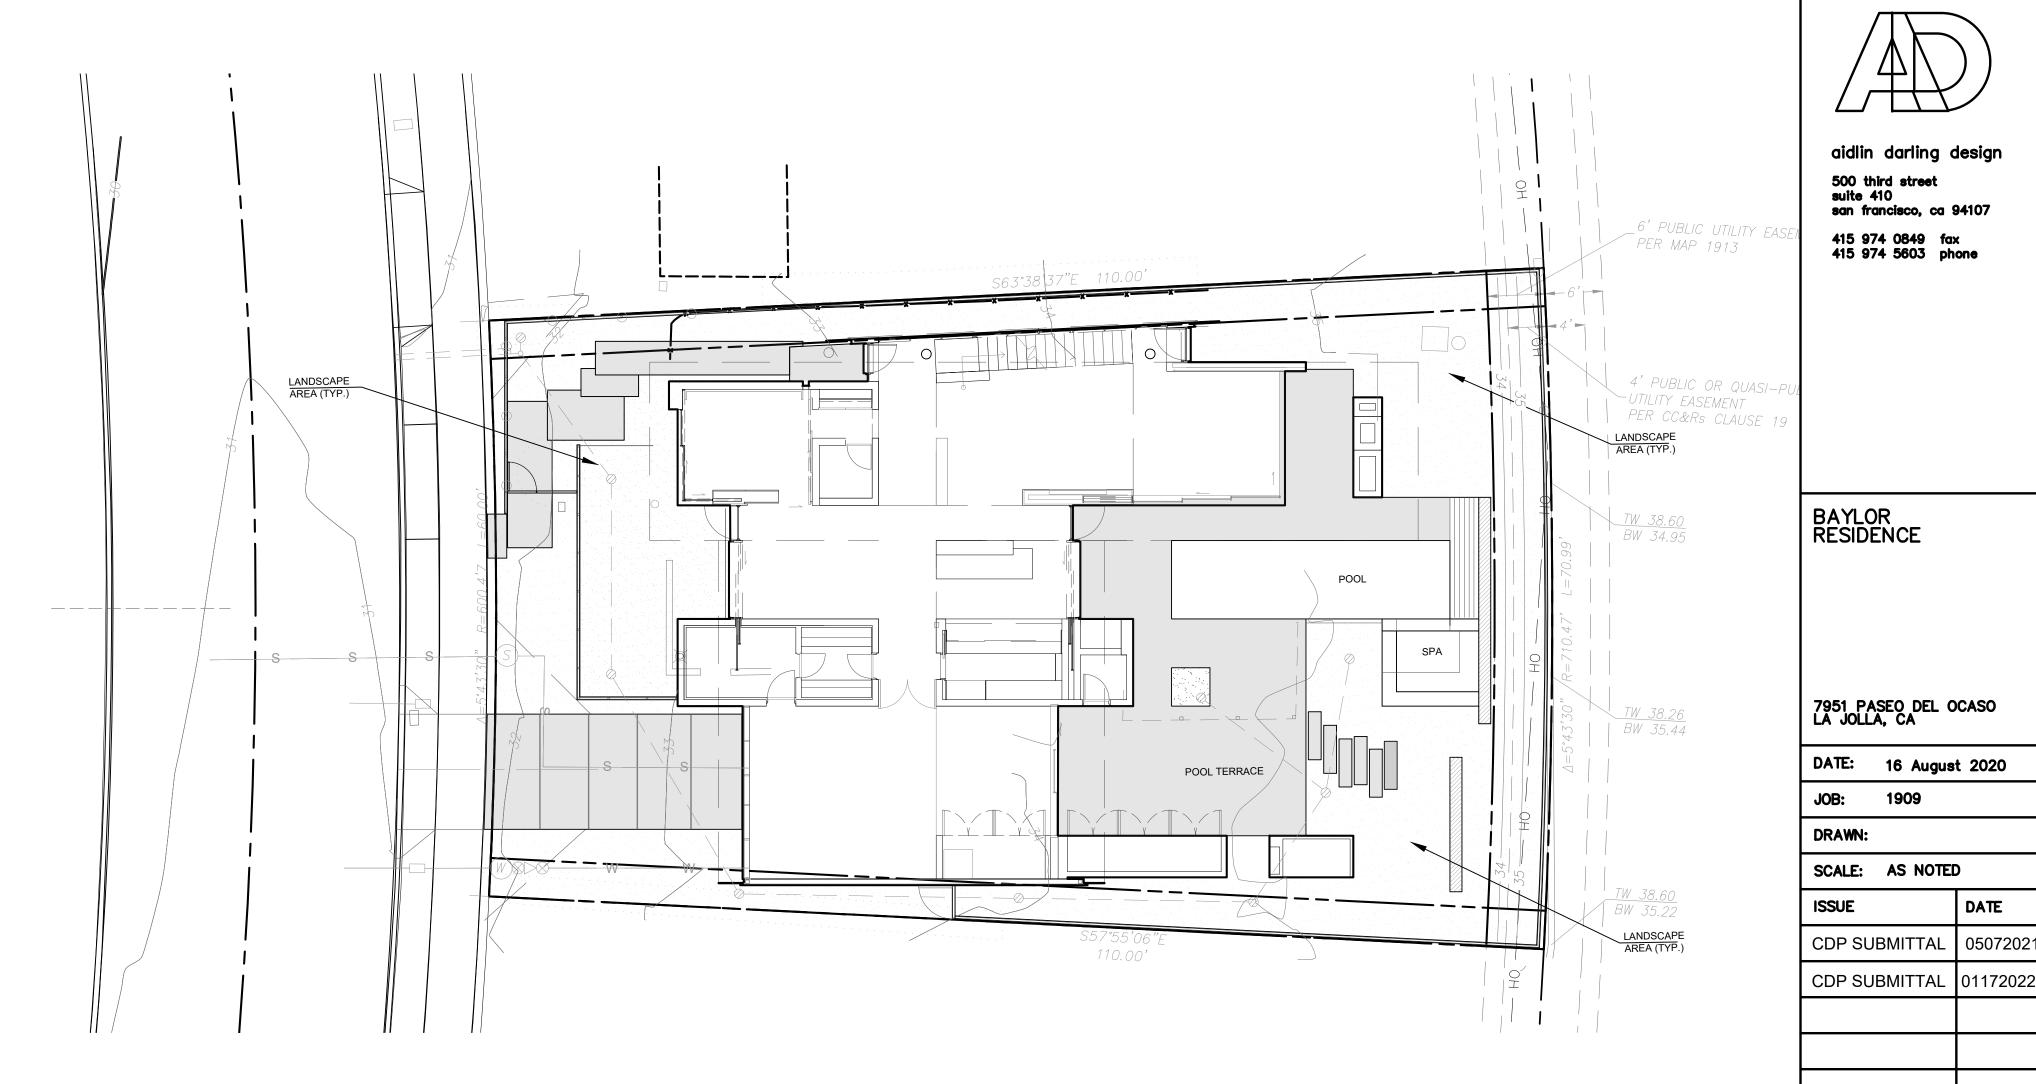

LANDSCAPE AREA CALCULATION

PROPERTY ZONE LJSPD-SF REQUIREMENT 30% LANDSCAPE AREA LOT AREA 7,205 SF 2,161 SF MIN. LANDSCAPE AREA REQ'D LANDSCAPE AREA PROVIDED (WITHIN PROPERTY, 2,584 SF INCLUDING PERVIOUS SURFACES) LANDSCAPE AREA PERCENTAGE (WITHIN PROPERTY) 35.8%

1. NOT INCLUDED IN CALCULATIONS ARE DRIVEWAYS, WALKWAYS, AND OTHER HARDSCAPE ELEMENTS PER SDMC 1510.0301(h)(1) 2. THERE IS AN ADDITIONAL 76 SQUARE FEET OF PROPOSED LANDSCAPED AREA THAT IS

WITHIN THE PUBLIC RIGHT-OF-WAY THAT IS INCLUDED IN THE HYDROZONE CALCULATIONS


PRELIMINARY ONLY NOT FOR

CONSTRUCTION

DATE

aerea landscape architecture LESLIE A. RYAN Landscape Architect PLA 6225 leslie@aerea-studio.com 619.200.8297



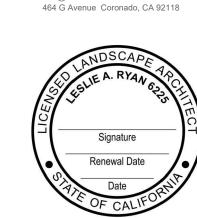

5

PLANTING NOTES

1" = 10'-0"

aidlin darling design

san francisco, ca 94107

415 974 0849 fax 415 974 5603 phone

500 third street suite 410

BAYLOR RESIDENCE

7951 PASEO DEL OCASO LA JOLLA, CA

DATE: 16 August 2020

JOB: 1909

SCALE: AS NOTED


CDP SUBMITTAL 0507202

CDP SUBMITTAL 01172022

DATE

DRAWN:

ISSUE

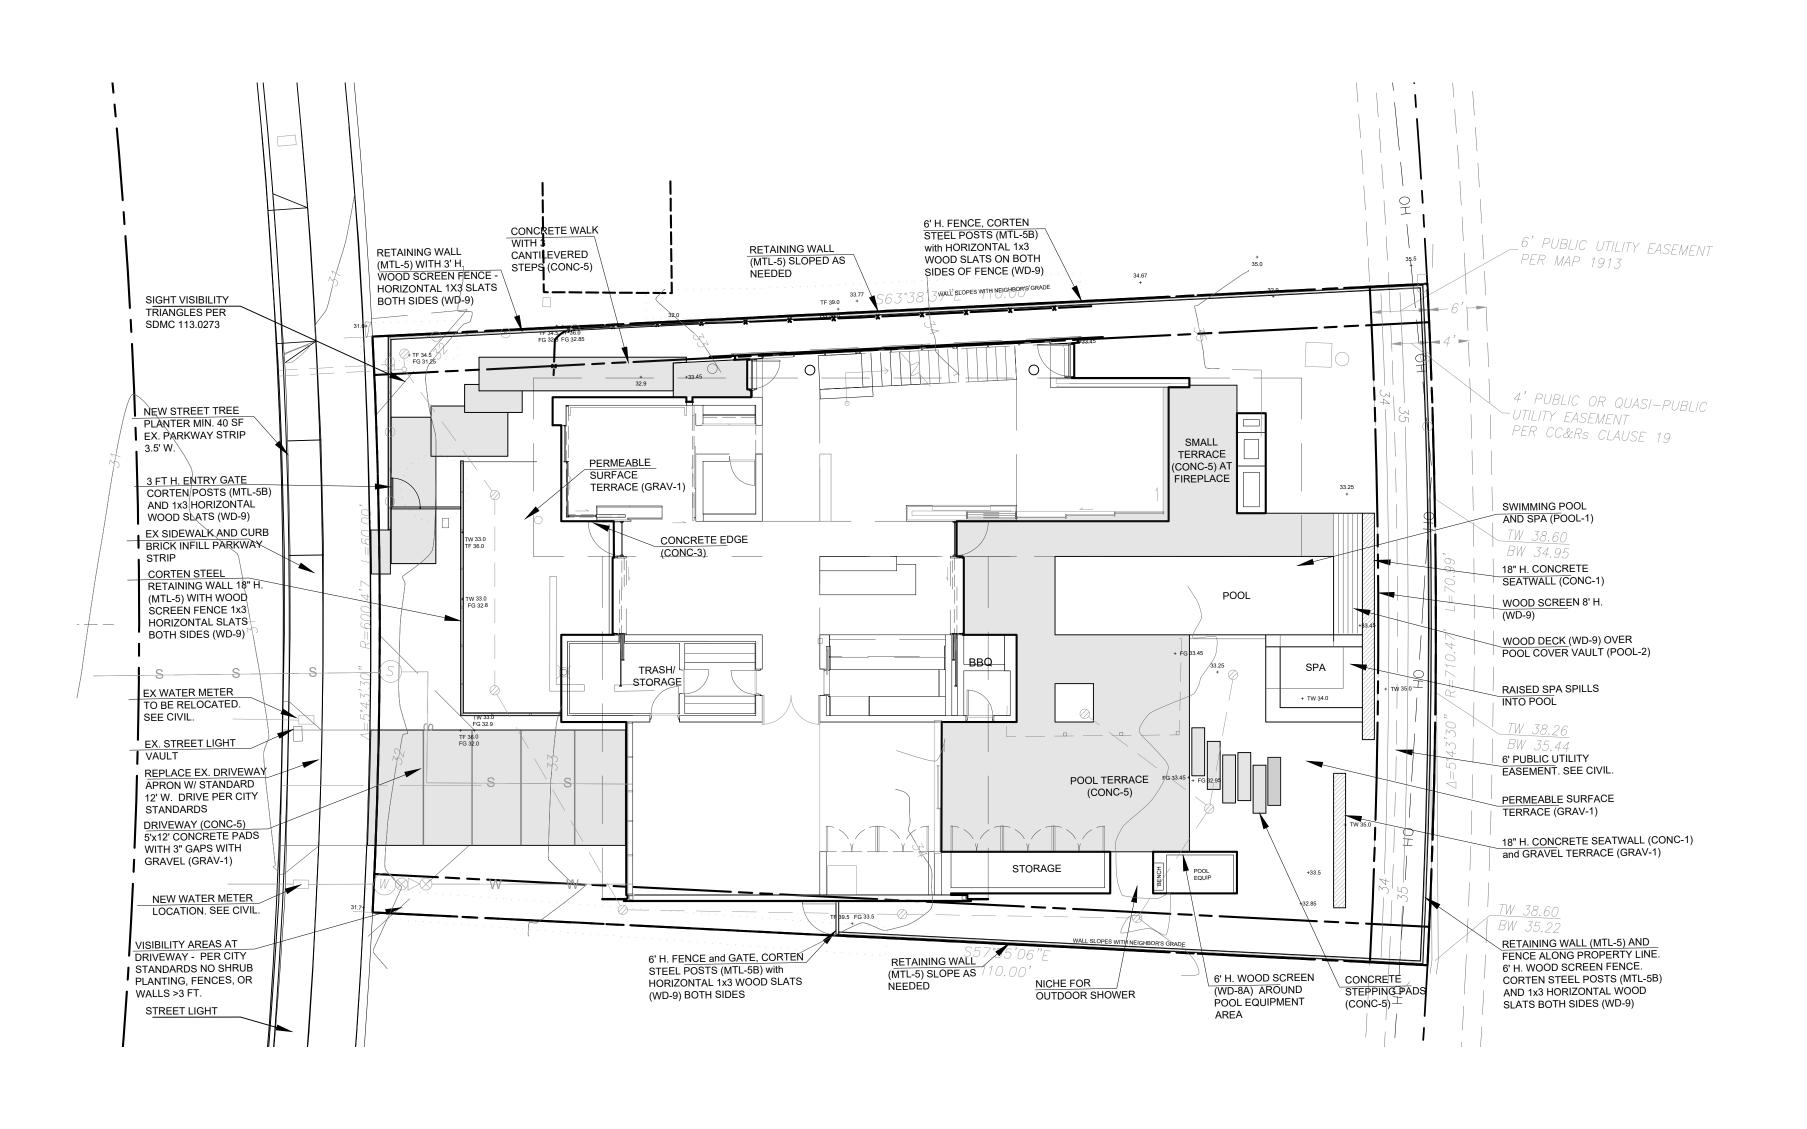

HARDSCAPE FINISH LEGEND

symbol	material	finish		
CONC-3	CONCRETE SLAB	EXTERIOR EXPOSED STRUCTURAL CONCRETE SLAB		
CONC-5	CONCRETE PAVERS, STEPS, and POOL COPING	CAST IN PLACE EXTERIOR CONCRETE		
GRAV-1	GRAVEL WALKING SURFACE	'DEL RIO' 3/8" GRAVEL		
MTL-5 COR-TEN PLATE		LANDSCAPE RETAINING EDGING WITH CONCRET FOOTING		
MTL-5B	CORTEN TUBE POSTS	FENCE AND GATE POSTS		
POOL-1	POOL AND SPA PLASTER	COLORED PLASTER FINISH POOL AND SPA INTERIOR; WATERLINE TILE		
POOL-2	POOL COVER	AUTOMATIC POOL COVER IN CONCRETE VAULT WITH WOOD COVER		
WD-8A	EXTERIOR WOOD CLADDING FOR POOL EQUIPMENT SCREEN WALL	WESTERN RED CEDAR ¾" X 3" T&G VERT BOARDS; STAINED FINISH; CONCEALED FASTENERS		
WD-9	WOOD FENCES AND GATES	NUSKU THERMACOR THERMALLY MODIFIED LUMBER, 1X3 HORIZONTAL SLATS. INSTALL WITH KEY PAD ENTRIES		

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PROJECT NORTH


PRELIMINARY ONLY

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HARDSCAPE PLAN AND FINISH LEGEND

HARDSCAPE PLAN AND FINISH LEGEND 1" = 10'-0"

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BAYLOR RESIDENCE

7951 PASEO DEL OCASO LA JOLLA, CA

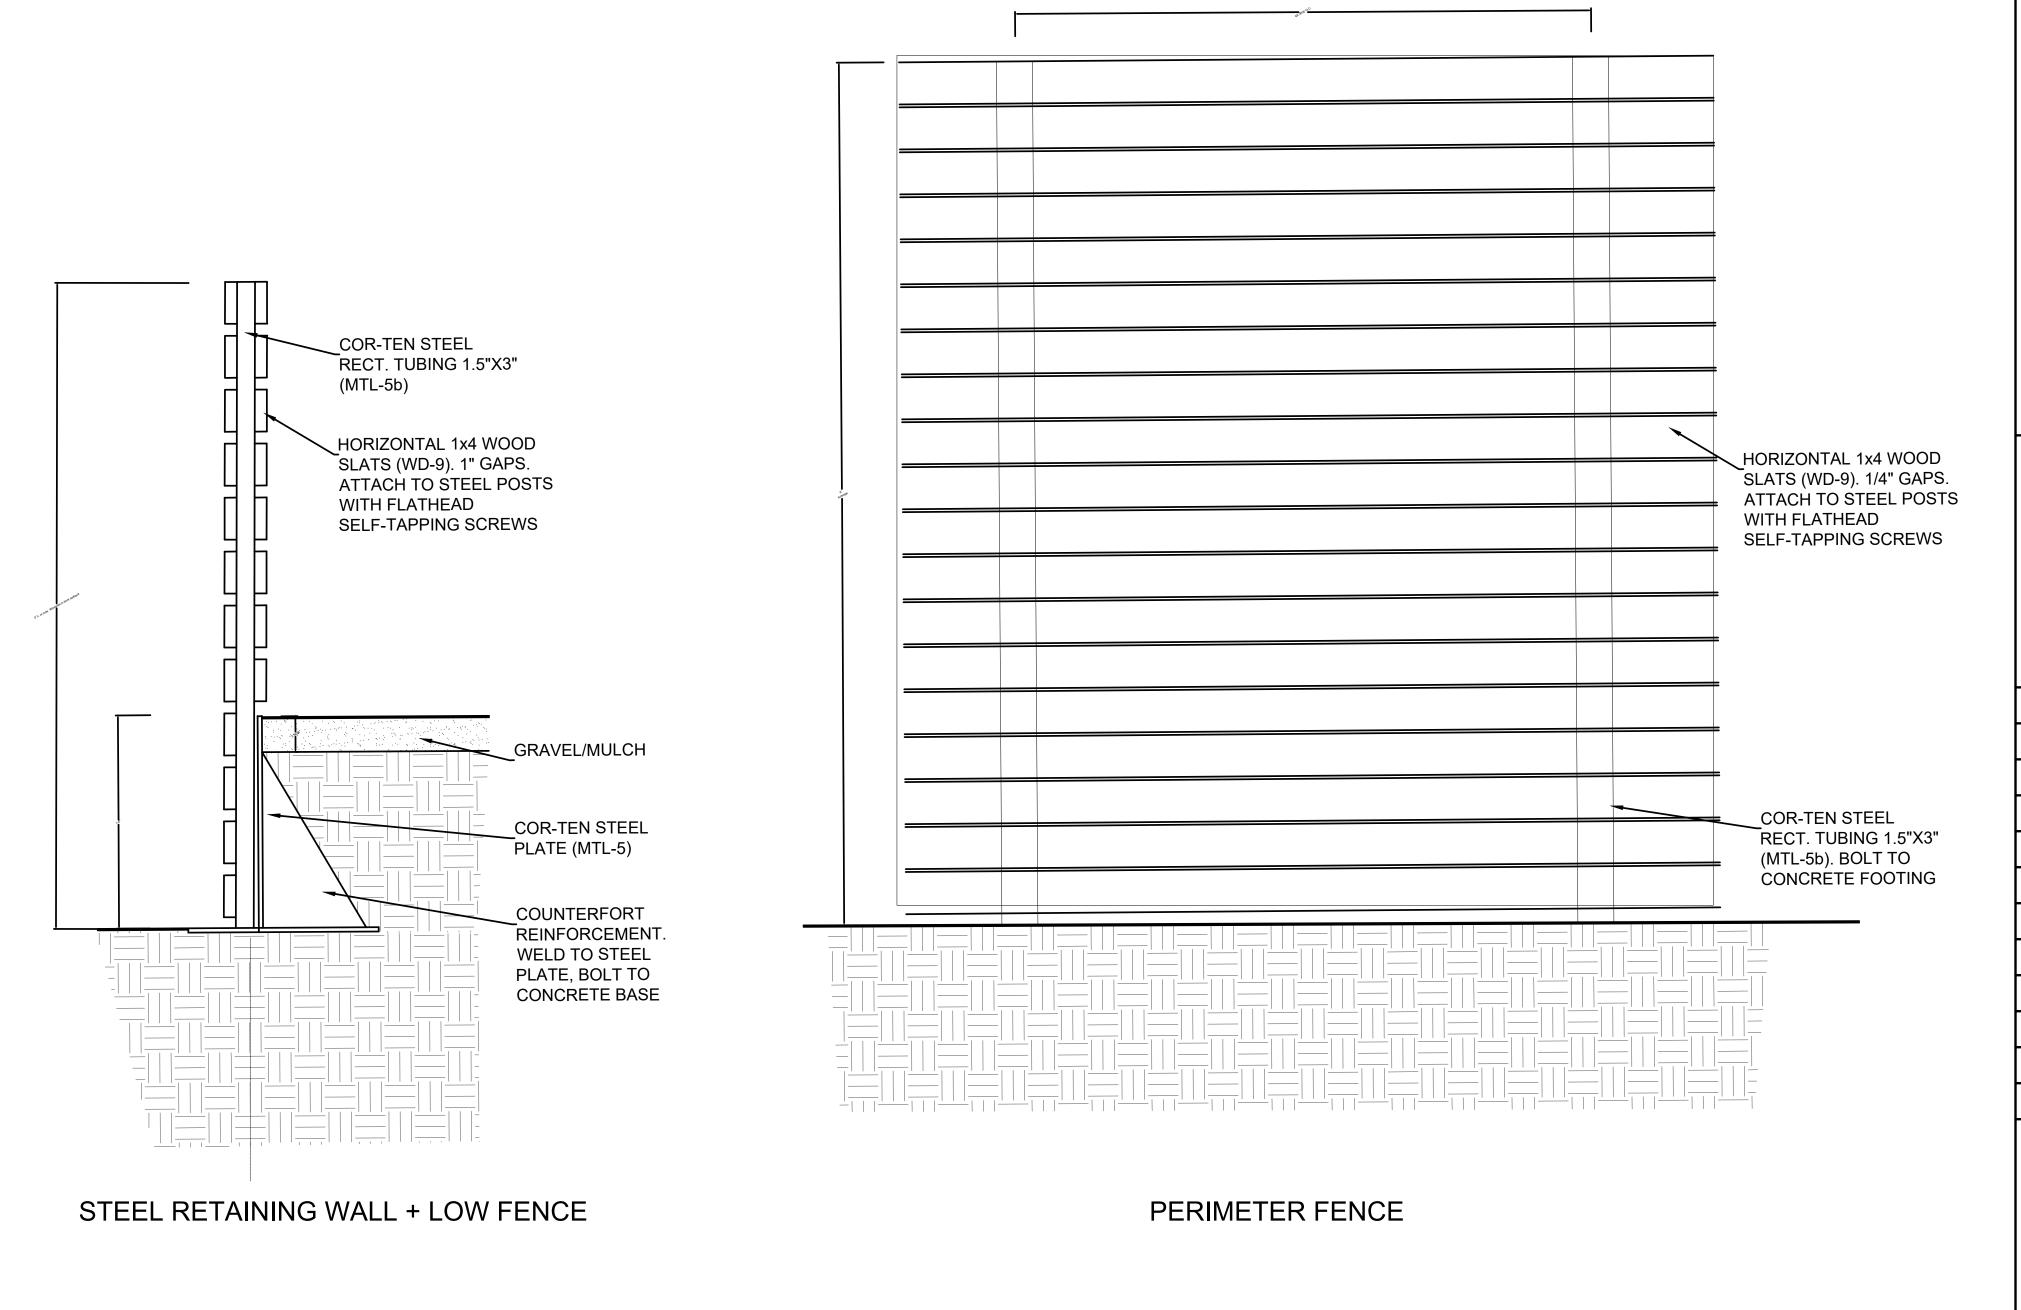DATE: 16 August 2020

JOB: 1909

DRAWN: SCALE: AS NOTED

DATE ISSUE

CDP SUBMITTAL 0507202 CDP SUBMITTAL 01172022

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HARDSCAPE DETAILS

GRAVEL/MULCH **COR-TEN STEEL** PLATE (MTL-5) COUNTERFORT REINFORCEMENT. WELD TO STEEL PLATE, BOLT TO CONCRETE BASE

STEEL RETAINING WALL

1-1/2" = 1'-0"

IRRIGATION and WATER CONSERVATION


- 1. Irrigation use shall not exceed the maximum applied water allowance (MAWA).
- 2. Total site landscape area is 2,660 SF. This square footage excludes all impervious paving, structures, swimming pool and spa. This square footage includes 76 square feet of area within the public right-of-way.
- 3. Reference Evapotranspiration for La Jolla is 40.0 inches/year.
- 4. Maximum Applied Water Allowance (MAWA) = 36,282 gallons/year. Swimming pool and spa are Special Landscape Areas. Calculations: (40.0)(0.62)[.55 x 2660] + (0.45)(308)
- 5. Preliminary Estimated Total Water Use (ETWU) = 32,885 gallons/year.
- Calculations: $(40.0)(0.62)(0.4 \times 2660 / 0.81) + 308$. Using .4 as average Plant Factor. 6. No turf areas or high water use planting areas are proposed.
- 7. Design includes 250 SF of swimming pool to be covered with automatic pool cover and 58 SF of a raised spa.
- 8. The design of the irrigation system shall conform to the hydrozones of the landscape design plan.
- 9. Irrigation shall be controlled with an automatic controller installed with an evapotranspiration or soil moisture sensor using non-volatile memory.
- 10. All planting areas shall be permanently irrigated with low-volume irrigation equipment. 11. Velocity of water in piping shall not exceed five feet per second downstream of water meter. No separate irrigation water meter is proposed.
- 12. Irrigation system shall be designed meet or exceed an average irrigation efficiency of 0.71.
- 13. The irrigation system shall be designed to prevent runoff, low head drainage, overspray, or other similar conditions where irrigation water flows onto non-targeted areas, such as adjacent property, non-irrigated areas, hardscapes, roadways, or structures.
- 14. Areas adjacent to structures, roadways, entries and activity areas will be irrigated with permanent below grade automated systems.
- 15. The irrigation systems will be installed as soon as practical after grading and prior to plant material installation.
- 16. The irrigation schedule shall be developed, managed and evaluated to utilize the minimum amount of water required to maintain plant health, and to minimize system maintenance requirements after installation.
- 17. Household owner will be responsible for maintenance of all landscape irrigation.
- 18. An automatic, electrically controlled irrigation system shall be provided as required by LDC §142.0403(c) for proper irrigation, development, and maintenance of the vegetation in a healthy, disease-resistant condition. The design of the system shall provide adequate support for the vegetation selected.

The landscape design incorporates the following water conservation features:

- The design is based on the general use of plant species that are adapted to a coastal, Mediterranean climate, and the maximization of permeable surfaces.
- The use of climate-adapted plant species reduces the need for fertilization.
- Plants will be grouped together in hydrozones according to their water needs.
- Future maintenance needs are addressed through the planting of drought-tolerant and garden-tolerant native species, and spacing plants to allow room for mature growth. Irrigation system will be regularly inspected.
- Irrigation will be drip, and scheduled to encourage deep rooting and prevent runoff. No overhead sprays or rotors will be specified.
- Mulches will be used in all planting areas.
- No invasive plant species are proposed for planting on this site.

PRELIMINARY ETWU CALCULATIONS

controller	hydrozone #	valve	plant	hydrozone	irrigation	irrigation	% total land.
			factor	SF	method	efficiency	area
1	1 (shrubs)	1	.4	448	drip	0.81	16.8%
1	2 (shrubs)	2	.4	287	drip	0.81	10.8%
1	3 (shrubs)	3	.4	263	drip	0.81	9.9%
1	3 (trees)	4	.4	100	drip	0.81	3.8%
1	4 (shrubs)	5	.4	577	drip	0.81	21.7%
1	4 (trees)	6	.4	60	drip	0.81	2.3%
1	5 (shrubs)	7	.4	540	drip	0.81	20.3%
1	6 (shrubs)	8	.4	385	drip	0.81	14.5%
				2,660 SF			100%
	Special Landscape Area			308 SF			
	(pool/spa)						

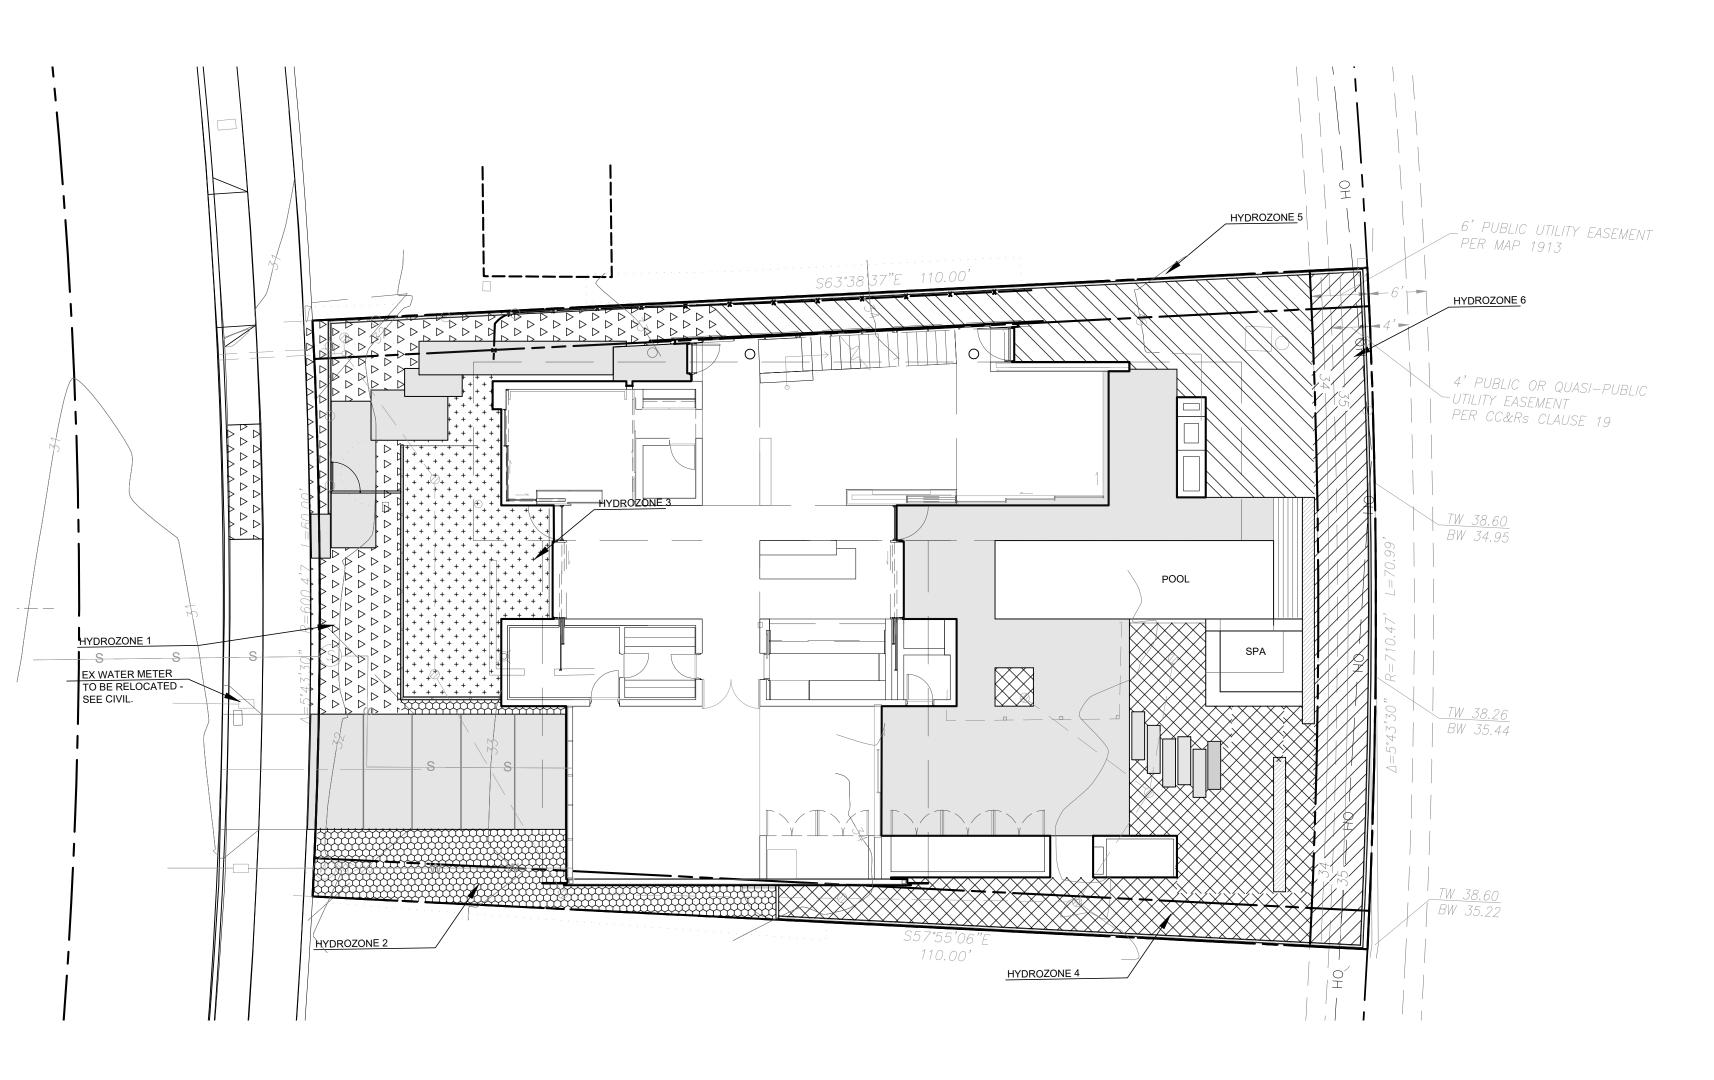

HYDROZONES



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IRRIGATION NOTES

AND HYDROZONES



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